



1 LOACTION PLAN
1" = 40'-0"

GENERAL NOTES:

1. [ALL CONSTRUCTION](#) SHALL CONFORM TO THE FLORIDA BUILDING CODE, 2020 FBC, 7TH EDITION)
2. [ALL EXTERIOR DIMENSIONS](#) ARE TO EXTERIOR FACE OF STUD OR EXTERIOR FACE OF FOUNDATION. ALL INTERIOR DIMENSIONS ARE TO FACE OF STUD PARTITION, UNLESS OTHERWISE NOTED.
3. [FIELD MEASUREMENTS](#) : BEFORE ORDERING ANY MATERIAL OR DOING ANY WORK, EACH CONTRACTOR SHALL VERIFY ALL MEASUREMENTS AT THE BUILDING,
4. [STORAGE OF MATERIALS:](#) ALL MATERIALS SHALL BE STORED IN A NEAT AND ORDERLY MANNER AND THOSE SUBJECT TO WEATHER DAMAGE SHALL BE PROTECTED AGAINST THE WEATHER BY PLACING THEM IN THE BUILDING OR BY OTHER APPROVED PROTECTION.

CONCRETE:

1. [CONCRETE MATERIALS](#) , MIXING, AND WORKMANSHIP SHALL BE IN ACCORDANCE WITH AND SHALL CONFORM TO LATEST EDITIONS OF ACI 301, ACI 318 AND ASTM C-94.
2. [CONCRETE](#) TO BE A MINIMUM OF 3000 PSI IN 28 DAYS, SLUMP RANGE 3" - 5". ALL WORK SHALL BE IN ACCORDANCE WITH "SPECIFICATIONS FOR STRUCTURAL CONCRETE BUILDINGS", ACI-30166.

FINISHES:

1. [GYPSUM DRYWALL:](#) STANDARD C 840, ASTM C36, LONG EDGES STANDARD TAPER, THICKNESS 1/2". PROVIDE MANUFACTURER'S STANDARD METAL TRIM ACCESSORIES. JOINT
2. [PAINTING:](#) SUBMIT COLOR CHIPS TO OWNER. PERFORM PREPARATION AND CLEANING PROCEDURES IN STRICT ACCORDANCE WITH PAINT MANUFACTURER'S INSTRUCTIONS FOR EACH SUBSTRATE CONDITION. USE ONLY NO VOC PAINTS, STAINS AND FINISHES. MIX, PREPARE, STORE AND APPLY PAINTING AND FINISH MATERIALS IN ACCORDANCE WITH MANUFACTURER'S DIRECTIONS. PROVIDE A TOTAL DRY FILM THICKNESS OF NOT LESS THAN 2.5 MILS FOR 2 COAT WORK. PAINT ALL INTERIOR WALLS AND CEILINGS. PAINT ALL EXTERIOR WALLS, SOFFITS, FASCIA, AND WOOD TRIM.
3. [PLASTER INSTALLATION:](#) PORTLAND CEMENT BASED STUCCO SHALL MEET THE REQUIREMENTS OF ASTM STANDARD , C1063, C932. ALL SHEATHING BENEATH STUCCO SHOULD HAVE 1/8" GAP BETWEEN PANELS. PROVIDE 3-COAT WORK ON METAL LATH AND REINFORCEMENT WITH MIN. THICKNESS OF 7/8" OVER WOOD CONSTRUCTION. PROVIDE 2-COAT WORK ON MASONRY AND CONCRETE WITH MIN. THICKNESS OF 5/8". PLASTER OVER WOOD CONSTRUCTION SHOULD HAVE MINIMUM OF 2 LAYER SATURATED FELT, (OR ONE LAYER BUILDING WRAP, E.G., TYVEK, ONE LAYER FELT). CONTROL JOINTS (METAL OR PLASTIC) SHOULD BE APPLIED TO FORM PANELS NOT GREATER THAN 144 SQ. FT.. ALL METAL LATH PANELS SHOULD END AT CONTROL JOINTS AND NOT "RUN" CONTINUOUS THROUGH THE JOINT. ALL JOINTS, REVEALS AND OTHER ACCESSORIES MUST BE CAULKED AT ENDS, BUTT JOINTS AND INTERSECTIONS, TO INSTALLATION OF CEMENT PLASTER. PROVIDE CORNER BEAD AT ALL BUILDING CORNERS THAT DO NOT RECEIVE BOARD SIDING.

INTERIOR WORK AT:
DAYS INN OF OCALA
3811 NW BLICHTON RD.
OCALA, FLORIDA 34475

SHEET LIST	
SHEET NUMBER	SHEET NAME
A-101	COVER
A-102	BUILDING PLAN LAYOUT
A-103	NEW FLOOR PLAN/ PLUMBING PLAN
A-104	DETAILS
A-105	CEILING PLAN
A-106	FLOOR PLAN

FLORIDA CODES & LOADS

JURISDICTION: CITY OF OCALA BUILDING DEPARTMENT
PROJECT NAME: DAYS INN OF OCALA
PROJECT ADDRESS: 3811 NW BLICHTON ROAD 34475
ENGINEER:
TYPE OF CONSTRUCTION: VB
BUILDING DESIGN: ENCLOSED BUILDING
BUILDING CODE: 2020 FLORIDA BUILDING CODE BUILDING 7TH EDITION
PLUMBING CODE: 2020 FLORIDA BUILDING CODE PLUMBING 7TH EDITION
MECHANICAL CODE: 2020 FLORIDA BUILDING CODE MECHANICAL 7TH EDITION
FUEL/GAS CODE: 2020 FLORIDA BUILDING CODE FUEL GAS 7TH EDITION
ENERGY CONSERVATION CODE: 2020 FLORIDA BUILDING CODE ENERGY CONSERVATION 7TH EDITION
ACCESSIBILITY CODE: 2020 FLORIDA BUILDING CODE ACCESSIBILITY 7TH EITION
EXISTING BUILDING CODE: 2020 FLORIDA BUILDING CODE EXISTING BUILDING 7TH EDITION
ELECTRICAL CODE: 2017 NATIONAL ELECTRICAL CODE
ASCE CODE: ASCE 7-16

CLASSIFICATION OF WORK HAS CHANGED TO ALTERATION LEVEL 3

WIND VELOCITY: Vult=140 Vasd=108 MPH (MPH) (3 SECOND GUST)
ALLOWABLE NUMBER OF FLOORS TWO (2)
FLOOR L.L. 40 (P.S.F.) FLOOR D.L. 10 (P.S.F.)
ROOF L.L. 20 (P.S.F.) ROOF D.L. 6+4 B.C. + T.C. (P.S.F.)
OCCUPANCY TYPE: R-1 IMPORTANCE FACTOR: 1.0
EXPOSURE: C INTERNAL PRESSURE COEFFICIENT: +/- 0.18
MEAN BUILDING HEIGHT: EXISTING ROOF PITCH: EXISTING
OVERHANG: EXISTING SHUTTERS: NO
IMPACT RESISTANT ASSEMBLY: NO DESIGN WIND SPEED: CATEGORY 11

THESE PLANS WERE DESIGNED USING THE 2020 FLORIDA BUILDING CODE BUILDING 7TH EDITION, THE 2017 NATIONAL ELECTRIC CODE AND THE 2020 FLORIDA FIRE PREVENTION CODE 7TH EDITION. DUE TO VARIATIONS IN LOCAL CODES AND GEOLOGICAL CONDITIONS, REVISIONS MAY BE REQUIRED TO THESE PLANS. IT IS THE BUILDERS RESPONSIBILITY TO MAKE THE NECESSARY REVISIONS TO ENSURE CODE COMPLIANCE AND STRUCTURAL INTEGRITY.


3 INFORMATION.
1/2" = 1'-0"

WOOD:

1. [GENERAL ROUGH LUMBER](#) (NAILERS, BLOCKING, FURRING AND GROUNDS): #2 YELLOW PINE; CONSTRUCTION GRADE DOUGLAS FIR, PONDEROSA PINE, OR WESTERN HEMLOCK.
2. [FRAMING LUMBER](#) : NOMINAL SIZES INDICATED, DRESSED S4S; CONSTRUCTION GRADE; ANY SPECIES; MOISTURE CONTENT 19% MAXIMUM; MINIMUM EXTREME BENDING FIBER STRESS (FB) 1200 PSI OR AS INDICATED; MINIMUM MODULUS OF ELASTICITY (E) 1,500,000 PSI.
3. [FRAMING, BLOCKING AND NAILERS](#) EXPOSED TO MOISTURE OR DIRECTLY ATTACHED TO MASONRY OR CONCRETE SHALL BE UTILITY GRADE OR BETTER YELLOW PINE, PRESSURE TREATED, PROVIDE 1X 6 P.T. BLOCKING ABOVE ALL WINDOWS AND DOORS, MIN. 8" EACH SIDE OF OPENING, FOR FUTURE WINDOW TREATMENT INSTALLATION. PROVIDE 2 X 6 BLOCKING BEHIND ALL BATHROOM ACCESSORIES AS TOWEL BARS, TOILET PAPER HOLDERS, ETC.

PLUMBING: PER FBC-PLUM (2020)

1. THE PLUMBING CONTRACTOR SHALL FURNISH ALL MATERIALS, LABOR, EQUIPMENT FOR A COMPLETE WORKING SYSTEM, WHICH MEETS OR EXCEEDS ALL APPLICABLE NATIONAL, STATE AND LOCAL ORDINANCES AND CODES.
2. ALL PIPING INSTALLED ON THE JOB SHALL BE HYDRAULICALLY TESTED FOR A MIN. OF 24 HOURS ORDINANCES.
3. ALL PARTS, MATERIALS, EQUIPMENT AND LABOR FURNISHED UNDER THIS SECTION, SHALL BEAR A ONE YEAR, NO COST TO OWNER, WARRANTY FROM DATE OF FINAL ACCEPTANCE. PROVIDE WRITTEN WARRANTIES ALONG WITH MANUFACTURER'S EQUIPMENT WARRANTIES TO OWNER.
4. ALL PLUMBING FIXTURES, FAUCETS, ETC. SHALL BE COORDINATED WITH OWNER FOR DESIGN, STYLE, TYPE, COLOR, ETC.
5. ALL HOT WATER LINES TO BE INSULATED.

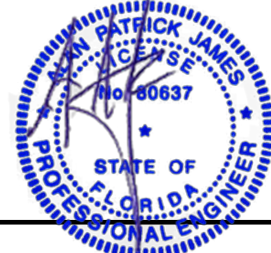

This item has been electronically signed and sealed by Alan Patrick James using a Digital Signature and date. Printed copies of this document with the seal in black and white are not considered signed and sealed and the signature must be verified on any electronic copies.

Alan James, PE #80637
110 DAVINCI DR, NOKOMIS, FLORIDA 34375
AJRARE@COMCAST.NET
941-321-3175

REVISIONS
REV.1 03.31.21
REV.2 08.02.21
REV.3 01.04.22
REV.4 02.07.22

DATE:
3.11.21

SHEET NO.
A-101



2 LOACTION PLAN 2
3/64" = 1'-0"

SCOPE OF WORK

NEW FIRE SPRINKLER SYSTEM SHALL BE INSTALLED SEE PLANS BY FIRE SPRINKLER COMPANY CARPENTRY PHASE:

REMOVE 8' X 8' SLIDING GLASS DOORS IN ROOMS LISTED ON DRAWING



REFRAME SECOND FLOOR OPENINGS TO ALLOW FOR INSTALLATION OF 3068 METAL EXTERIOR DOOR , THRESHOLD, AND 3' X 5' METAL FRAMED INSULATED WINDOW

REFRAME FIRST FLOOR OPENINGS TO ALLOW FOR INSTALLATION OF 3' X 5' METAL FRAMED INSULATED WINDOW ONLY.

REMOVE EXISTING EXTERIOR WALK DOOR IN FIRST FLOOR ROOMS LISTED AND CLOSE OPENING.


ALL FRAMING TO UTILIZE 2" X 6" WOOD STUDS SPACED 16" O.C. WITH PT MATERIAL USED WHERE IN CONTACT WITH EXISTING MASONRY WALLS. TO HAVE PT BOTTEM PLATE AND DOUBLE TOP PLATES

NEW ADA RESTROOMS TO HAVE EXISTING INTERIOR WALLS REMOVED AND REPLACED WITH NEW WOOD FRAMING WITH STUDS SPACED 16" O.C. WITH PT PLATE AND DOUBLE TOP PLATE AS SHOWN. WALLS TO HAVE 5/8" DRYWALL WITH WOOD BASE AND TRIM NEW DOORS TO BE OUTSWING 3068 ADA FIXTURES TO BE INSTALLED AS SHOWN FOR CODE COMPLIANCE.,

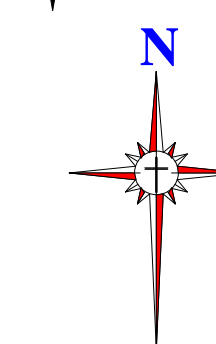
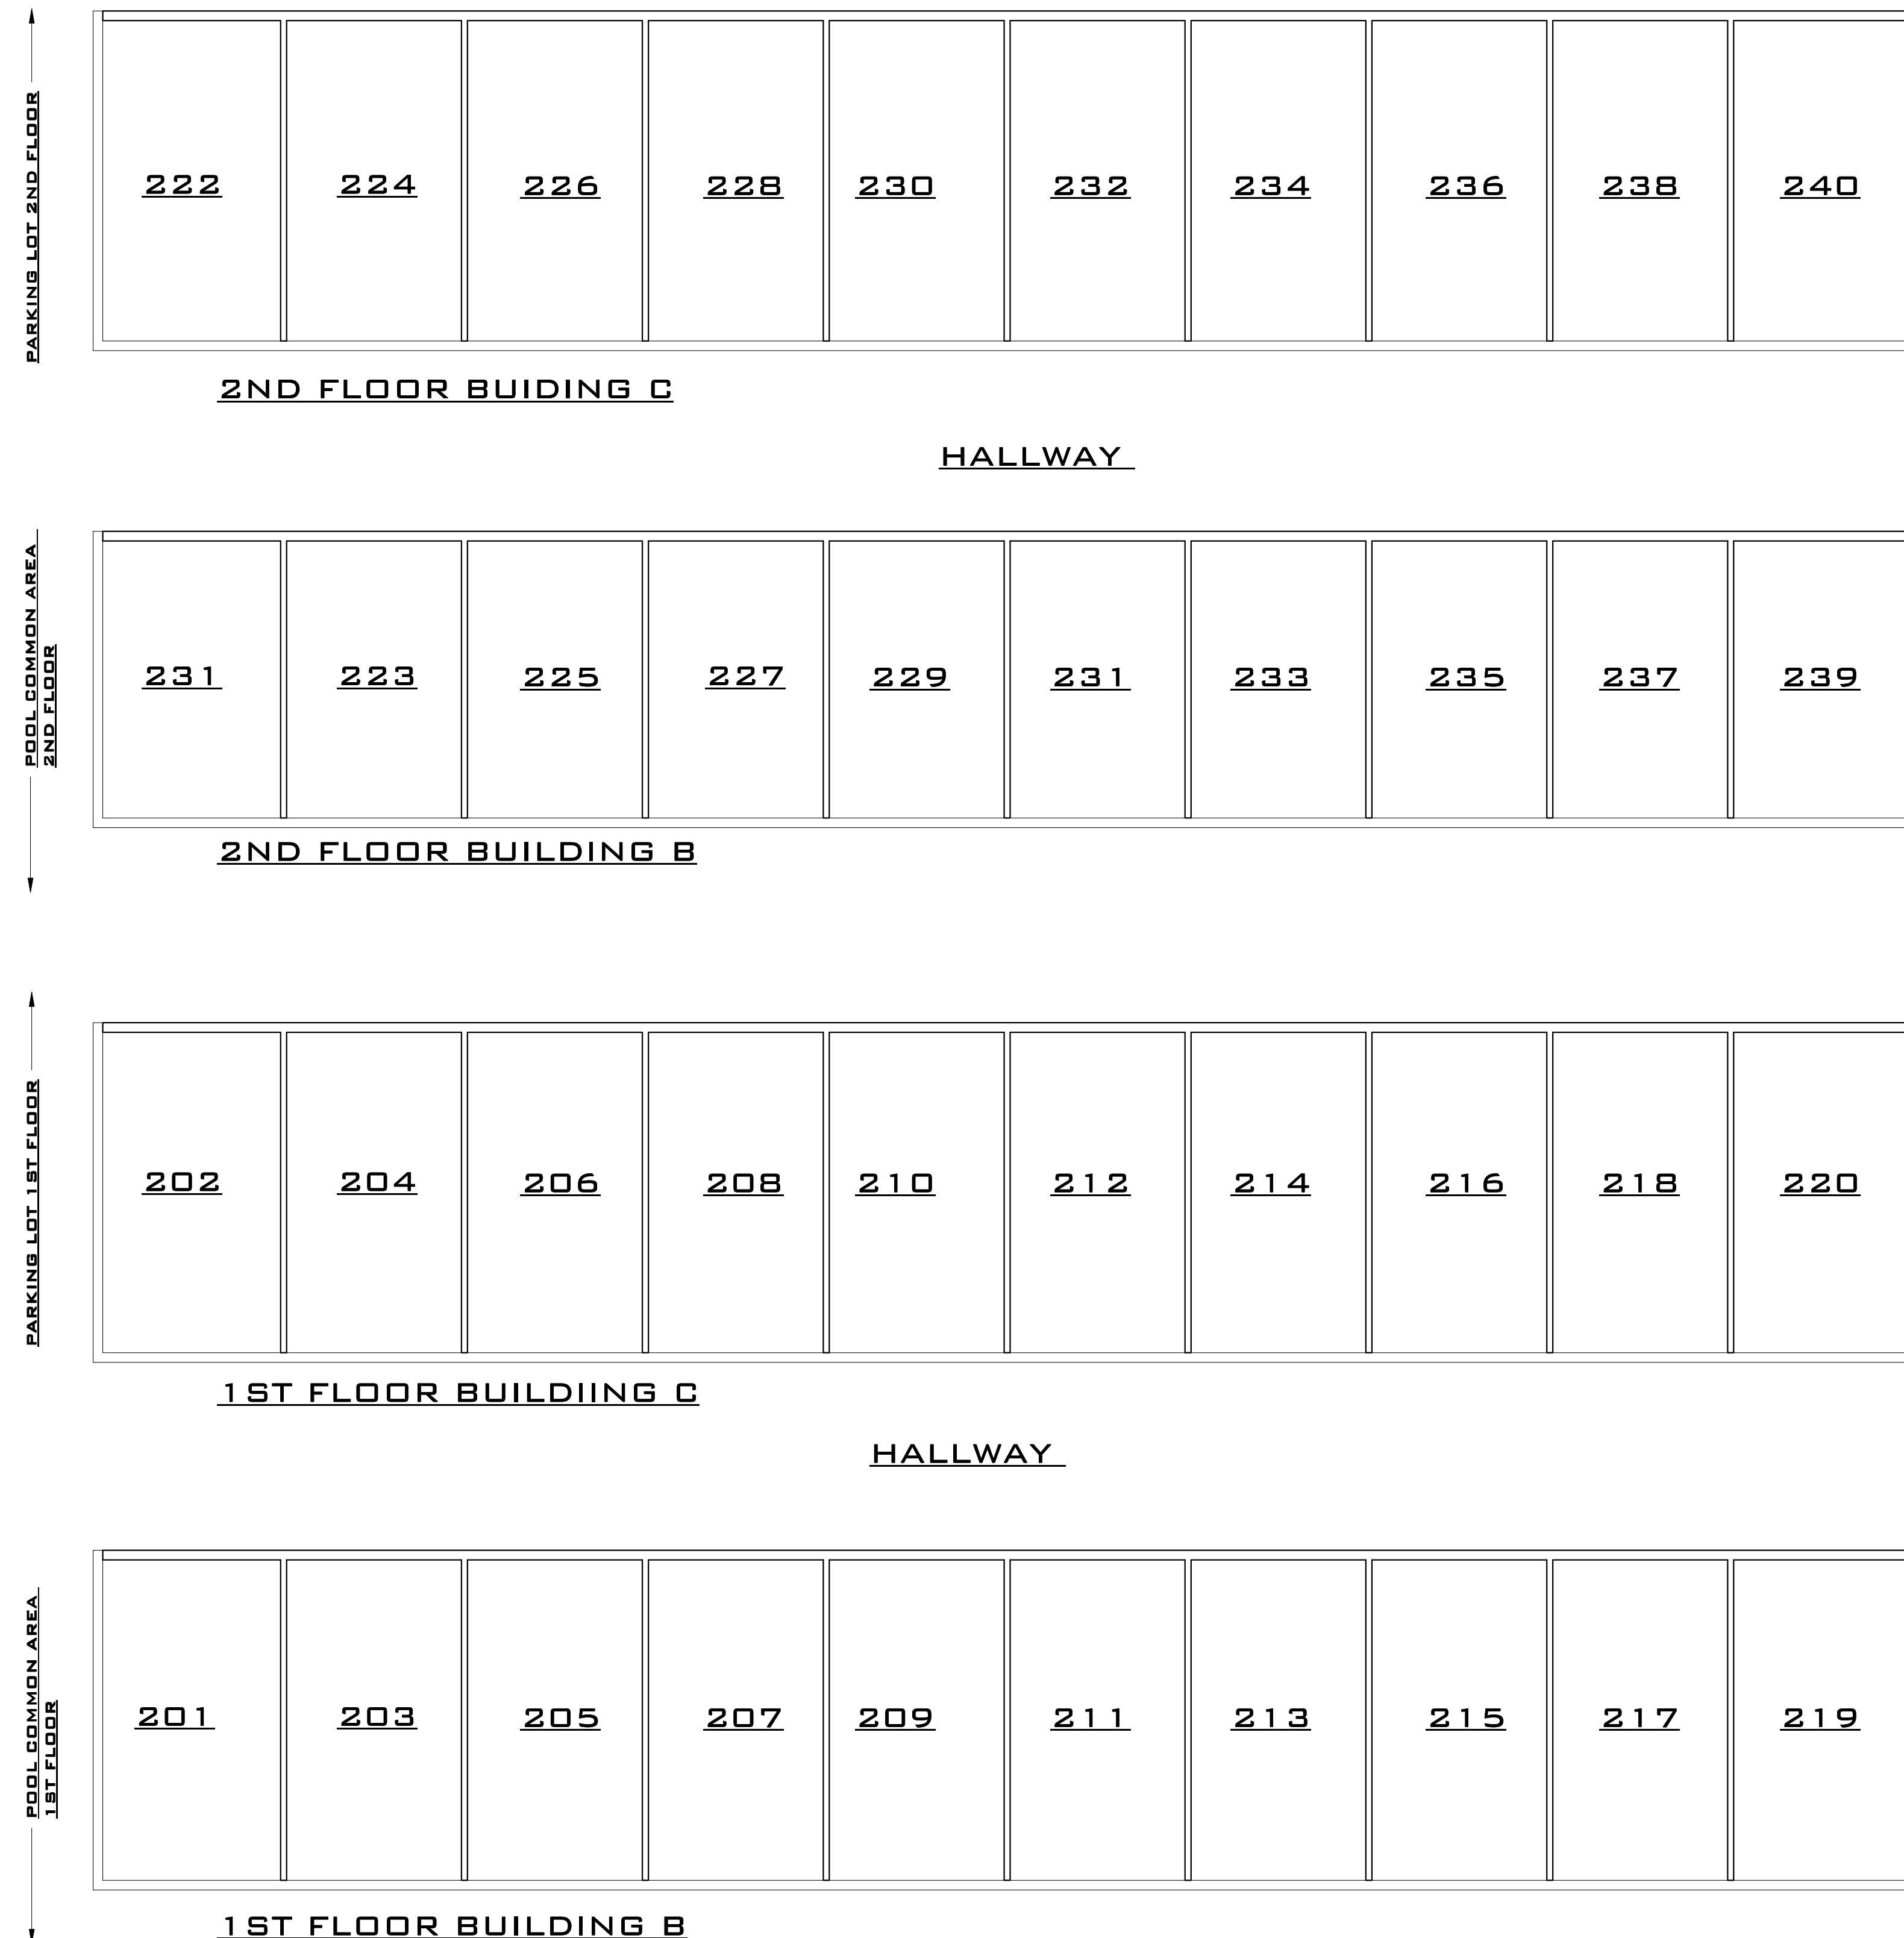


NEW FIRE SPRINKLER SYSTEM SHALL BE INSTALLED SEE PLANS BY
FIRE SPRINKLER COMPANY

1 FLOOR PLANS (APARTMENT ROOMS)
1/8" = 1'-0"

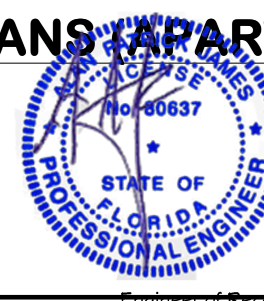

Patrick James using a Digital
Signature and date.
Printed copies of this document
with the seal in black and white
are not considered signed and
sealed and the signature must
be verified on any electronic
copies.

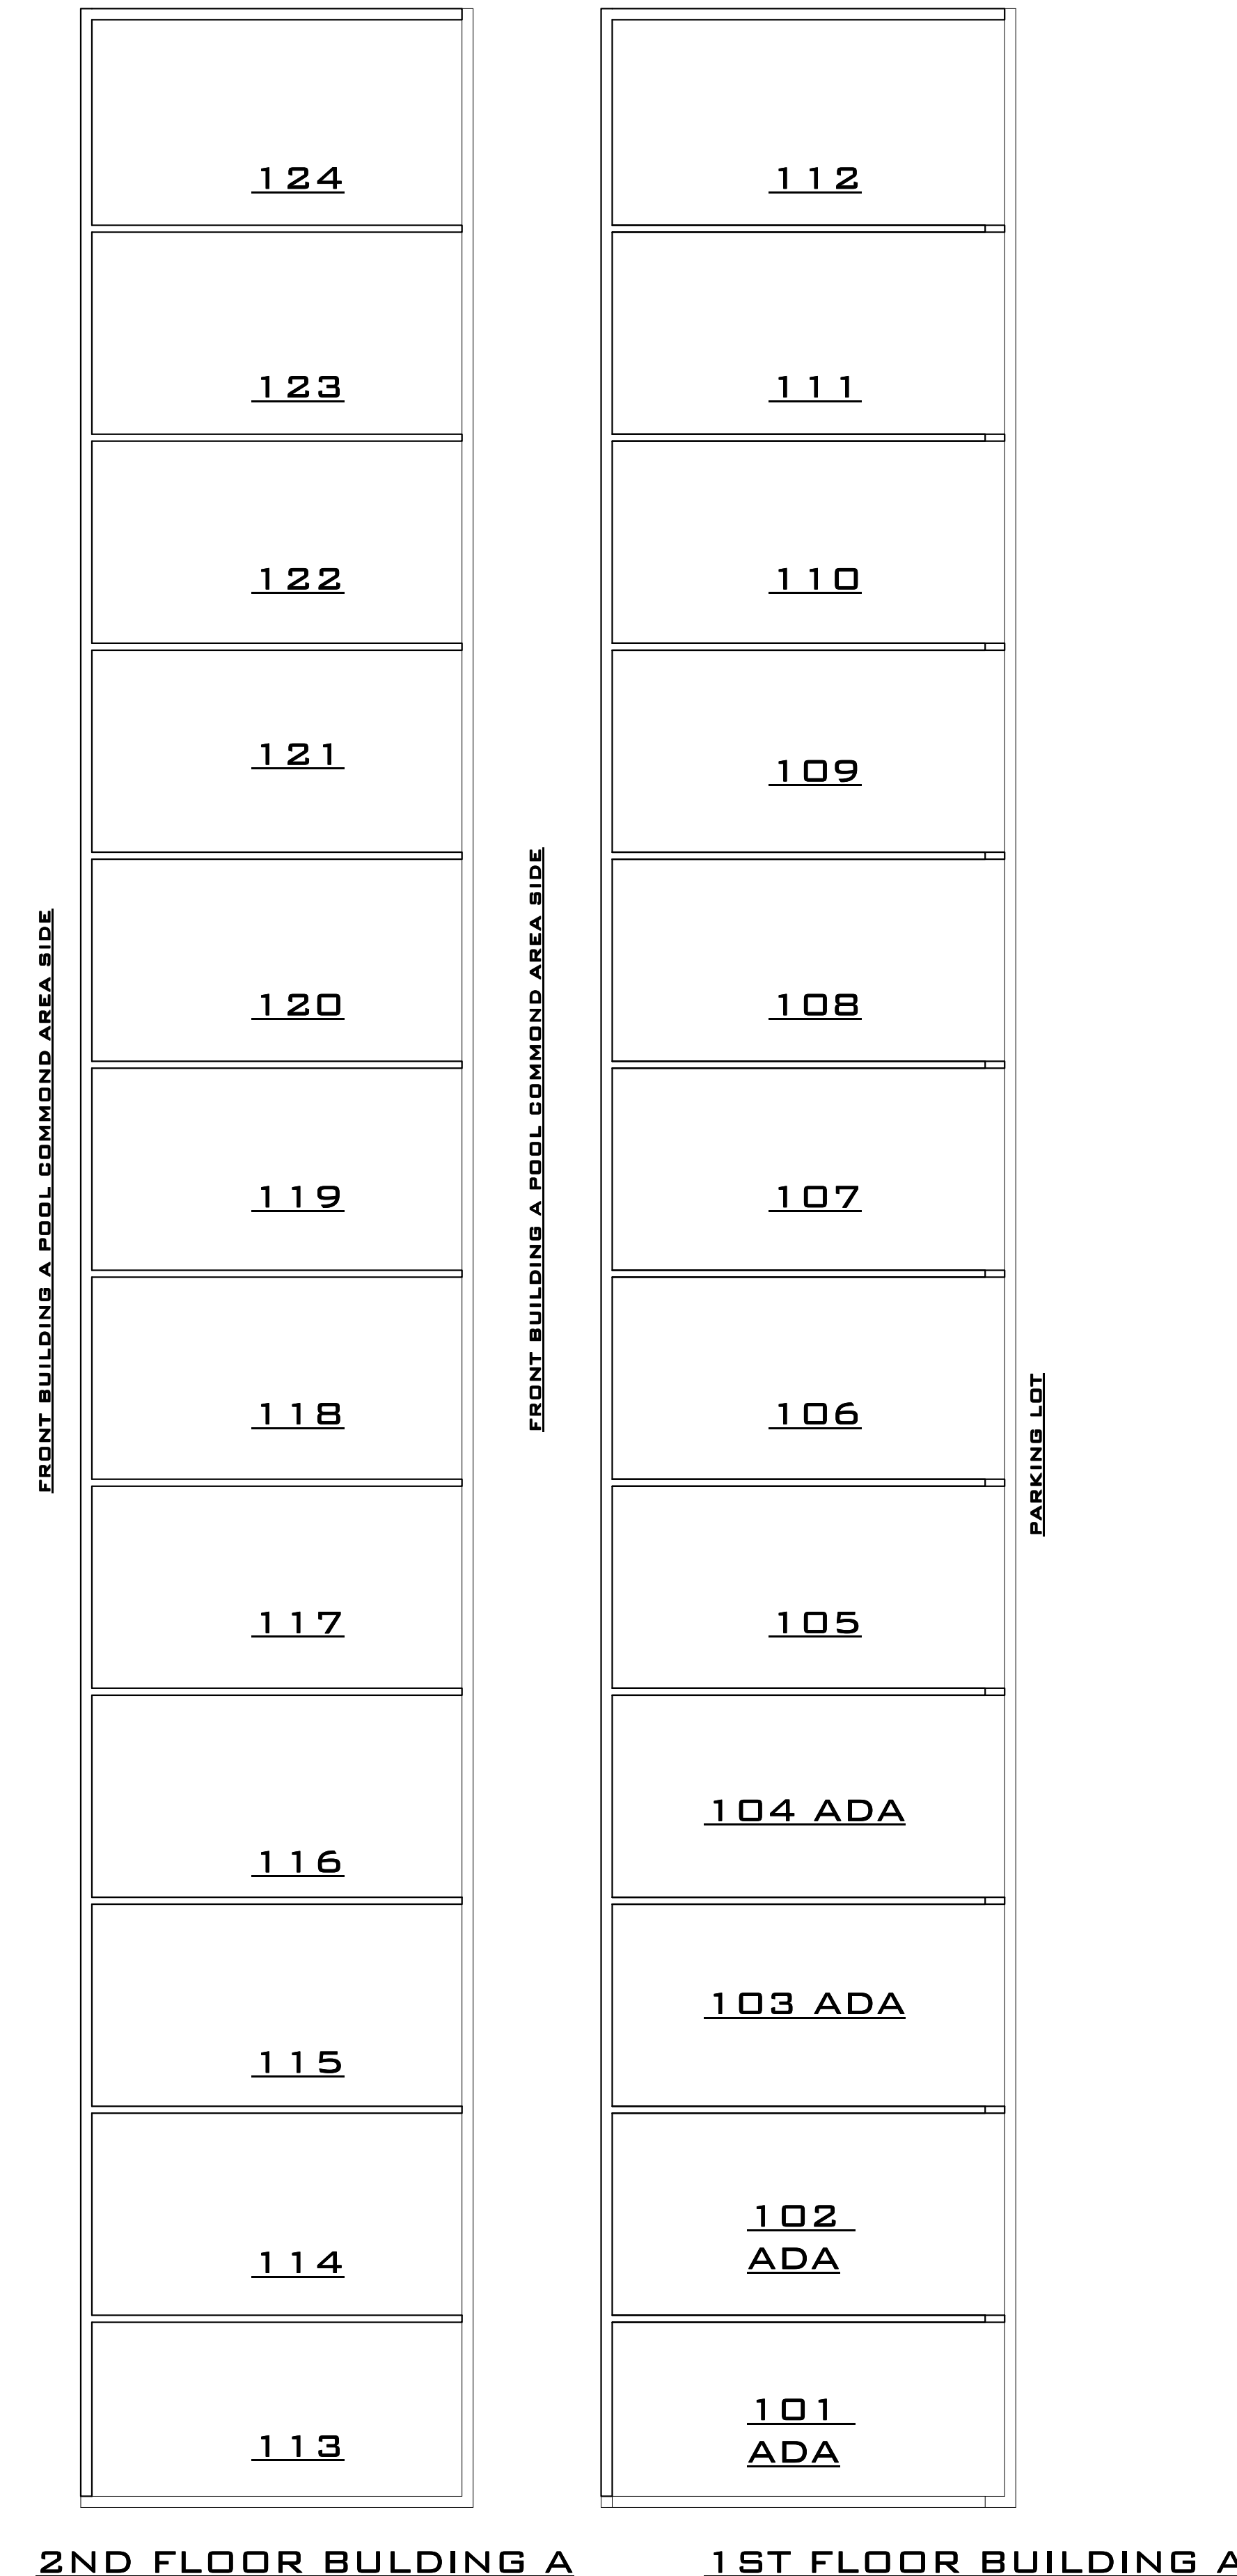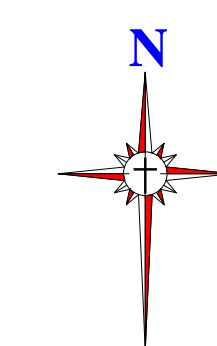

JB DESIGNS
4904 GOLD TREES WAY
SARASOTA FLORIDA 34232
941-780-8853 PHONE
JBDESIGNS2112.COM

PROJECT:
DAYS INN OCALA

3811 NW BLIGHTON RD.
OCALA, FLORIDA

CONTRACTOR:
TREV HORNBERGER LLC
6825 SW 86 TH STREET
OCALA FLORIDA 34476
C6C02759

Alan James, PE# 80637
941-321-3175 AJRAREEM4@GMAIL.COM
110 Da Vinci Drive, Nokomis, FL 34275



ALAN JAMES, PE #80637
110 DAVINCI DR, NOKOMIS, FLORIDA 34375
AJRARE@COMCAST.NET
941-321-3175

REVISIONS
REV.1 03.31.21
REV.2 08.02.21
REV.3 01.04.22
REV.4 02.07.22


DATE:
3.11.21

SHEET NO.

A-102

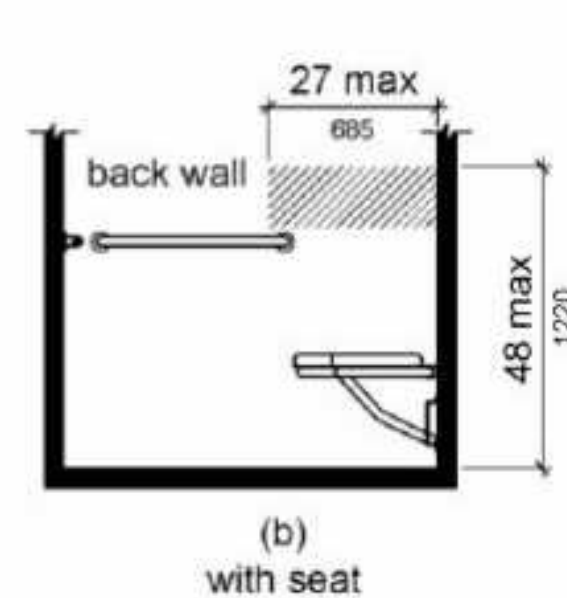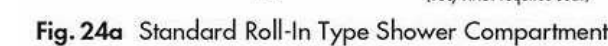

**FIGURE 608.5.2 STANDARD ROLL-IN TYPE
SHOWER COMPARTMENT CONTROL
LOCATION**

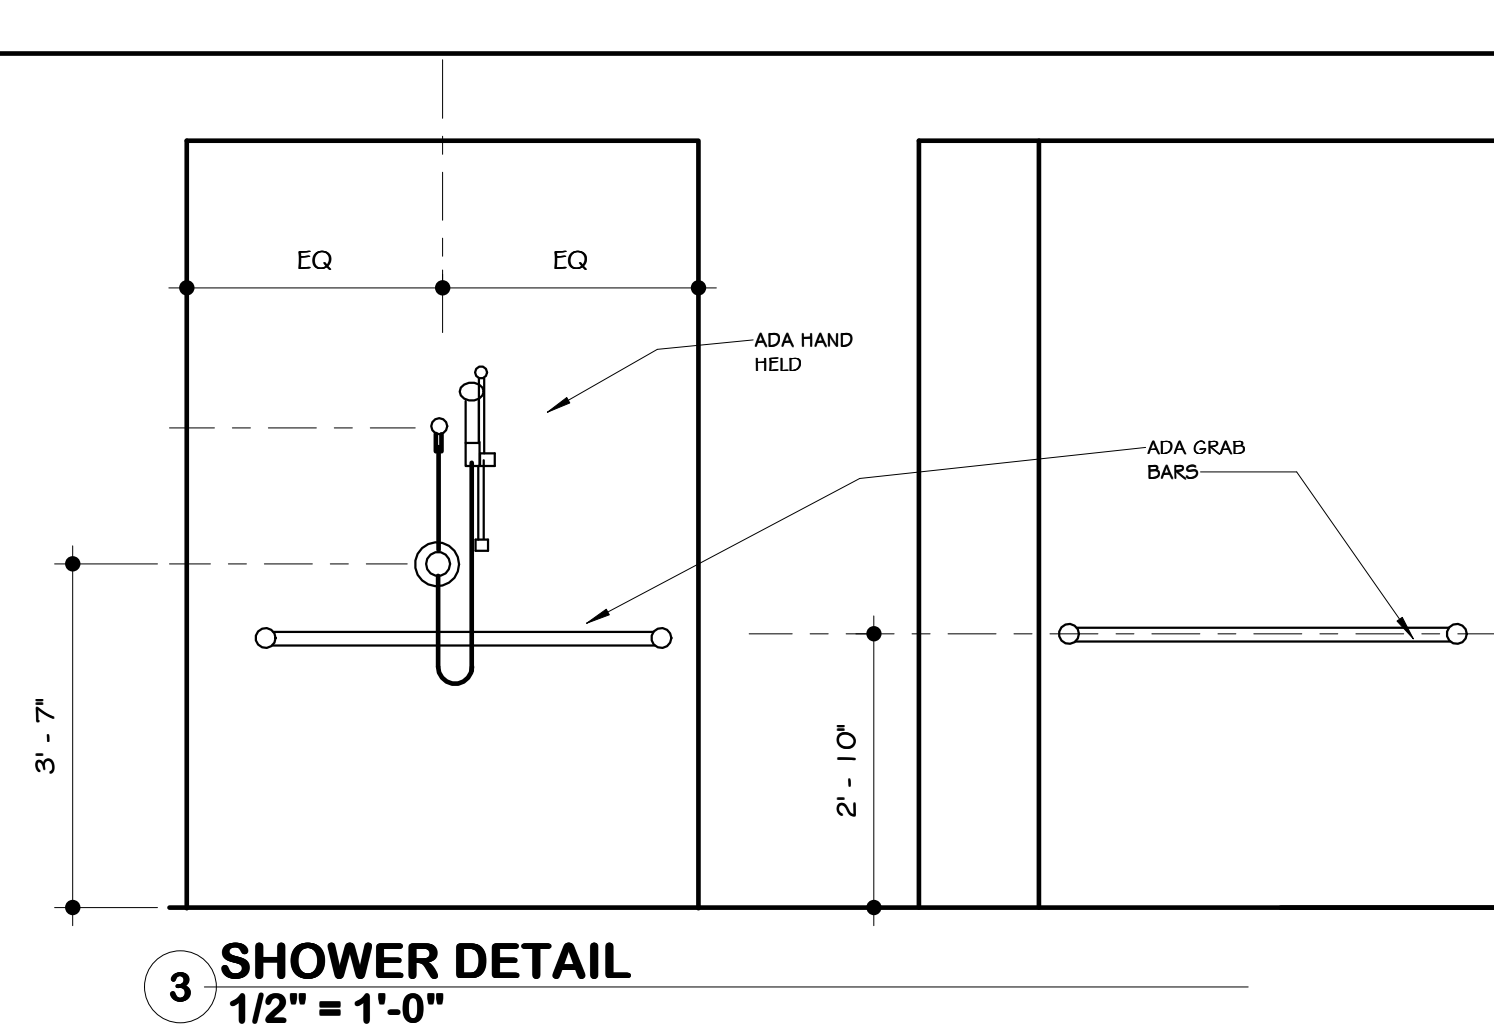

3 **SHOWER DETAIL**
1/2" = 1'-0"

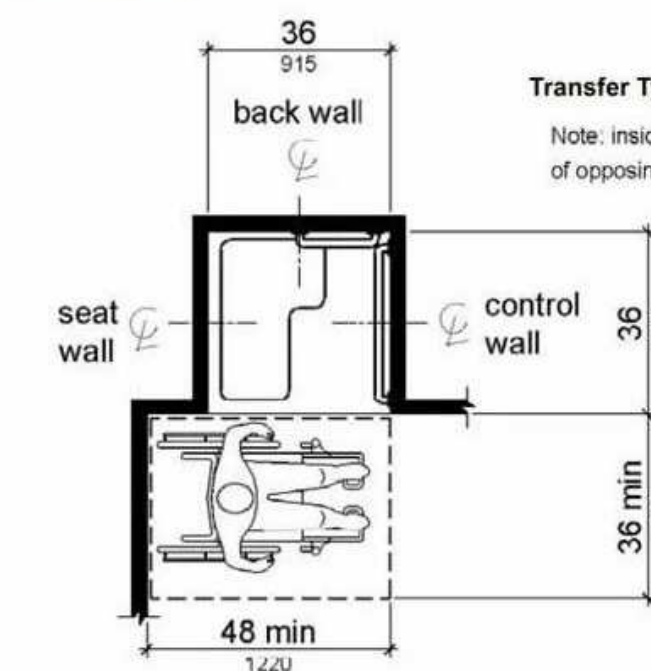


Figure 608.2.1
Transfer Type Shower Compartment Size and Clearance




Note: inside finished dimensions measured at the center points of opposing sides

2010 Standards: Titles II and III - 175

Transfer type showers are a very specific type of shower defined by the 2010 ADA code as a 36" by 36" shower with a seat and grab bars and more specifically adhering to the following:

- Must be 36" from center points of opposing sides-no construction tolerance is stated in the code
- Must be 36" from the back wall to the outside of the shower on the wall the seat is mounted on - no construction tolerance is stated in the code
- 36" minimum opening at the entry of the shower from the top to floor
- ANSI calls for vertical grab bar on control wall
- L-shaped seats placed no more than 3" from front entry and may be folding or non-folding
- Back wall grab bar to extend 18" from control wall
- Clearance of 36" wide minimum by 48" long minimum measured from the control wall

EXCEPTION: Thresholds up to 2" max permitted for transfer showers in existing facilities where provision of a .5" high threshold would disturb the structural reinforcement of the floor slab. However, most owners want to make every effort to comply with current codes and not rely on the exception clause.

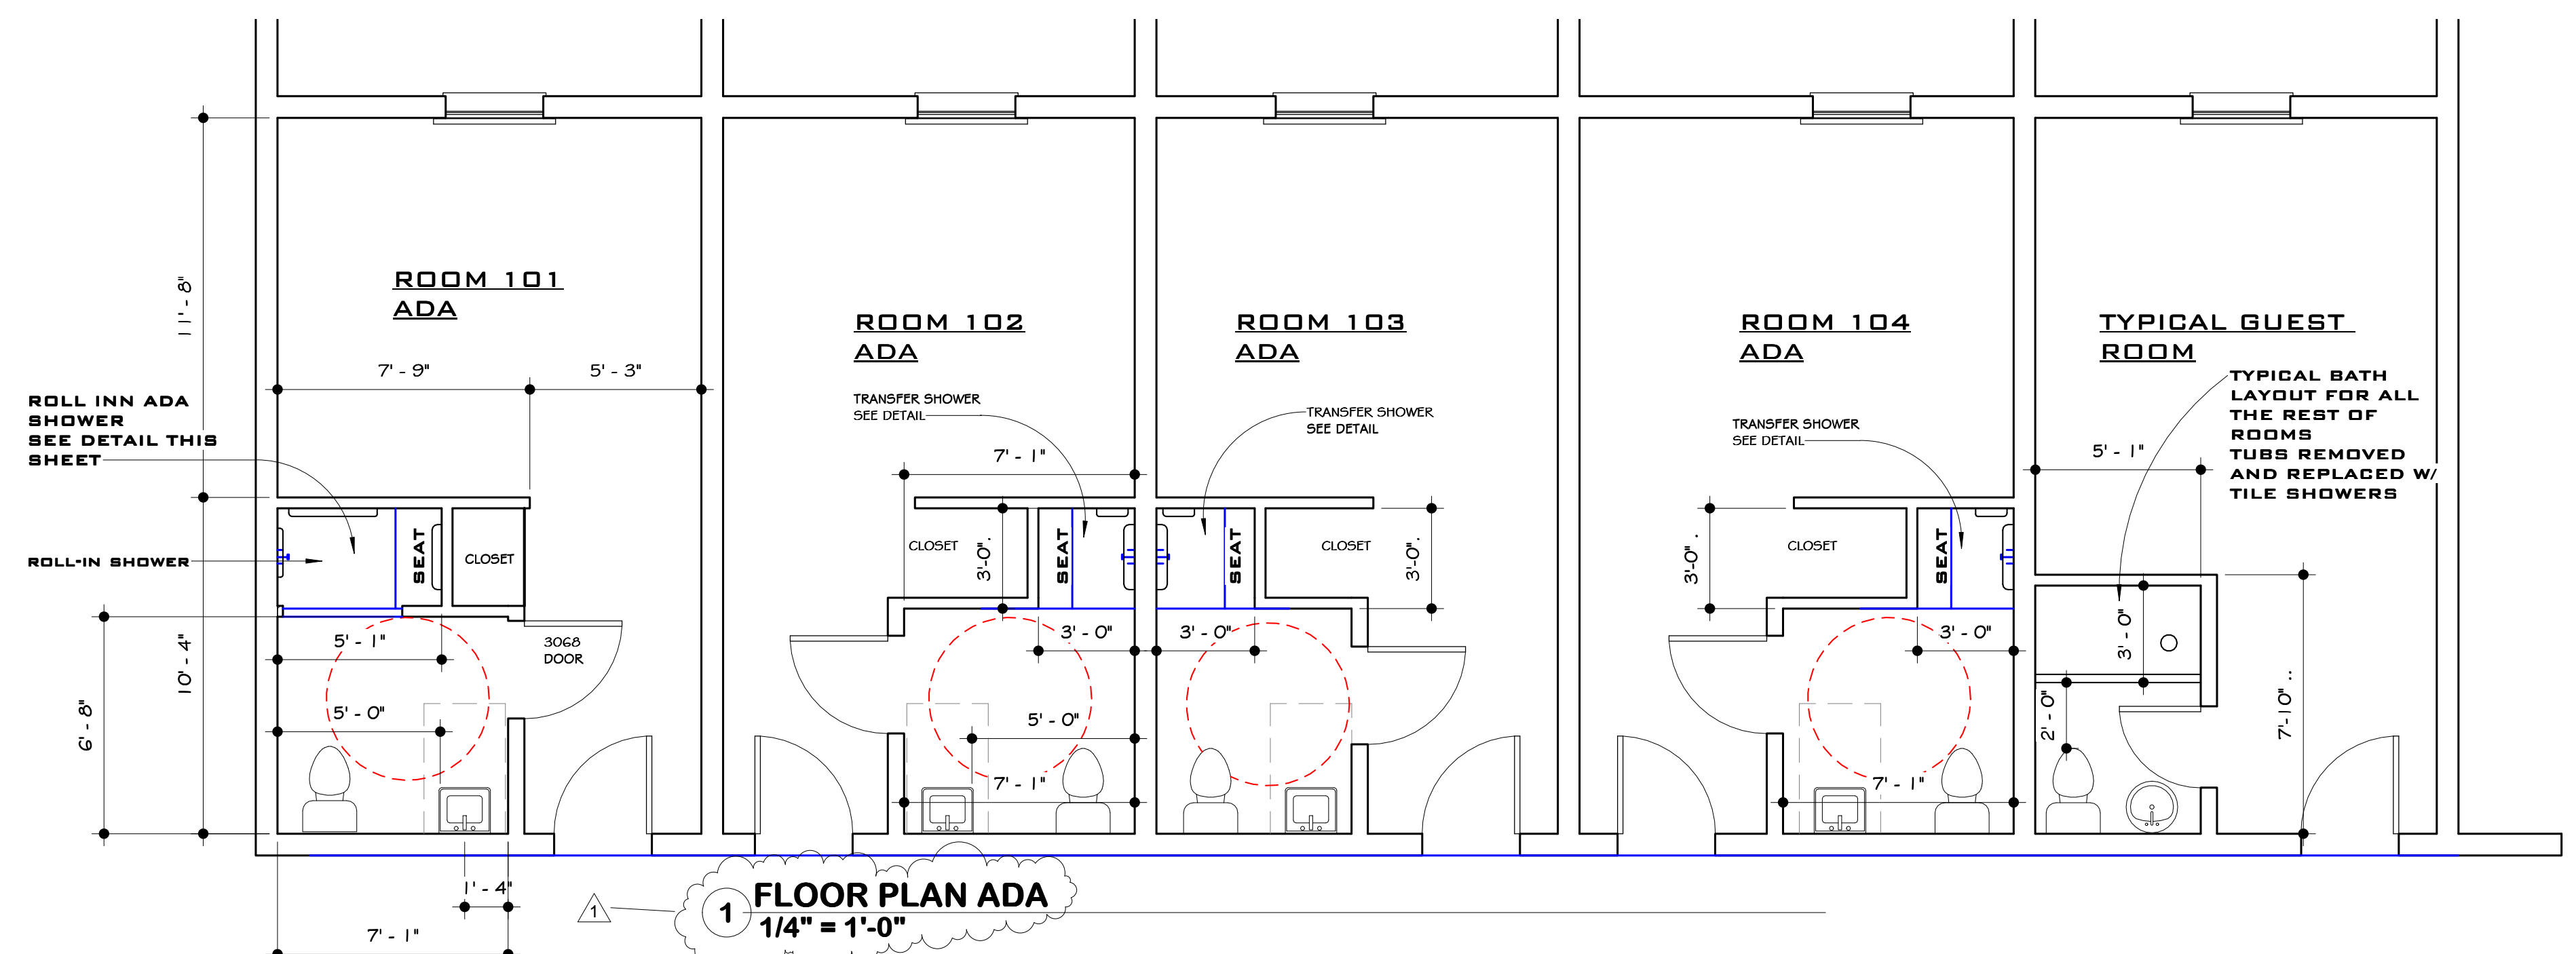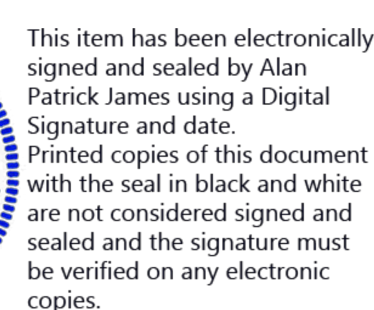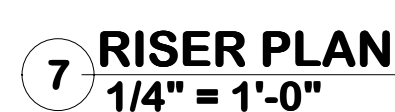

1 FLOOR PLAN ADA
1/4" = 1'-0"

TITEN HD 1/2" DIA. X 6" AT 18" O.C.W/ WASHERS 3X3X1/8"

EGRESS WINDOW NOTES
THE BOTTOM OF THE EGRESS WINDOW OPENING CAN'T EXCEED 44" FROM THE FINISHED FLOOR. THE MINIMUM OPENING AREA OF THE EGRESS WINDOW IS 5.7 SQUARE FEET. THE MINIMUM EGRESS WINDOW OPENING HEIGHT IS 24" HIGH. THE MINIMUM EGRESS WINDOW OPENING IS 20" WIDE.

REMOVE 3068 SLIDING GLASS DOOR

SIMP. LSTA 24 AS SHOWN

1/4" X 3-1/4" MASONRY SCREWS AT 8" O.C. ON SIDES

EXISTING CMU WALL

SIMP. LSTA 24 AS SHOWN

SIMP. LSTA 24 AS SHOWN

TITEN HD 1/2" DIA. X 6" AT 18" O.C.W/ WASHERS 3X3X1/8"

FOR ROOMS

113,
114,115,116,117,118,119,120,121,
122,123,124,
221,223,225,227,229,231,
233,235,237,239

2 DETAIL @ REMOVED SGD FOR NEW WINDOW OR DOOR
1/2" = 1'-0"

NOTE: HALLWAYS WALLS ARE 1 HOUR RATED FIREWALLS

NEW FIRE SPRINKLER SYSTEM SHALL BE INSTALLED SEE PLANS BY FIRE SPRINKLER COMPANY



This item has been electronically signed and sealed by Alan Patrick James using a Digital Signature and date. Printed copies of this document with the seal in black and white are not considered signed and sealed and the signature must be verified on any electronic copies.

Engineer of Record:

Alan James, PE# 80637
941-321-3175 AJRARE64@GMAIL.COM
110 Da Vinci Drive, Nokomis, FL 34215

TITEN HD 1/2" DIA. X 6" AT 18" O.C.W/ WASHERS 3X3X1/8"

REMOVE 3068 DOOR

1/4" X 3-1/4" MASONRY SCREWS AT 8" O.C.

EXISTING CMU WALL

2X6 FRAMING AT 16" O.C. USE PT AT CONC.

ADD R19 INSULAT ION TYP.

TITEN HD 1/2" DIA. X 6" AT 18" O.C.W/ WASHERS 3X3X1/8"

4 DETAIL@REMOVED DOOR@ INFILL
1/2" = 1'-0"

FOR ROOMS
202,204,206,208,210, 212, 214,
216, 218, 220

TECTUM I STRUCTURAL ACOUSTIC ROOF DECK PROVIDES EXCELLENT SOUND ABSORPTION, A THERMAL BARRIER FOR FIELD APPLIED FOAM PLASTICS, AND IS COMPATIBLE WITH A WIDE VARIETY OF INSULATION AND ROOFING MATERIALS.

KEY FEATURES
SOUND ABSORPTION — NRC UP TO 0.80
R-VALUE UP TO 6
SPANS UP TO 6 FEET
50 POUND DESIGN LOAD
DIAPHRAGM SHEAR UP TO 542 DSN/LF
NAILABLE SURFACE
LOW SLOPE APPLICATIONS

CONC. SLAB FOR 1ST FLOOR CONC.. DECK 2ND FLOOR

2X6 FRAMED WALL STUDS @16" O.C. MAX.

TYPICAL GUEST ROOM

RENOVATED TYPICAL GUEST ROOM FLOOR PLAN
W/ NEW WINDOW 1ST & 2ND FLOORS

A-105
5

EXISTING RAILING FOR 2ND FLOOR

CONC. SLAB FOR 1ST FLOOR CONC.. DECK 2ND FLOOR

NEW 3068 METAL DOOR IMPACT RES.

2X6 FRAMED WALL STUDS @16" O.C. MAX.

REMOVE EXISTING SLIDING GLASS DOOR

TYPICAL GUEST ROOM

EXISTING/ DEMO.TYPICAL GUEST ROOM FLOOR PLAN
1ST & 2ND FLOORS

EXISTING STEEL TRUSSES ON 32" O.C.

NEW 37"x 63" H. EGRESS SINGLE HUNG WINDOW NON IMPACT RES.

EXISTING CMU WALL

R-19 INSULATION

EXISTING ROOF STRUCTURE PORTION TO BE REPAIRED

REPAIR DAMAGED PLYWOOD W/ 3/4" THK. ROOF SHEATHING AND POLY ISO (INSULATED PANELS)

REPAIR PORTION OF DAMAGED ROOF W/ TECTUM ACOUSTIC CEILING PANELS 3" THICK PANEL

EXISTING CONC. LINTEL

SP2 AT EA. STUD

2X6 TOP PLATE W/ TITEN HD 1/2" DIA. X 6" AT 18" O.C.W/ WASHERS 3X3X1/8"

PAINTED 7/8" THK (3 COAT) CEMENT PLASTER OVER GALV. SELF-RAISED FELT BACKED WIRE LATH ON 1/2" CDX (3 PLY) SHEATHING (OVER NEW FRAMING AREAS) MATCH EXISTING

SP1 AT EA. STUD

TITEN HD 1/2" DIA. X 6" AT 18" O.C.W/ WASHERS 3X3X1/8"

EXISTING CONC. DECK

R-19 INSULATION

EXISTING CONC. LINTEL

SP2 AT EA. STUD

TITEN HD 1/2" DIA. X 6" AT 18" O.C.W/ WASHERS 3X3X1/8"

PAINTED 7/8" THK (3 COAT) CEMENT PLASTER OVER GALV. SELF-RAISED FELT BACKED WIRE LATH ON 1/2" CDX (3 PLY) SHEATHING (OVER NEW FRAMING AREAS) MATCH EXISTING

PAINTED WD. BASEBOARD (MATCH EXIST.)

EXISTING CONC. SLAB

SP1 AT EA. STUD

2X6 PT BOT PLATE W/ TITEN HD 1/2" DIA. X 6" AT 18" O.C.W/ WASHERS 3X3X1/8"

5 TYP. SECTION
3/4" = 1'-0"

1 FLOOR PLANS
1/4" = 1'-0"

JB DESIGNS
4904 GOLD TREES WAY
SARASOTA FLORIDA 34232
941-780-8853 PHONE
JBDESIGNS2112.COM

PROJECT:
DAYS INN OCALA

3811 NW BLIGHTON RD.
OCALA, FLORIDA

CONTRACTOR:
TREV HORNBERGER LLC
6825 SW 86 TH STREET
OCALA FLORIDA 34476
C6C02759


ALAN JAMES, PE #80637
110 DAVINCI DR, NOKOMIS, FLORIDA 34375
AJRARE@COMCAST.NET
941-321-3175

REVISIONS
REV.1 03.31.21
REV.2 08.02.21
REV.3 01.04.22
REV.4 02.07.22

DATE:
3.11.21

SHEET NO.


A-104

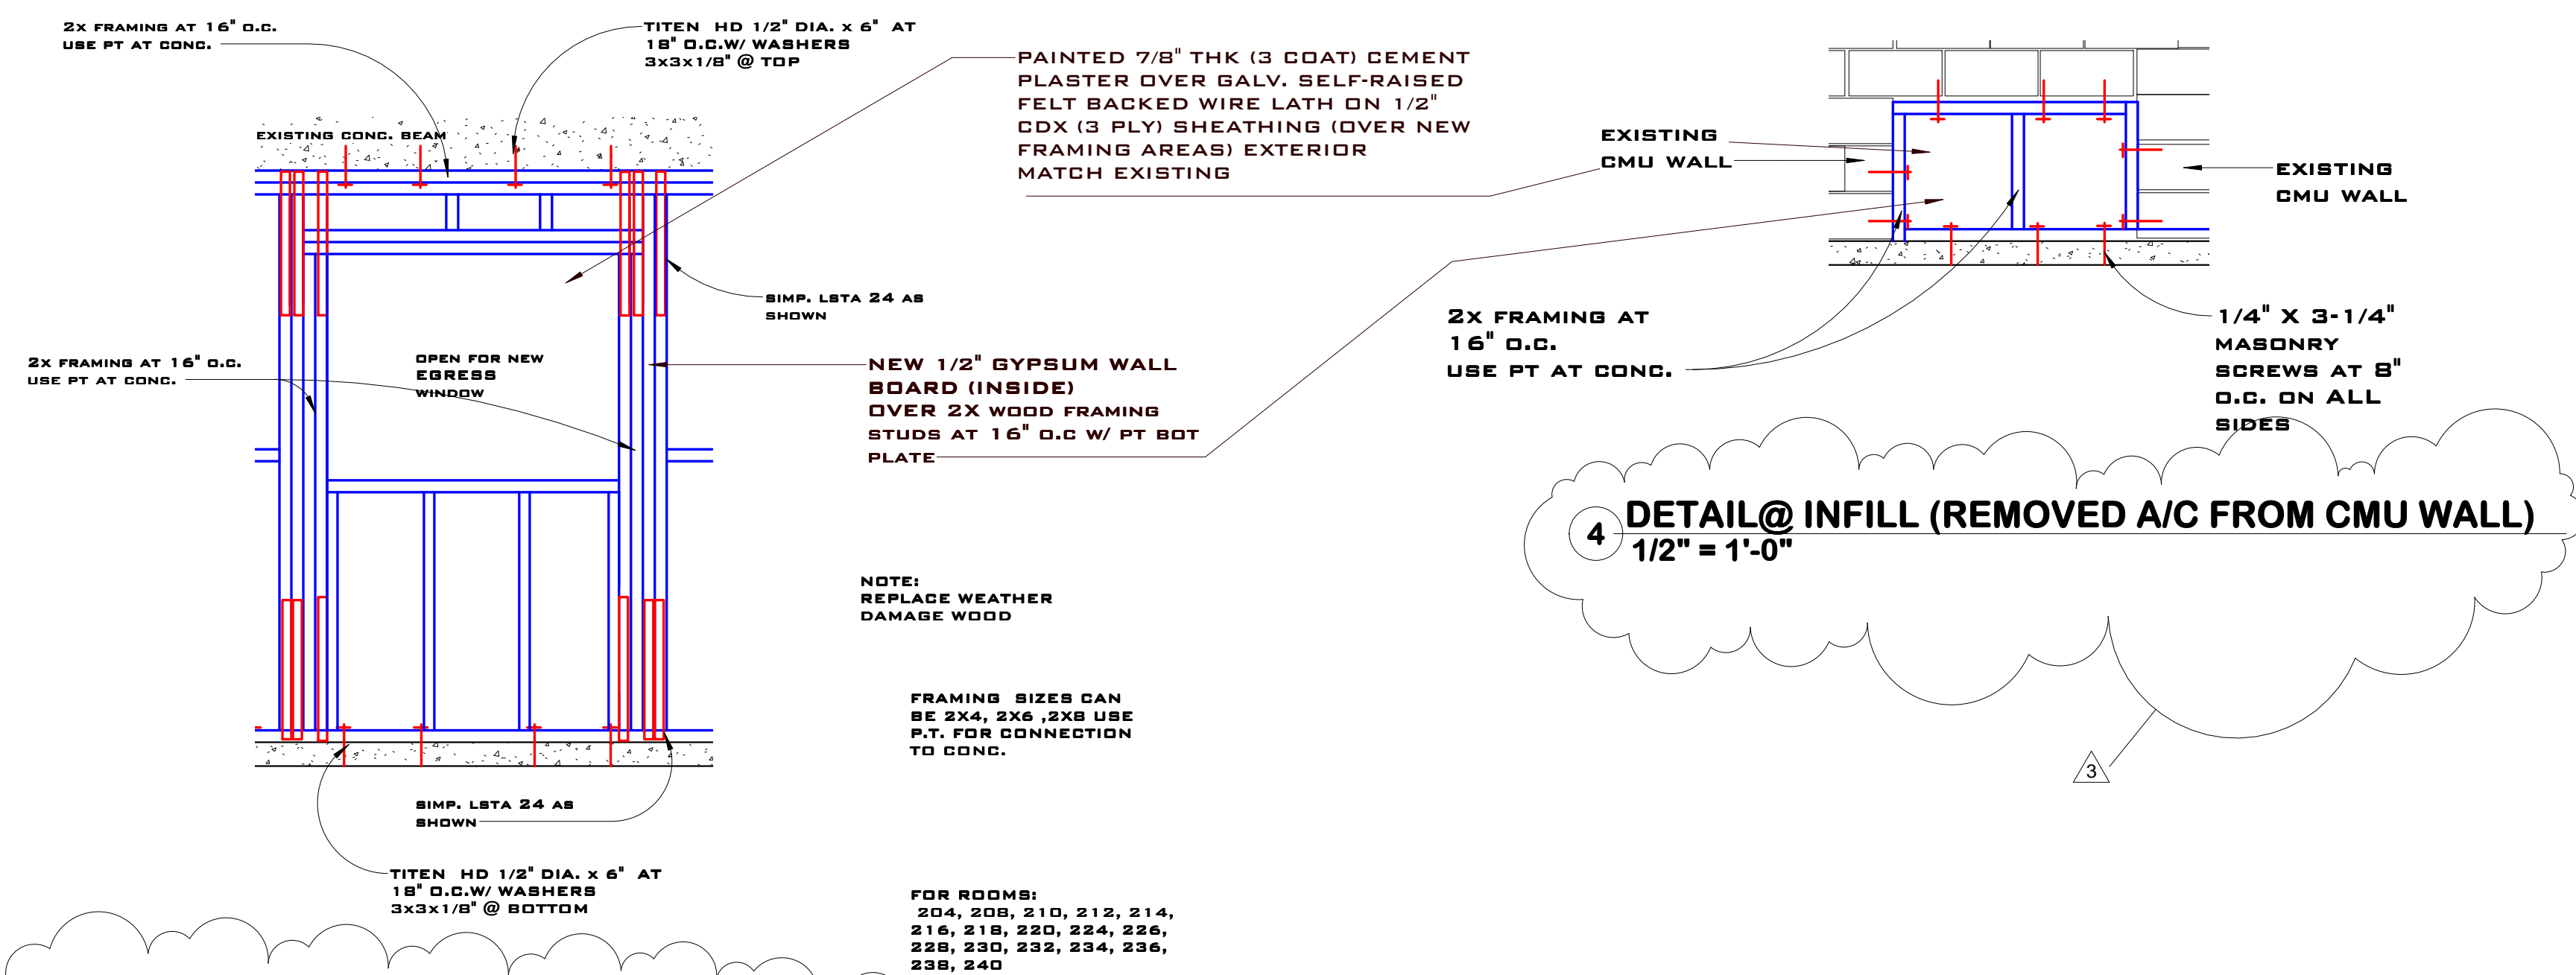

5 **DETAIL TO REPLACE NON EGRESS WINDOW**
1/2" = 1'-0"

**NOTE: HALLWAYS WALLS
ARE 1 HOUR RATED
FIREWALLS**

**NEW FIRE SPRINKLER SYSTEM SHALL BE INSTALLED SEE PLANS BY
FIRE SPRINKLER COMPANY**

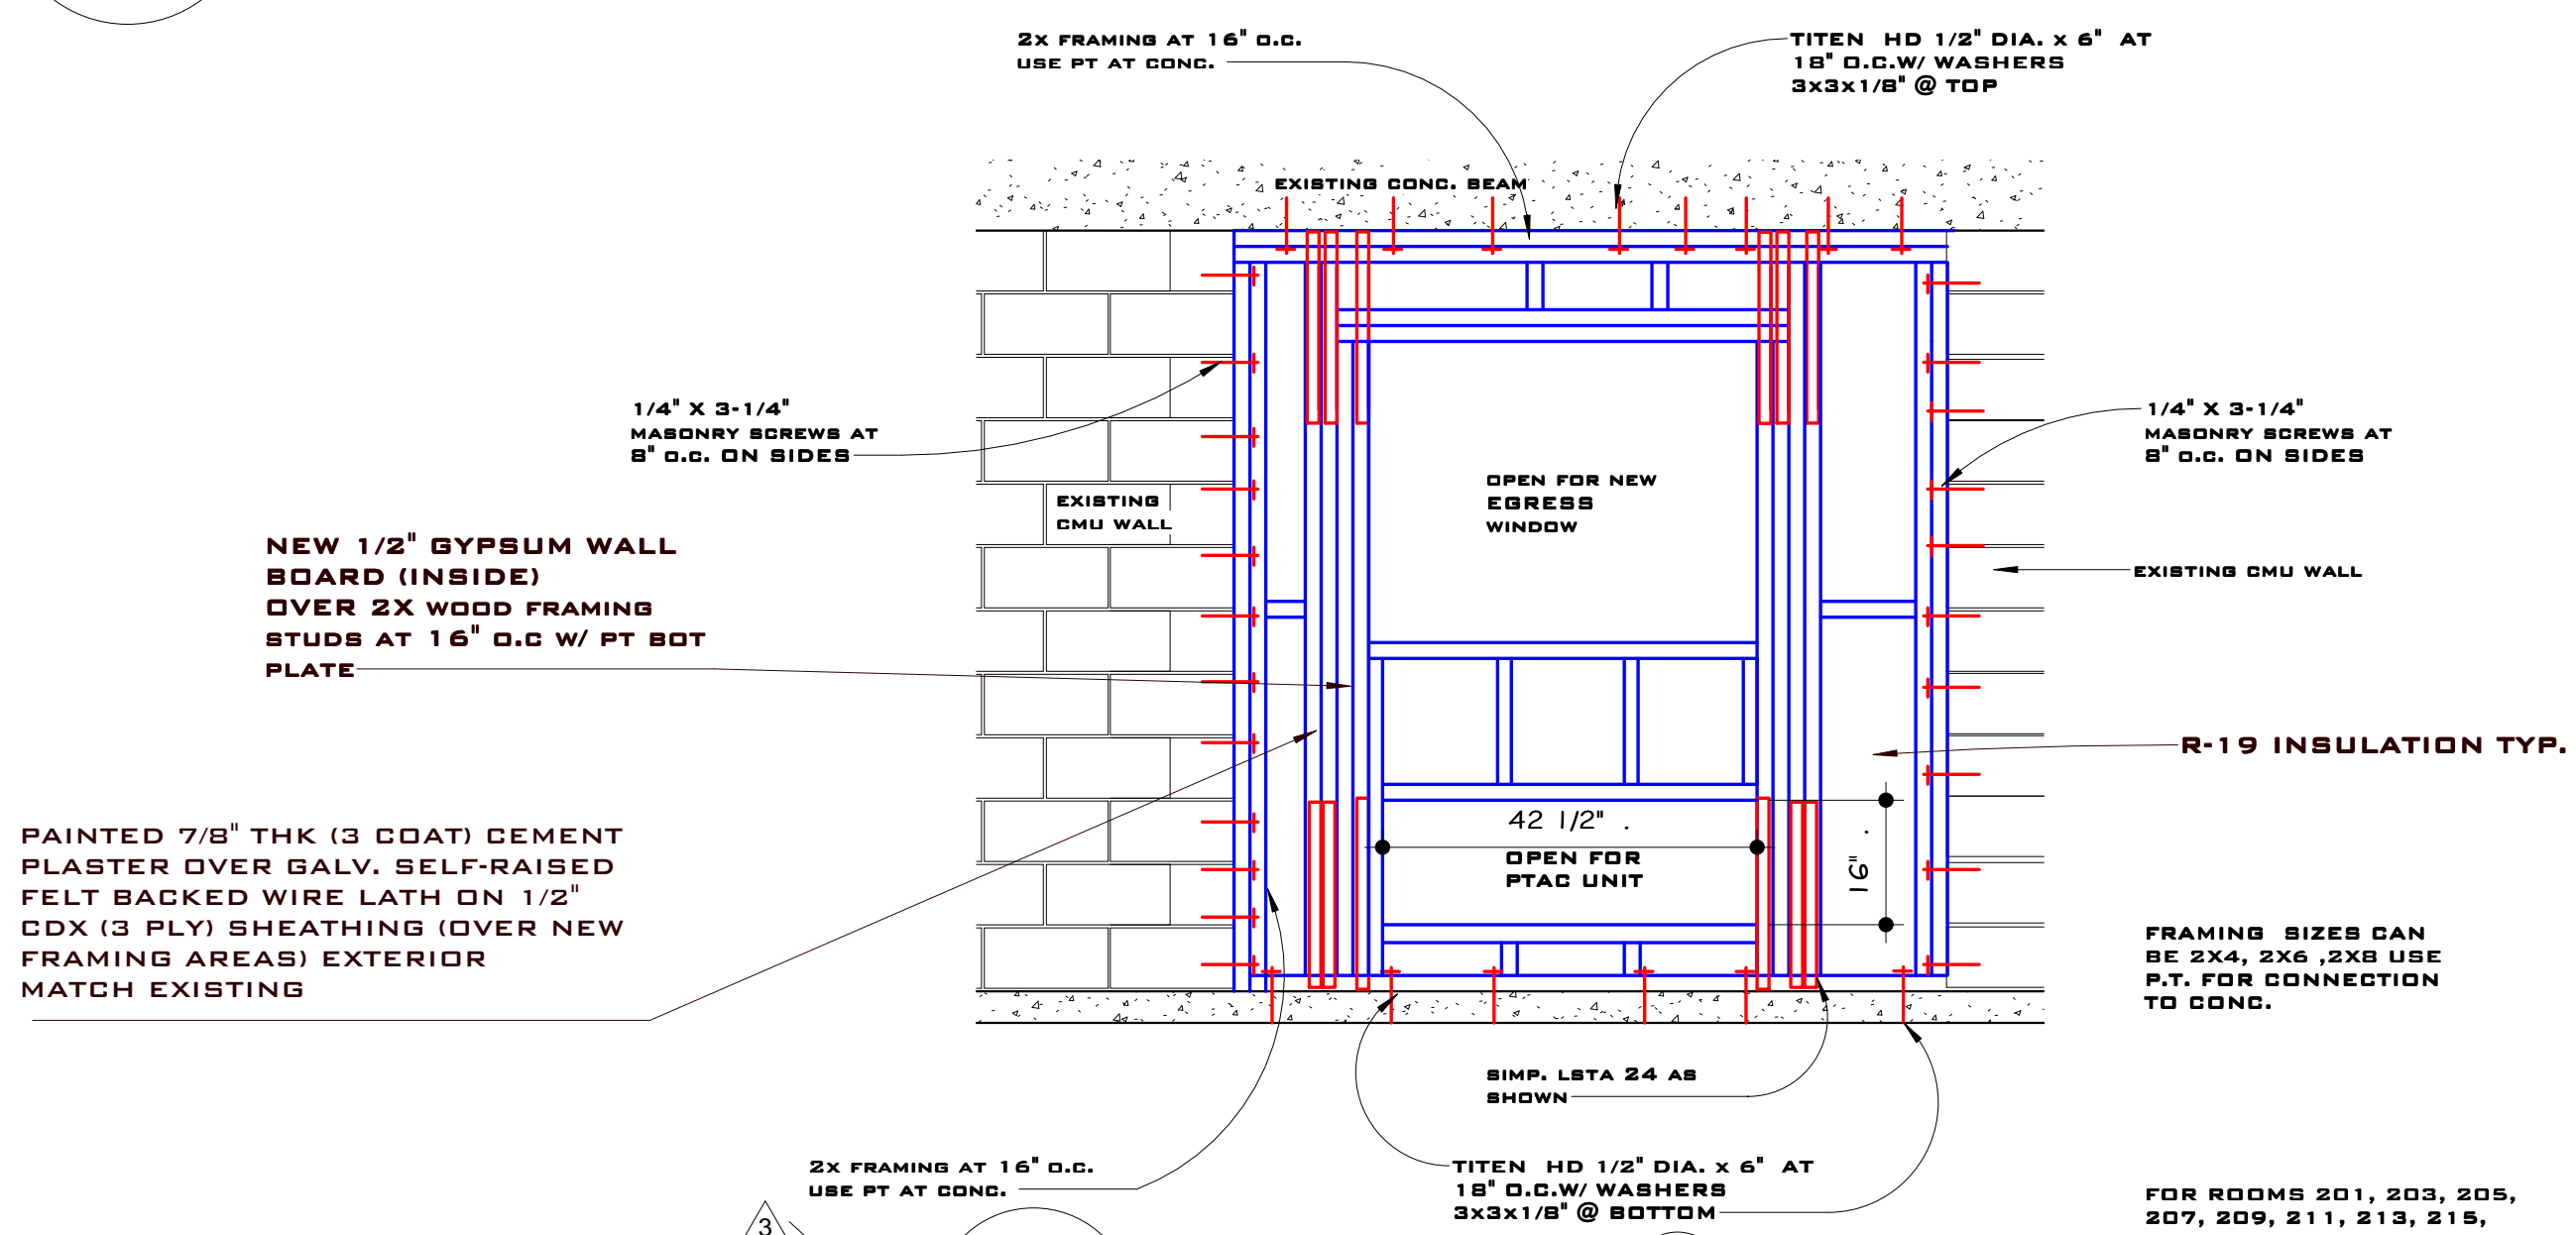

3 **DETAIL FOR A/C & NEW WINDOW**
1/2" = 1'-0"

REVISIONS
 REV.1 03.31.21
 REV.2 08.02.21
 REV.3 01.04.22
 REV.4 02.07.22

SHEET NO.
A-105




3811 NW BLIGHTON RD.
OCALA, FLORIDA


CONTRACTOR:
TREV HORNBERGER LLC
6825 SW 86 TH STREET
OCALA FLORIDA 34476
GGC02759

ALAN JAMES, PE #80637
110 DAVINCI DR, NOKOMIS, FLORIDA 34375
AJRARE@COMCAST.NET
941-321-3175


NEW FIRE SPRINKLER SYSTEM SHALL BE INSTALLED
SEE PLANS BY FIRE SPRINKLER COMPANY

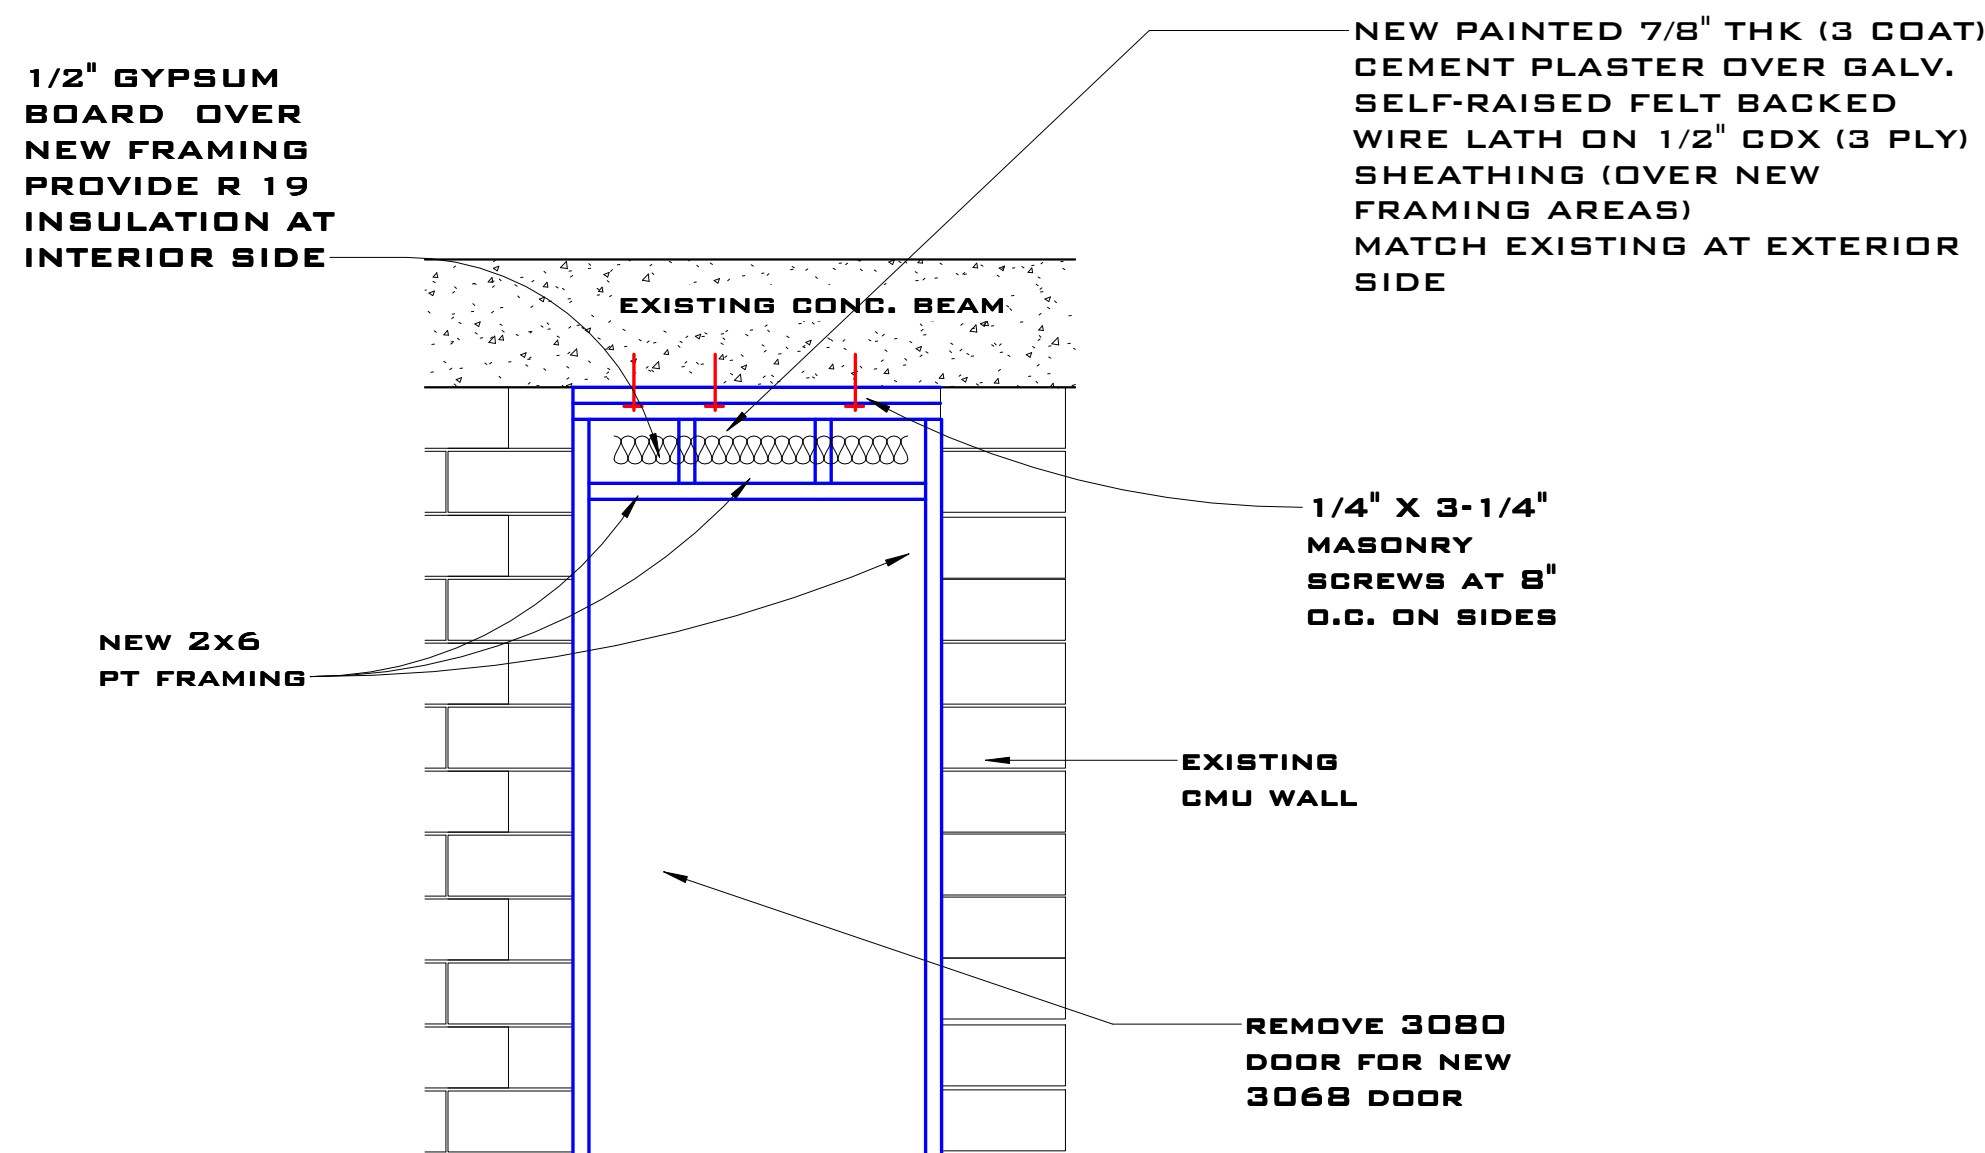

2 DETAIL AT NEW FRONT DOOR
1/2" = 1'-0"

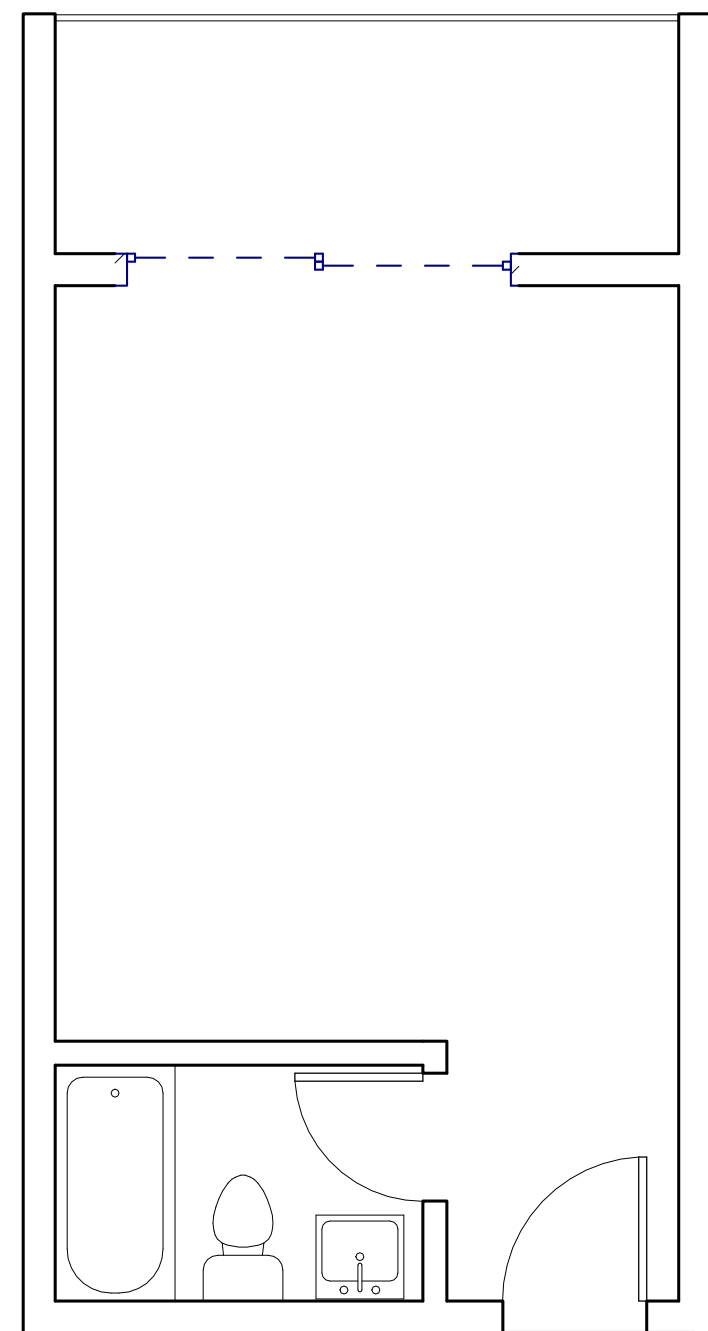


RENOVATED TYPICAL
GUEST ROOMS FLOOR PLAN
1ST & 2ND FLOORS

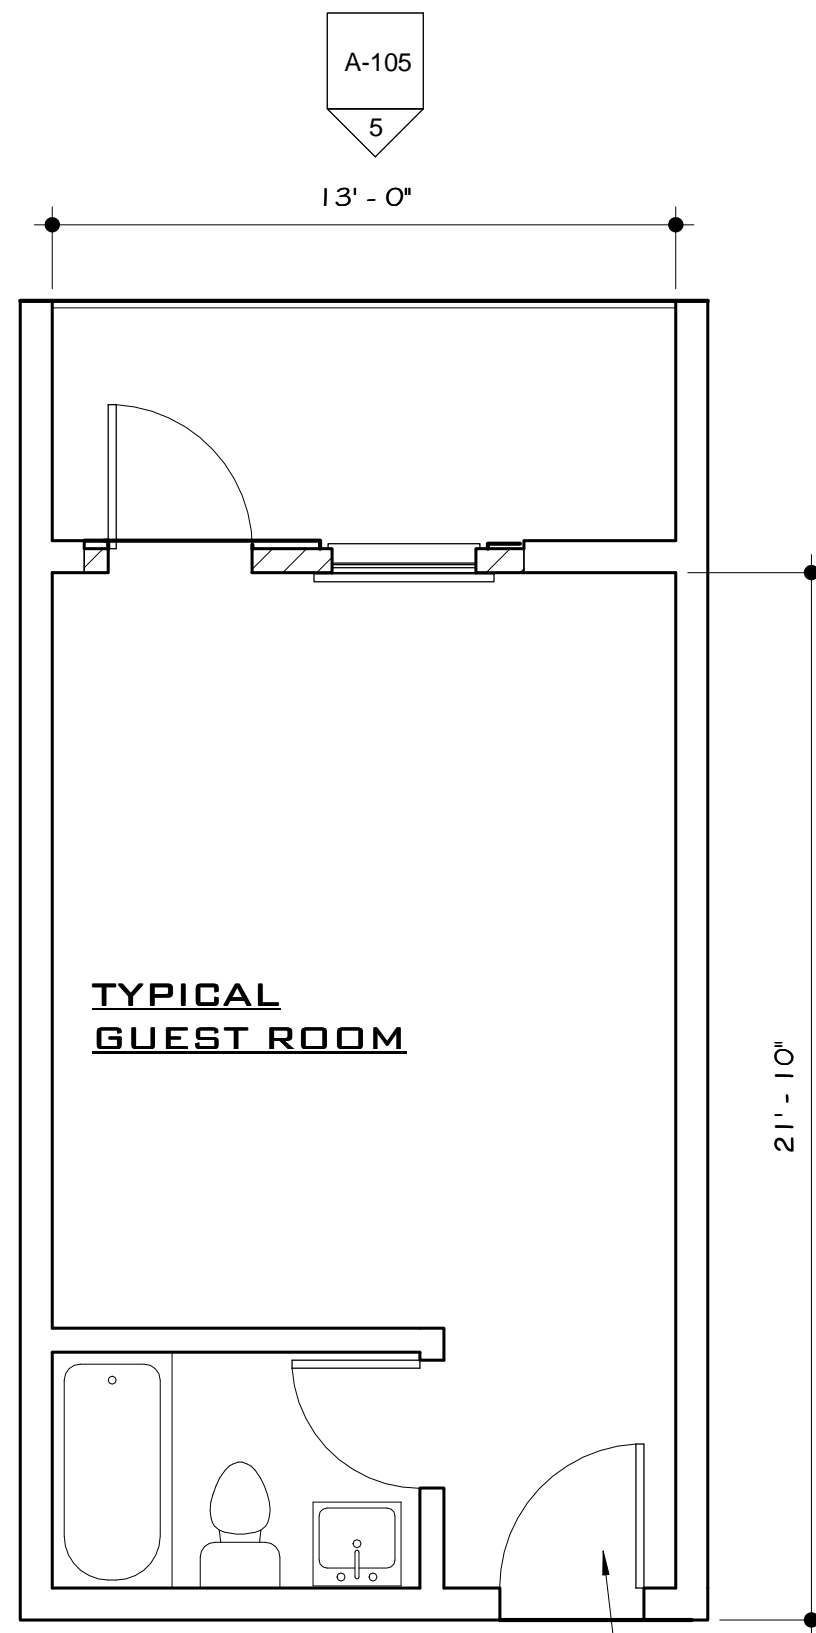

REMOVE EXISTING FRONT
3080 DOOR FOR NEW 3068
DOOR
FRAME- DOWN SEE DETAIL

1 FLOOR PLANS FOR REMOVED FRONT DOOR
1/4" = 1'-0"

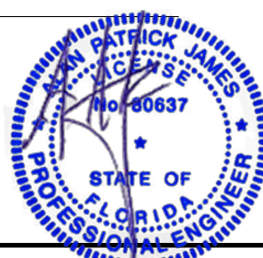

This item has been electronically signed and sealed by Alan Patrick James using a Digital Signature and date. Printed copies of this document with the seal in black and white are not considered signed and sealed and the signature must be verified on any electronic copies.

Engineer of Record:
Alan James, PE# 80637
941-321-3175 AJRARE64@GMAIL.COM
110 Da Vinci Drive, Nokomis, FL 34275

ALAN JAMES, PE #80637
110 DAVINCI DR, NOKOMIS, FLORIDA 34375
AJRARE@COMCAST.NET
941-321-3175

REVISIONS
REV.1 03.31.21
REV.2 08.02.21
REV.3 01.04.22
REV.4 02.07.22

DATE:
3.11.21

SHEET NO.

A-106

JB DESIGNS
4904 GOLD TREES WAY
SARASOTA FLORIDA 34232
941-780-8853 PHONE
JBDESIGNS2112.COM

PROJECT:
DAYS INN OCALA

3811 NW BLIGHTON RD.
OCALA, FLORIDA

CONTRACTOR:
TREV HORNBERGER LLC
6825 SW 86 TH STREET
OCALA FLORIDA 34476
C6C02759