

DOOR SCHEDULES						
	SIZE	MATERIAL	HARDWARE	REMARK		
1	(2)3'-0"x7'-0"	GLASS	H-2, 4	EXISTING		
2	3'-0"x7'-0"	STEEL	H-2, 4	EXISTING		
3	3'-0"x8'-0"	WOOD	H-1,4	NEW		
4	3'-0"x8'-0"	HOLLOW CORE	H-5	NEW		
5	3'-0"x8'-0"	HOLLOW CORE	H-1, 5	NEW		
6	3'-0"x7'-0"	WOOD	H-4, 5	NEW 1-HR FIRE RATED DOOR		
7	~(2)3'-0"x8'-0"~	~HOLLOW CORE~~	₩ <u>₽₽</u> ;5	WEW		


DOOR HARDWARE SCHEULES


- H-1: PRIVACY LOCKSET
- H-2: KEYED LOCKSET
- H-3: DEAD BOLT H-4: AUTOMATIC DOOR CLOSER
- H-5: LEVERED OPENER HANDLE H-6: PANIC HARDWARE

DOOR HARDWARE NOTES

- ALL LOCK AND PASSAGE SETS TO BE SCHLAGE GRADE OR BETTER. SUBMIT OTHERS FOR APPROVAL. LOCKS NEED TO BE REKEYABLE.

 ALL DOORS AND HARDWARE TO COMPLY WITH APPLICABLE INFFPC, FBC-BUILDING AND FBC ACCESSIBILITY
- 2 ALL DOORS AND HARDWARE TO COMPLY WITH A.D.A. AND CODE OF FEDERAL REGULATION, UTILIZING A LEVER LATCH OR LOCKSET SUCH AS:
- DOOR HARDWARE. HANDLES, PULLS, LATCHES, LOCKS, AND OTHER OPERATING DEVICES ON ACCESSIBLE DOORS SHALL HAVE A SHAPE THAT IS EASY TO GRASP WITH ONE HAND AND DOES NOT REQUIRE TIGHT GRASPING, TIGHT PINCHING, OR TWISTING OF THE WRIST TO OPERATE. LEVER-OPERATED MECHANISMS, PUSH-TYPE MECHANISMS, AND U-SHAPED HANDLES ARE ACCEPTABLE DESIGNS. HARDWARE REQUIRED FOR ACCESSIBLE DOOR PASSAGE SHALL BE MOUNTED BETWEEN 34 TO 48 INCHES ABOVE FINISH FLOOR

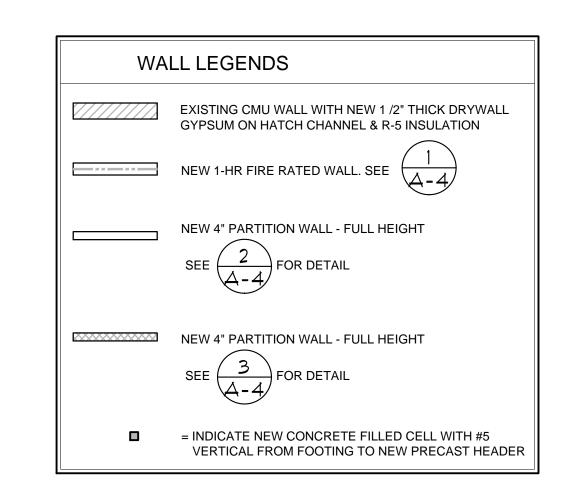

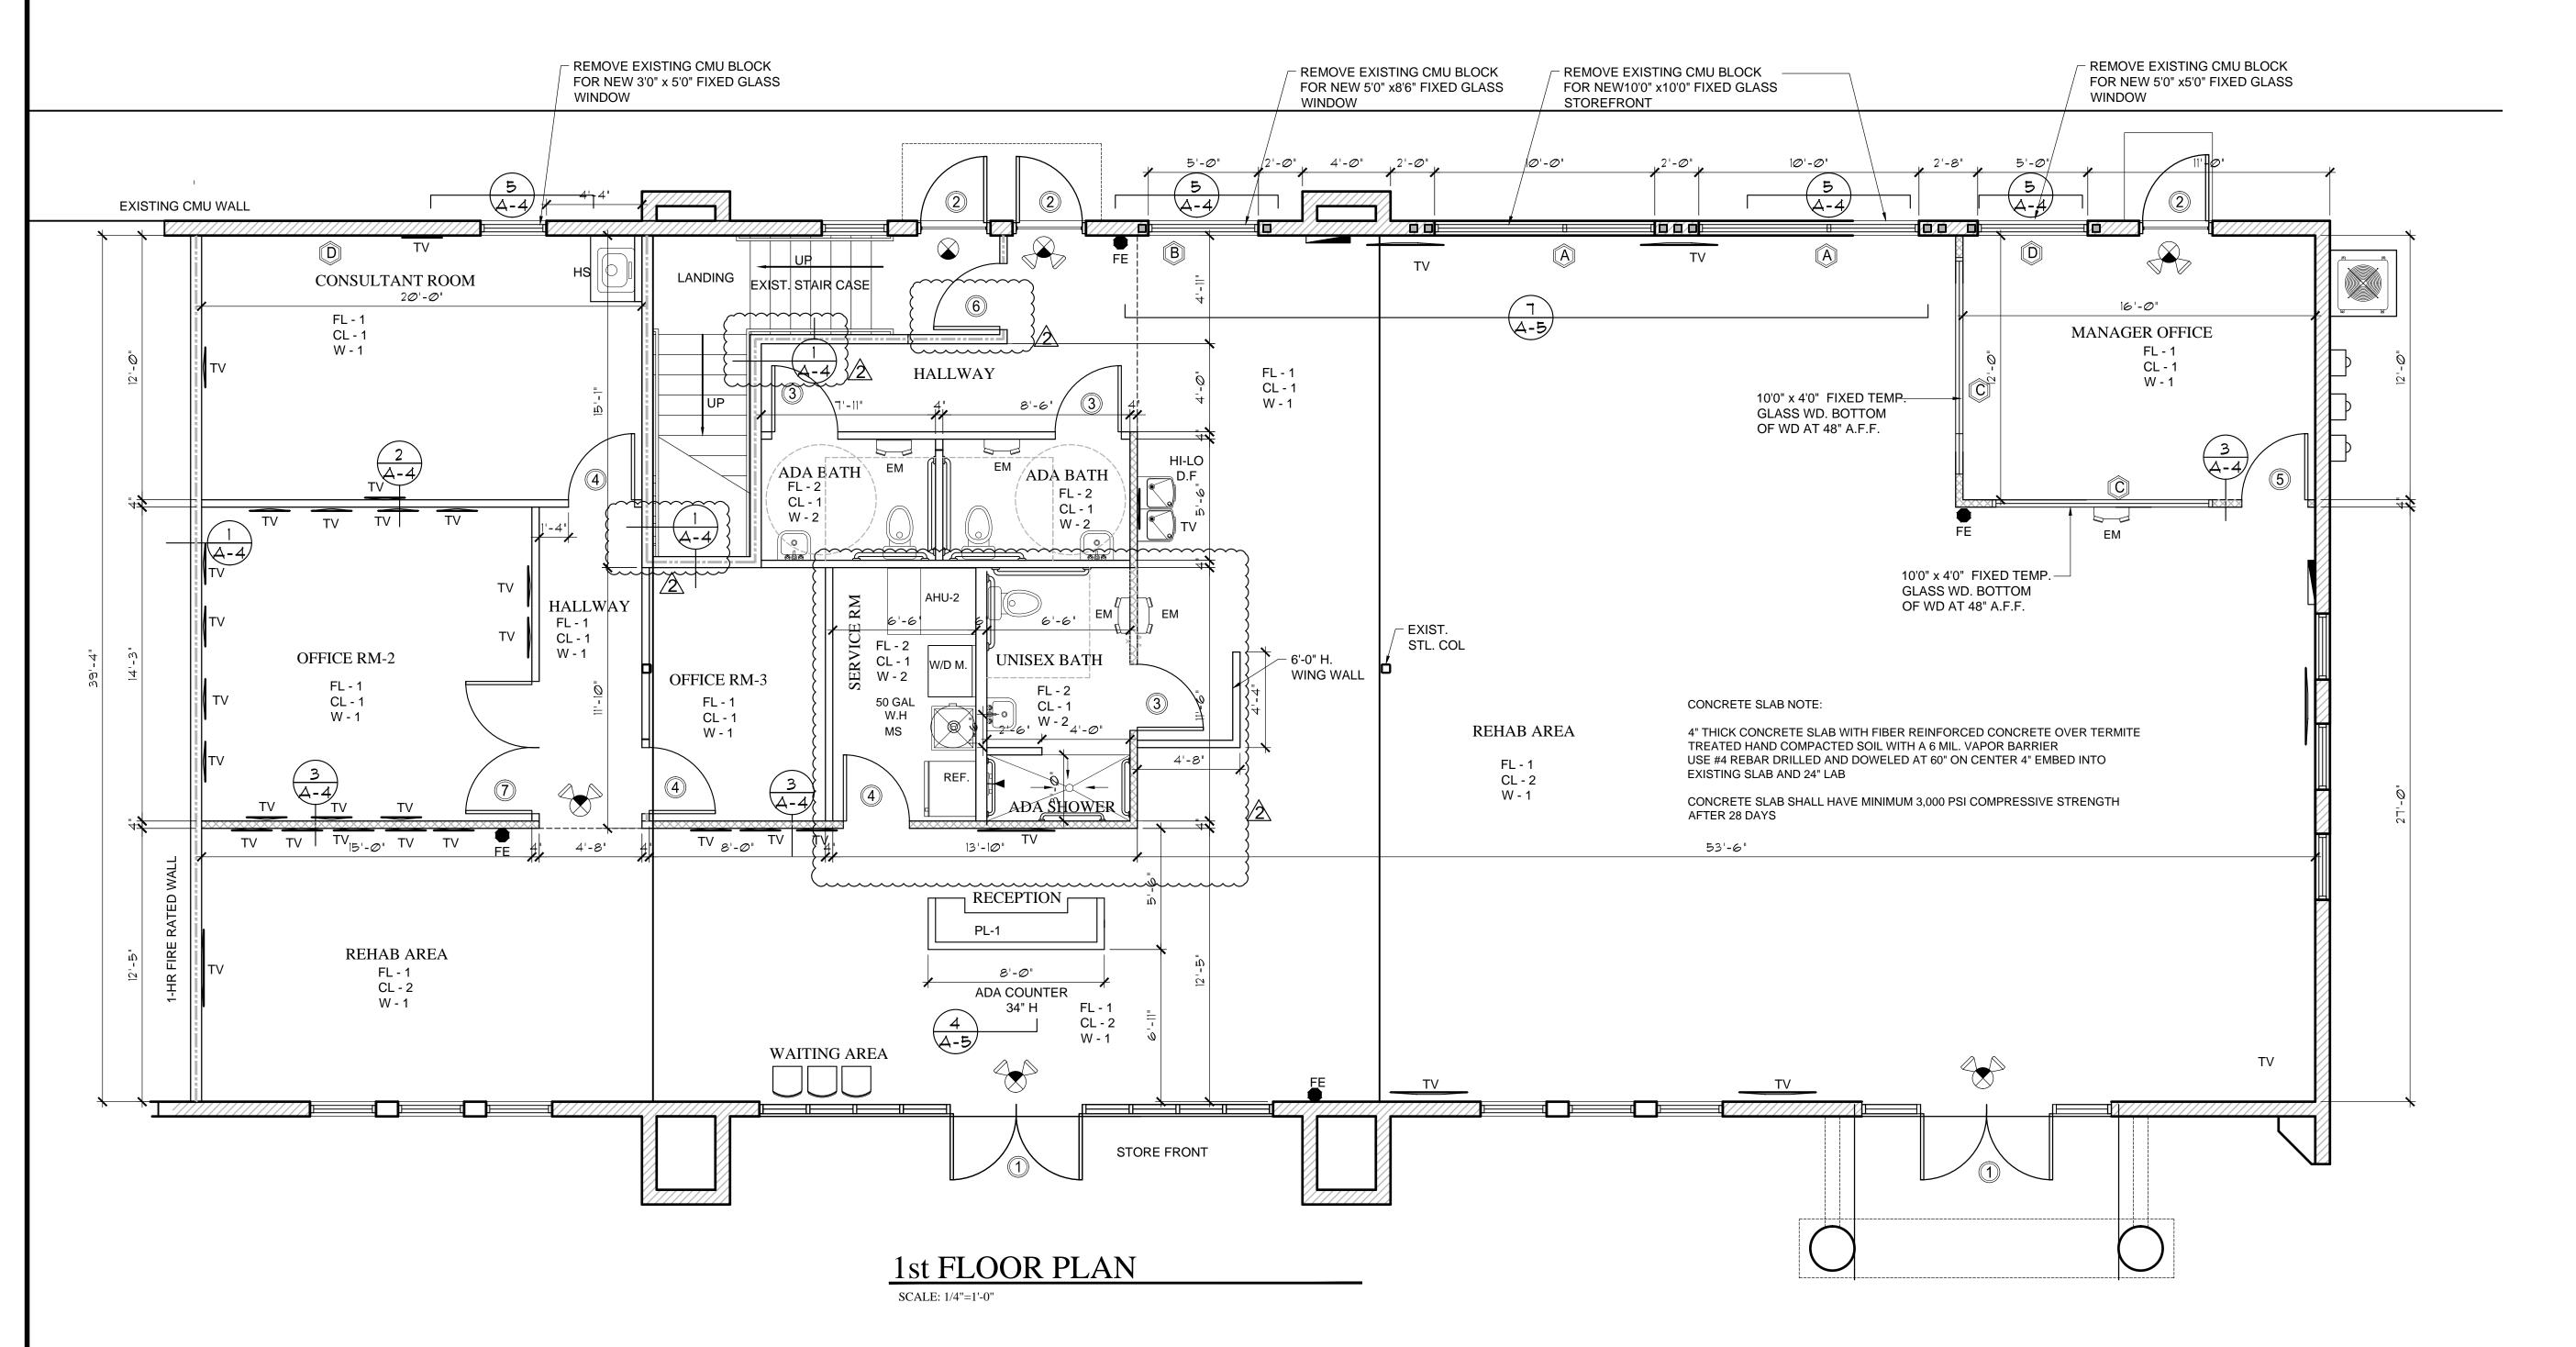

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To the best of the knowledge of the Engineer or Architect the plans and specifications herein comply with the 2017 Florida building code and are Signed and Sealed accordingly. KL ENGINEERING FLORIDA C.A #33303 427 Palm Crest Lane Samur. Fl 32746	Phone (407) 361-8017, email: klengineering11@gmail.com \triangle
To the best of the knowledge of the Engineer or Architect the plans and specifications herein comply with the 2017 Florida building code and are Signed and Sealed accordingly. KL ENGINEERING FLORIDA C.A #33303 427 Palm Crest Lane Lake Mary, Fl 32746	
	Lake Mary, rt 32/40 100e (407) 361-8017, email: klengineering11@gmail.com
Date: 4-14-2021	
BIONETIC ENHANCEMENT CENTER 10030 WELLNESS WAY, SUITE #120 ORLANDO, FL FLOOR PLAN	
DRAWN KL CHECKED	
CAD FILE A-1 PROJECT	
DRAWING NUMBER A 1	
DATE 8-25-20	
_	

	WALL / CEILING
W - 1	PAINT INTERIOR WALLS, DOOR AND FRAMES WITH SHERWIN WILLIAMS OR EQUAL. COLOR BY TENANT
W - 2	CERAMIC TILE BY TENANT
CL-1	SUSPENDED 2X2 ARMSTRONG DUNE 1775 9/16 BEVELED TEGULAR TILES.
CL-2	OPEN CEILING TO ROOF DECK
	FLOOR
FL - 1	VINYL LAMINATE FLOOR. COLOR TBD.
FL - 2	CERAMIC TILE BY TENANT
B - 1	NEW 4" VINYL BASE, COLOR TBD.
	PLASTIC LAMINATE
PL-1	BASE/ UPPER/ COUNTERTOP - MILLWORK LAMINATES, TBD
	MISC

201.1.1VERTICAL ACCESSIBILITY.

Sections 553.501-553.513, F.S., and the ADA Standards for Accessible Design do not relieve the owner of any building, structure or facility governed by those sections from the duty to provide vertical accessibility to all levels above and below the occupiable grade level regardless of whether the Standards require an elevator to be installed in such building, structure or facility, except for:

- 1. Elevator pits, elevator penthouses, mechanical rooms, piping or equipment catwalks and automobile lubrication and maintenance pits and platforms.
- Unoccupiable spaces, such as rooms, enclosed spaces and storage spaces that are not designed for human occupancy, for public accommodations or for work
- Occupiable spaces and rooms that are not open to the public and that house no more than five persons, including, but not limited to equipment control rooms and projection booths

NOTE: THE 2nd FLOOR) SHALL BE USED FOR MANAGER OFFICE ONLY THERE SHALL NOT BE MORE THAN 5 PEOPLE ALLOWED ON THE SECOND FLOOR

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33'-6" - EXIST. STAIR CASE 28'-1" ─ 1 HR. FIRE RATED WALL ACCESSORY / FILE STORAGE 580 SF - GROUP S-2 OCCUPANT LOAD = 1 EXECUTIVE MANAGER OFFICE 540 SF - GROUP B MAX. OCCUPANT LOAD = 4 FL - 1 CL - 1 W - 1 EXISTING FIXED GLASS WINDOW



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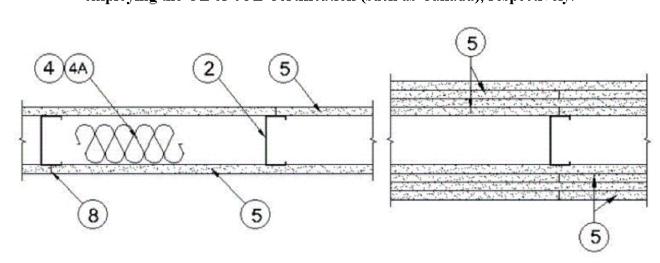
	TION	S COMMENT	COMMENT		
	DESCRIPTION	12-20-20 RESPOND TO COUNTY'S COMMENT	RESPOND TO COUNTY'S COMMENT		
	REV DATE	\triangle 12-20-20	4-14-21	\$	A
	To the best of the knowledge of the Engineer or Architect the plans and specifications herein comply with the 2017	Florida building code and are Signed and Sealed accordingly.	KL ENGINEERING	FLUKIDA C.A #35303 427 Palm Crest Lane	Lake Mary, Fl 32746 Phone (407) 361-8017, email: klengineering11@gmail.com
	PR	ROFES	SION	AL SE	
	Da	te: 4-	14-20	21	
	BIONETIC ENHANCEMENT CENTER 10030 WELLNESS WAY, SUITE #120		OKLANDO, FL	FLOOR PLAN	
	СНЕ	AWN ECKED		KL	
- 1	CAI) FILE		A-2	•
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DATE

Design No. U419 September 28, 2018

Nonbearing Wall Ratings — 1, 2, 3 or 4 Hr (See Items 4 & 5 through 5K)

* Indicates such products shall bear the UL or cUL Certification Mark for jurisdictions employing the UL or cUL Certification (such as Canada), respectively.



- 1. Floor and Ceiling Runners (Not Shown) For use with Item 2 Channel shaped, fabricated from min 25 MSG corrosion-protected steel, min depth to accommodate stud size, with min 1-1/4 in. long legs, attached to floor and ceiling with fasteners 24 in. OC max.
- 2. Steel Studs Channel shaped, fabricated from min 25 MSG corrosionprotected steel, min depth as indicated under Item 5, spaced a max of 24 in. OC. Studs to be cut 3/8 to 3/4 in. less than assembly height.
- 4. Batts and Blankets* (Required as indicated under Item 5) Mineral wool batts, friction fitted between studs and runners. Min nom thickness as indicated under Item 5.
- See Batts and Blankets (BKNV or BZJZ) Categories for names of Classified companies.
- 4A. Batts and Blankets* (Optional) Placed in stud cavities, any glass fiber or mineral wool insulation bearing the UL Classification Marking as to Surface Burning Characteristics and/or Fire Resistance.

5. **Gypsum Board*** — Gypsum panels with beveled, square or tapered edges, applied vertically or horizontally. Vertical joints centered over studs and staggered one stud cavity on opposite sides of studs. Vertical joints in adjacent layers (multilayer systems) staggered one stud cavity. Horizontal joints need not be backed by steel framing. Horizontal edge joints and horizontal butt joints on opposite sides of studs need not be staggered. Horizontal edge joints and horizontal butt joints in adjacent layers (multilayer systems) staggered a min of 12 in. The thickness and number of layers for the 1 hr, 2 hr, 3 hr and 4 hr ratings are as follows:

Gypsum Board Protection on Each Side of Wall

Rating, Hr	Min Stud Depth, in. Items 2, 2C, 2D, 2F, 2G, 2O	No. of Layers & Thkns of Panel	Min Thkns of Insulation (Item 4)
1	3-1/2	1 layer, 5/8 in. thick	Optional
1	2-1/2	1 layer, 1/2 in. thick	1-1/2 in.
1	1-5/8	1 layer, 3/4 in. thick	Optional
2	1-5/8	2 layers, 1/2 in. thick	Optional

- 6. **Fasteners** (Not Shown) For use with Items 2 and 2F Type S or S-12 steel screws used to attach panels to studs (Item 2) or furring channels (Item 7). Single layer systems: 1 in. long for 1/2 and 5/8 in. thick panels or 1-1/4 in. long for 3/4 in. thick panels, spaced 8 in. OC when panels are applied horizontally, or 8 in. OC along vertical and bottom edges and 12 in. OC in the field when panels are applied vertically. **Two layer systems:** First layer- 1 in. long for 1/2 and 5/8 in. thick panels or 1-1/4 in. long for 3/4 in. thick panels, spaced 16 in. OC. Second layer- 1-5/8 in. long for 1/2 in., 5/8 in. thick panels or 2-1/4 in. long for 3/4 in. thick panels, spaced 16 in. OC with screws offset 8 in. from first layer. Threelayer systems: First layer- 1 in. long for 1/2 in., 5/8 in. thick panels, spaced 24 in. OC. Second layer- 1-5/8 in. long for 1/2 in., 5/8 in. thick panels, spaced 24 in. OC. Third layer- 2-1/4 in. long for 1/2 in., 5/8 in. thick panels or 2-5/8 in. long for 5/8 in. thick panels, spaced 12 in. OC. Screws offset min 6 in. from layer below. Four-layer systems: First layer- 1 in. long for 1/2 in., 5/8 in. thick panels, spaced 24 in. OC. Second layer- 1-5/8 in. long for 1/2 in., 5/8 in. thick panels, spaced 24 in. OC. Third layer- 2-1/4 in. long for 1/2 in. thick panels or 2-5/8 in. long for 5/8 in. thick panels, spaced 24 in. OC. Fourth layer- 2-5/8 in. long for 1/2 in. thick panels or 3 in. long for 5/8 in. thick panels, spaced 12 in. OC. Screws offset min 6 in. from layer below.
- 8. **Joint Tape and Compound** Vinyl or easein, dry or premixed joint compound applied in two coats to joints and screw heads of outer layers. Paper tape, nom 2 in. wide, embedded in first layer of compound over all joints of outer layer panels. Paper tape and joint compound may be omitted when gypsum panels are supplied with a square edge.
- 10. Caulking and Sealants* (Optional, Not Shown) A bead of acoustical sealant applied around the partition perimeter for sound control.

4" x 25 GA. MTL. DIAG. FRM'G AT 32"

O.C. ATTACHED TO STL. JOIST

1. USE #7X7/16" PAN HEAD TYPE "S" FRAMING SCREW FOR STEEL STUD

2. USE #6X1-1/4" TYPE "S" DRYWALL SCREWS TO STEEL FRAMING.

MEMBER, LATEST EDITION.

3. METAL MEMBERS TO BE I ACCORDANCE

WITH THE AISI SPECIFICATIONS FOR THE DESIGN OF COLD FORMED STRUCTURED

4. METAL MEMBERS TO BE IN ACCORDANCE

FOR NONSTRUCTURAL STEEL FRAMING

WITH ASTM C645 STANDARD SPECIFICATIONS

CEILING LINE

TO STEEL TRACT.

MEMBERS 2000

@ 16" O.C.

NEW INTERIOR PARTITION WALL

CONC. SLAB


1/2" GYPSUM BOARD

4" METAL STUD 25 GAGE 16" O.C.

COVER BOTH SIDES WITH 1/2 **GYPSUM BOARDS PAINTED**

- 3/16"X 1-1/4" MASONRY SCREWS

OR POWDER ACTUATED SCREWS

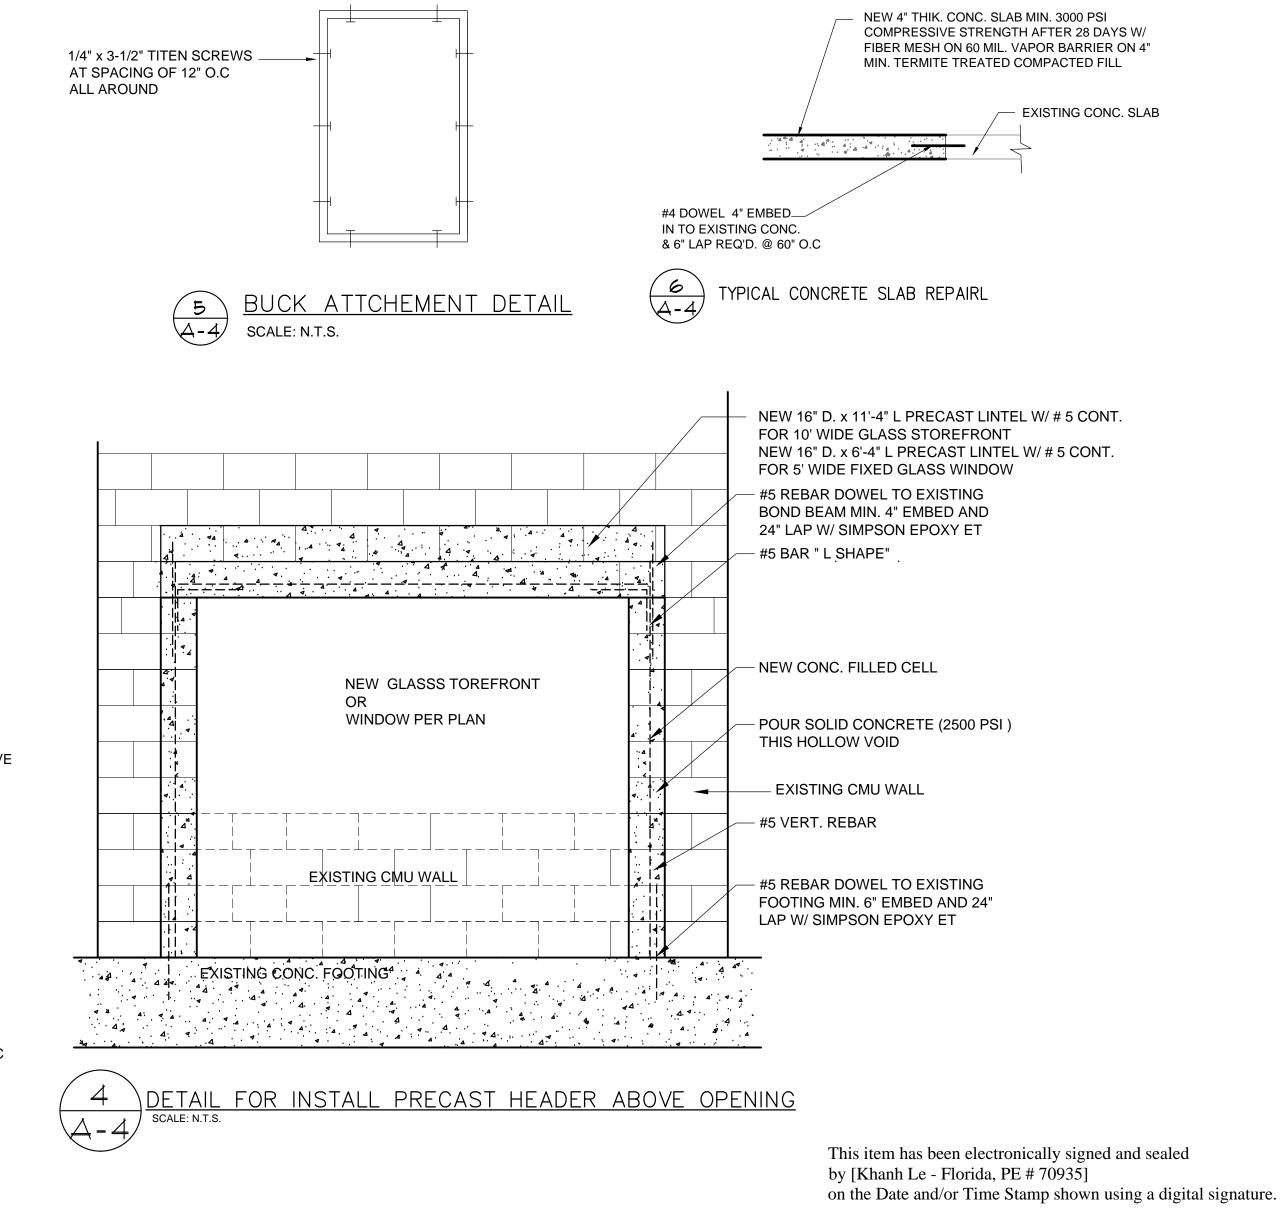

PROFESSIONAL SEAL

Date: 4-14-2021

NHANCEMENT

DRAWN

CAD FILE

PROJECT

DATE

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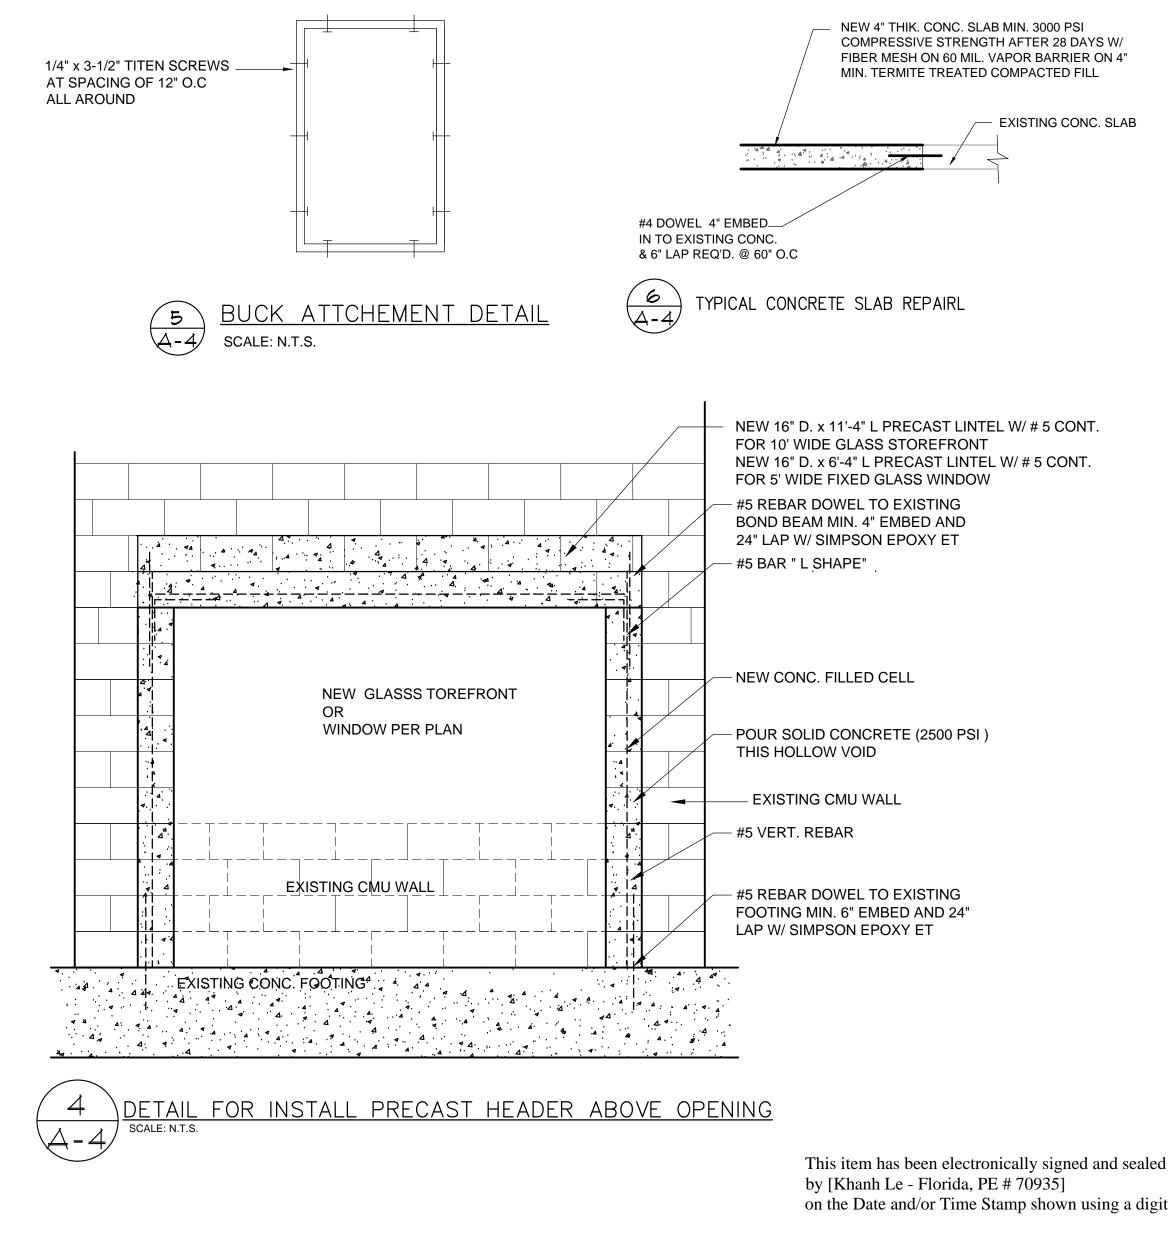
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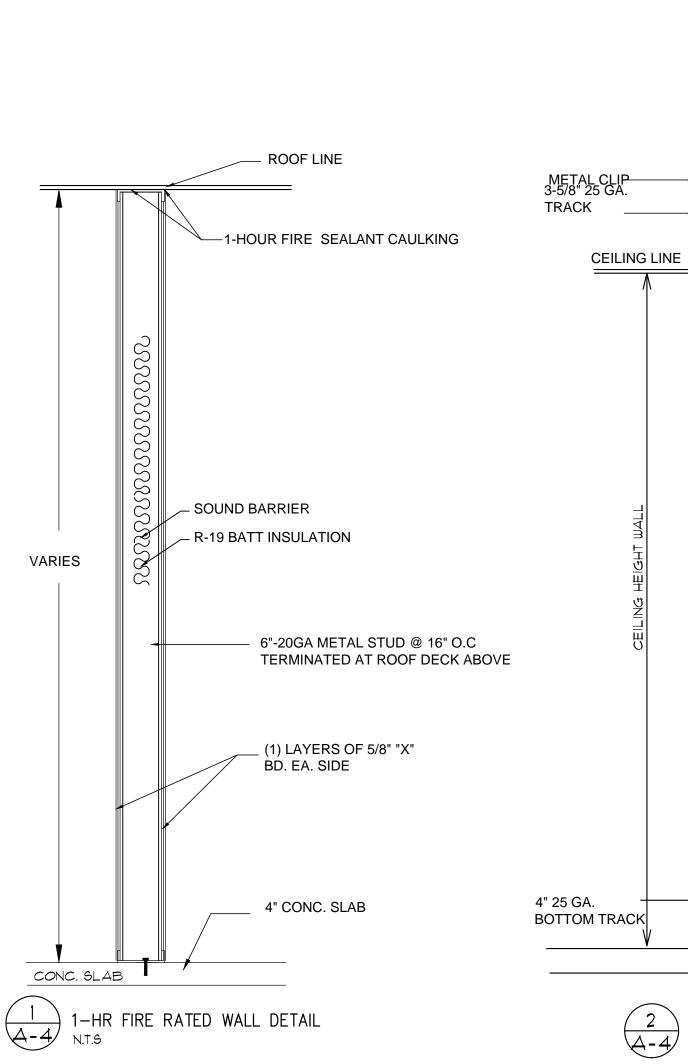
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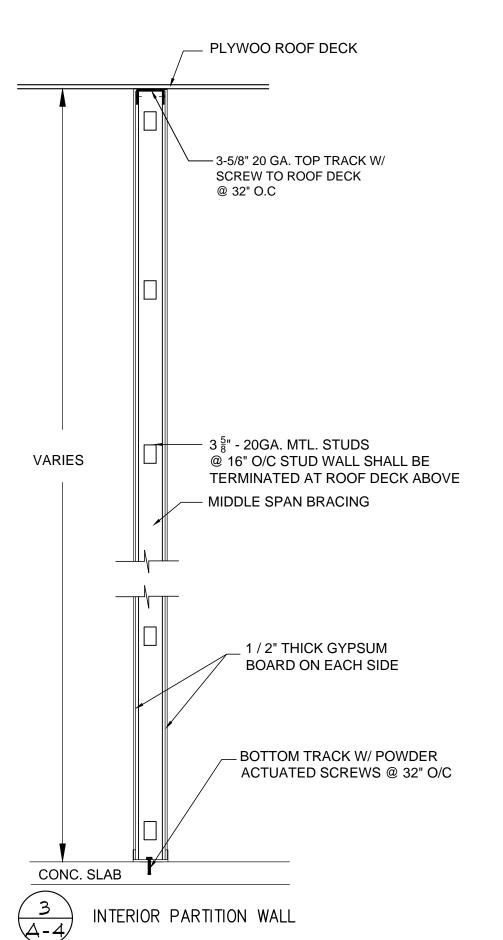
8-25-20


DETAIL

GENERAL








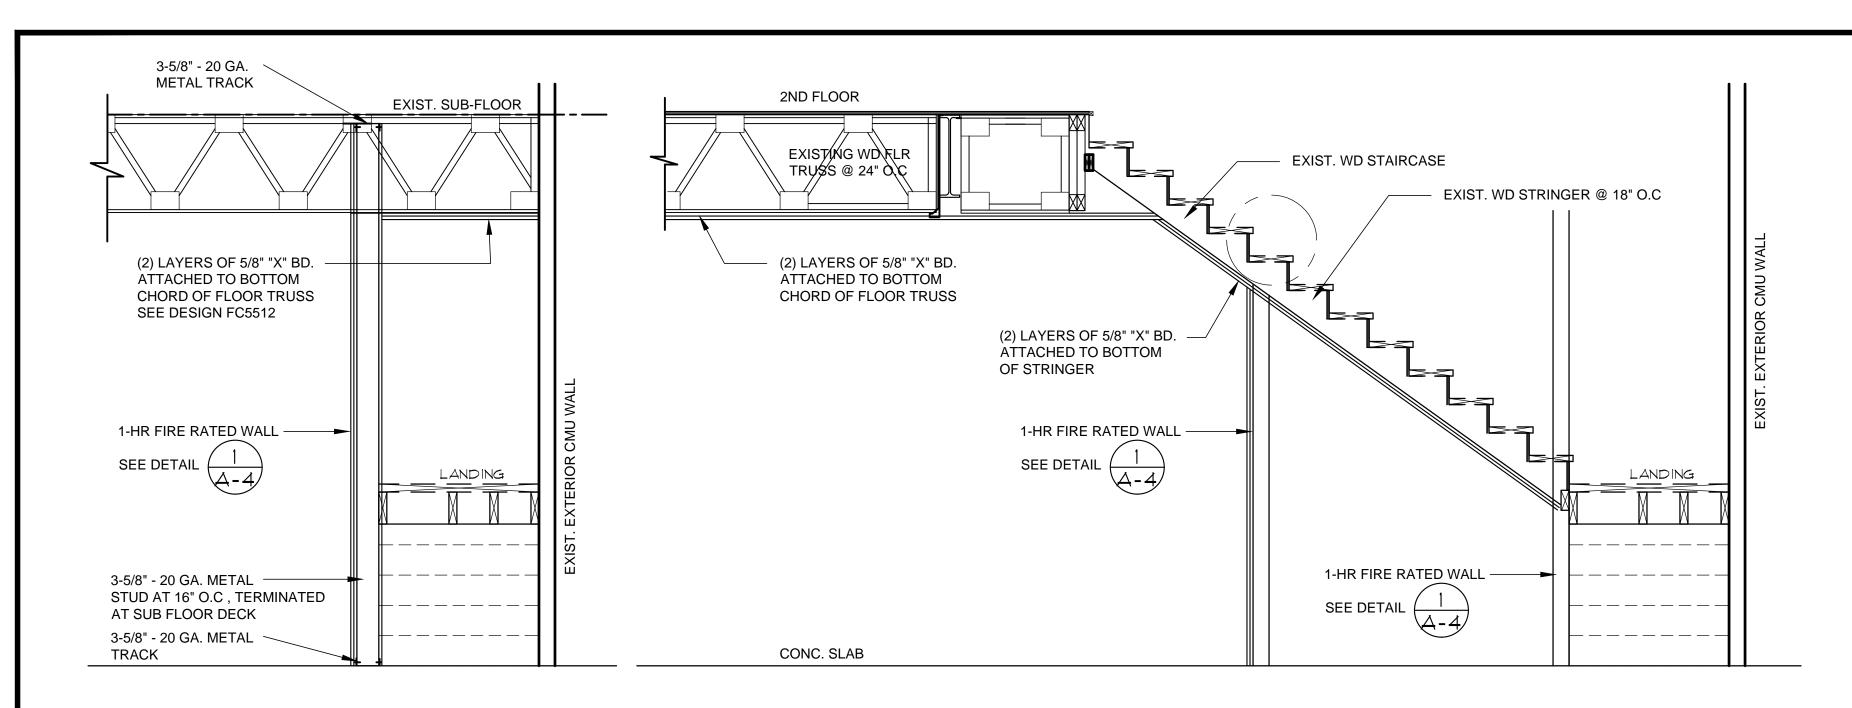

INTERIOR PARTITION WALL

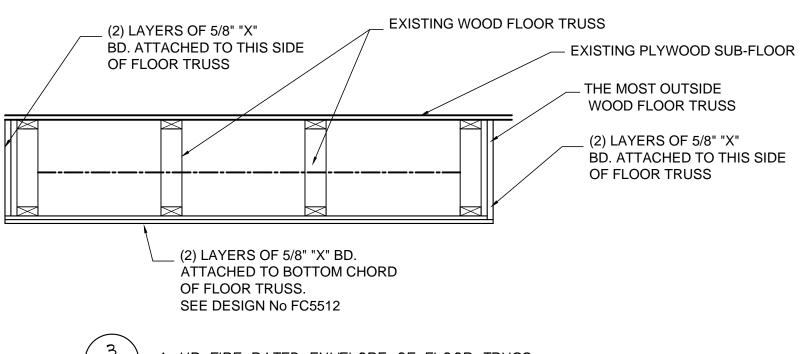


1-HR FIRE RATED STAIR CASE 1-HR FIRE RATED ENVELOPE OF FLOOR TRUSS

EXISTING WOOD FLOOR TRŲSSES AT 24" Φ.C EXISTING STEEL BEAM - HATCH INDICATES THE FLOOR TRUSSES TO BE 1-HR FIRE RATED

> FLOOR TRUSS FRAMING PLAN SCALE: 1/4"=1'-0"

GA-600-2009 FIRE RESISTANCE DESIGN MANUAL

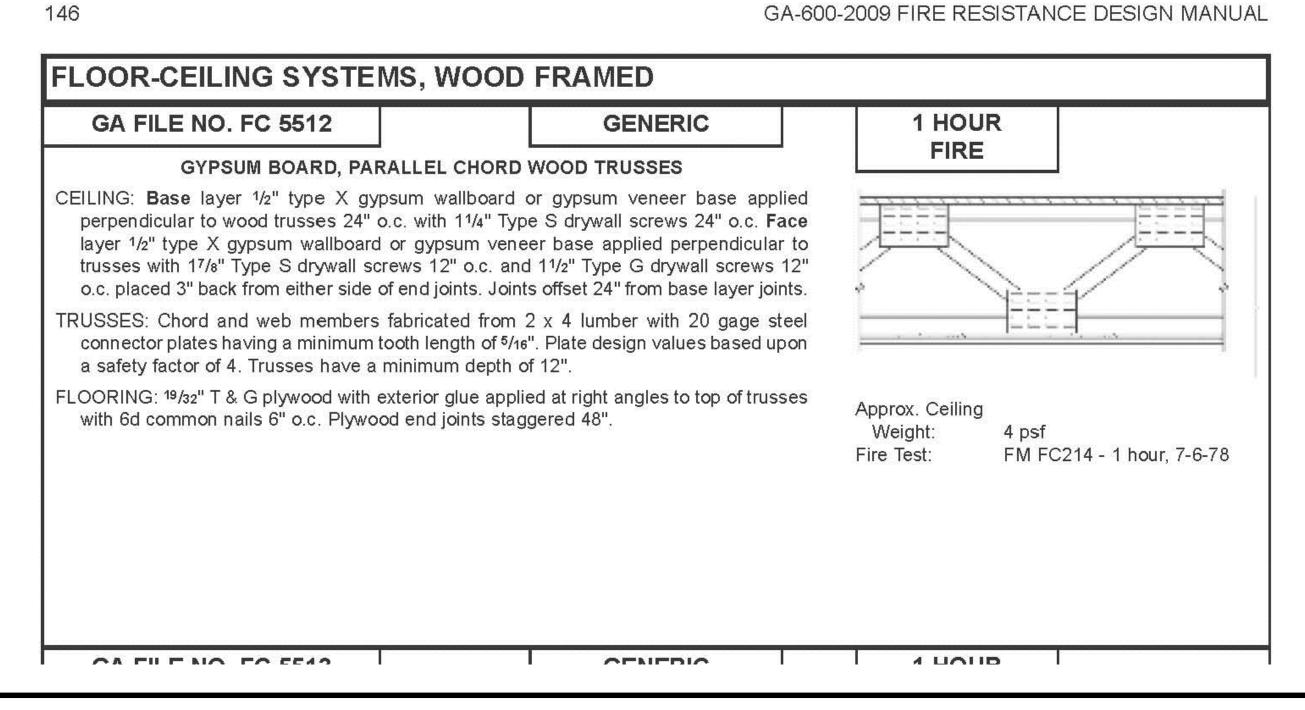

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Date: 4-14-2021 **PROTECTION** FRAMING] FLOOR CAD FILE PROJECT DRAWING NUMBER

DATE

8-25-20

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