

October 20, 2014

Mr. Jim Richmond
Florida Department of Business and Professional Regulation
Manufactured Building Program
1940 North Monroe Street
Suite 90A
Tallahassee. Florida 32399-0772

RE: Plan Approval: Residential Lawn Storage Shed

Manufacturer: MCS Portable Buildings, LLC

Plan Number: PG-150 AL

Dear Mr. Richmond,

Pursuant to the requirements of the Florida Department of Business and Professional Regulations, the above referenced documents have been reviewed for compliance with:

2010 Florida Building Code with 2012 Supplements 2008 National Electrical Code (NFPA-70)

These plans comply with Florida Product Approval Rule 61G20-3.006 (FAC)

A signed and sealed set of plans are maintained on file in the Third Party Agency office of PSI.

All mandatory comments have been satisfied and plans are approved for construction by a modular building manufacturer that is currently approved by the Department of Business and Professional Regulations.

If you have any questions or require my assistance in any way, please do not hesitate to contact me.

Respectfully submitted,

William E. Neary, Ill'
Department Manager
Modular Facilities Division

Copy to: Burtice Bright - bbright@gracelandpb.com

CODE CRITERIA:

THE CONTRACTOR/MANUFACTURER SHALL COMPLY WITH THE FOLLOWING CODES AND ALL APPLICABLE AMENDMENTS/SUPPLEMENTS:

FLORIDA BUILDING CODE 2010 - BUILDING FLORIDA BUILDING CODE 2010 - RESIDENTIAL FLORIDA BUILDING CODE 2010 - CHAPTER 11

ACCESSIBILITY CODE FOR BUILDING CONSTRUCTION FLORIDA BUILDING CODE 2010 - CHAPTER 13

ENERGY EFFICIENCY FOR BUILDING CONSTRUCTION FLORIDA BUILDING CODE 2010 - GAS FLORIDA BUILDING CODE 2010 - MECHANICAL FLORIDA BUILDING CODE 2010 - PLUMBING NATIONAL ELECTRIC CODE 2011 - (NFPA 70) LIFE SAFETY CODE 2012 EDITION (NFPA 101) FLORIDA FIRE PREVENTION CODE 2010

PROJECT NOTE:

THIS BUILDING IS NOT DESIGNED FOR HUMAN HABITATION AND DOES NOT HAVE WATER, SEWER, ELECTRICAL OR HVAC SYSTEMS. THIS BUILDING IS DESIGNED AS A MINOR STORAGE OCCUPANCY ONLY.

GENERAL NOTES:

- 1. STRUCTURE HAS BEEN DESIGNED IN ACCORDANCE WITH THE FLORIDA BUILDING CODE, 2010 W/ 2012 SUPPLEMENTAL.
- 2. ALL MATERIALS AND LABOR SHALL BE IN ACCORDANCE WITH THE ABOVE CODE AND ALL OTHER APPLICABLE LOCAL CODES AT THE TIME OF MANUFACTURE.
- 3. DRAWINGS SHALL NOT BE SCALED FOR DIMENSIONS.
- 4. STRUCTURES ARE CLASSIFIED AS "MINOR STORAGE FACILITIES" (OCCUPANCY CATEGORY I) AND SHOULD NOT BE USED FOR HUMAN HABITATION.

THESE PLANS WERE DESIGNED IN ACCORDANCE WITH THE 2010 FLORIDA BUILDING CODE W/ 2012 SUPPLEMENTAL FOR A THREE SECOND

- 5. STRUCTURES ARE DESIGNED FOR LOCATIONS THAT HAVE A 3 SECOND WIND GUST OF 150 MPH (MAX). STRUCTURES SHOULD NOT BE USED IN OTHER LOCATIONS.
- 6. STRUCTURES ARE DESIGNED FOR LOCATIONS WITH A SURFACE ROUGHNESS CATEGORY B AND A TOPOGRAPHICAL FACTOR OF 1.0. STRUCTURES SHOULD NOT BE USED IN OTHER LOCATIONS.
- 7. STRUCTURES ARE DESIGNED FOR LOCATIONS THAT ARE NOT IN FLOOD HAZARD AREAS. STRUCTURES SHOULD NOT BE USED IN OTHER LOCATIONS.
- 8. STRUCTURES SHOULD HAVE METAL ROOF OR OPTIONAL 25 YEAR RATED FIBERGLASS/ASPHALT SHINGLES.
- 9. ALL STUDS, RAFTERS, COLLAR TIES, AND TRUSS CHORDS ARE SPF #2, U.N.O.
- 10. ALL EXTERIOR WOOD IS TO BE PRESSURE TREATED.
- 11. ALL ROOF DECKING IS TO BE $\frac{7}{6}$ " O.S.B.
- 12. ALL SIDING IS TO BE %" P.T. T-III PLYWOOD OR DURATEMP.
- 13. ALL FLOOR JOISTS ARE TO BE P.T. SYP #2.
- 14. ALL EXTERIOR NAILS ARE TO BE HOT DIPPED GALVANIZED.
- 15. ALL FLOOR DECKING IS TO BE %" P.T. PLYWOOD.
- 16. ALL SKIDS ARE TO BE 4x6 P.T. SYP, RATED FOR GROUND CONTACT.
- 17. THE STRUCTURE HAS BEEN DESIGNED TO RESIST LOADS AS A COMPLETED STRUCTURE ONLY. APPLICATION OF CONSTRUCTION LOADS TO THE PARTIALLY COMPLETED STRUCTURE SHALL BE CONSIDERED BY THE CONTRACTOR AND INCLUDED IN THE DESIGN OF SHORING, BRACING, FORM WORK, AND OTHER SUPPORTING ELEMENTS PROVIDED FOR CONSTRUCTION OF THE STRUCTURE.
- 18. NO FIELD SUPERVISION OR CONSTRUCTION ADMINISTRATION HAS BEEN PROVIDED BY THE ENGINEER.

DESIGN CRITERIA:

- 1. FLORIDA BUILDING CODE 2010, W/ 2012 SUPPLEMENTAL
- 2. DEAD LOADS: FLOOR: 10 PSF LOFT: 5 PSF ROOF: 10 PSF
- 3. LIVE LOADS: FLOOR: 40 PSF LOFT: 10 PSF ROOF: 20 PSF (REDUCIBLE)
- 4. SNOW LOADS: GROUND SNOW LOAD, Pg=25psf

FLAT ROOF SNOW LOAD, Pf=20psf SNOW EXPOSURE FACTOR, Ce=1.2 SNOW LOAD IMPORTANCE FACTOR, I=0.8 THERMAL FACTOR, Ct=1.2

5. WIND LOADS:

BASIC WIND SPEED. V=150 MPH RISK CATEGORY = I WIND EXPOSURE B C&C ROOF-ZONE 1=23.3, -37.0 psf C&C ROOF-ZONE 2=23.3, -64.5 psf C&C ROOF-ZONE 3=23.3, -95.4 psf C&C WALL-ZONE 4=40.5, -43.9 psf C&C WALL-ZONE 5=40.5, -54.2 psf

6. SEISMIC LOADS: THIS STRUCTURE IS EXEMPT FROM SEISMIC DESIGN PER EXEMPTION 3 OF ASCE 7-10. SECTION 11.1.2

ITEMS BY OTHERS:

THE FOLLOWING ITEMS ARE NOT PROVIDED BY RAILROAD CONSULTANTS, PLLC AND ARE TO BE DESIGNED BY OTHERS IF APPLICABLE AND ARE TO BE SUPPLIED AND INSTALLED BY OTHERS. THESE ITEMS MAY BE SUBJECT TO LOCAL JURISDICTION APPROVAL. RAILROAD CONSULTANTS, PLLC IS NOT RESPONSIBLE THESE ITEMS.

- 1. RAMPS, STAIRS, AND GENERAL ACCESS
- 2. ELECTRICAL SERVICE HOOKUP

BUILDING SIZES:


10' WIDTH	14' NOMINAL WIDTH*
10'×24'	*NOTE:(13'-0 ACTUAL)
	14'x24'
	14'x28'
	14'x32'
12' NOMINAL WIDTH**	14'x36'
**NOTE:(11'-2 ACTUAL)	14'×40'
12'x20'	
12'x24'	16' NOMINAL WIDTH*
12'x28'	*NOTE:(15'-0 ACTUAL)
12'x32'	16'x24'
12'x40'	16'x28'
	16'x32'
	16'x36'
	16'x40'

INDEX OF SHEETS:

S-O-PG - COVER SHEET S-1-PG - FOUNDATION PLAN S-2-PG - UPLIFT ANCHORAGE S-3-PG - FRAMING PLAN S-4-PG - BUILDING SECTIONS S-5-PG - ELEVATIONS S-6-PG - NAILING PATTERN S-7-PG - DETAILS S-8-PG - DETAILS



GUST OF 150 MPH

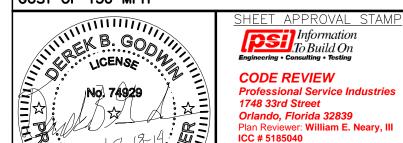

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FL SMI-79, SMP-51

LA #U00406

PORTABLE GARAGE--FL--V=150MPH--FBC 2010

MURFREESBORO, TN 37130 PHONE: (615) 663-1142



GRACELAND PORTABLE BUILDINGS, LLC 6807 HWY 62 WEST BARDWELL, KY 42023 PHONE: (866) 574-7446


PROJECT NO: 14017 DATE: 10-18-14 DRAWN BY: DBG CHECKED BY: TP

REVISION:

SHEET NUMBER

SCALE: 1/4"=1'-0

RAILROAD CONSULTANTS, PLLC 718B SOUTH CHURCH STREET

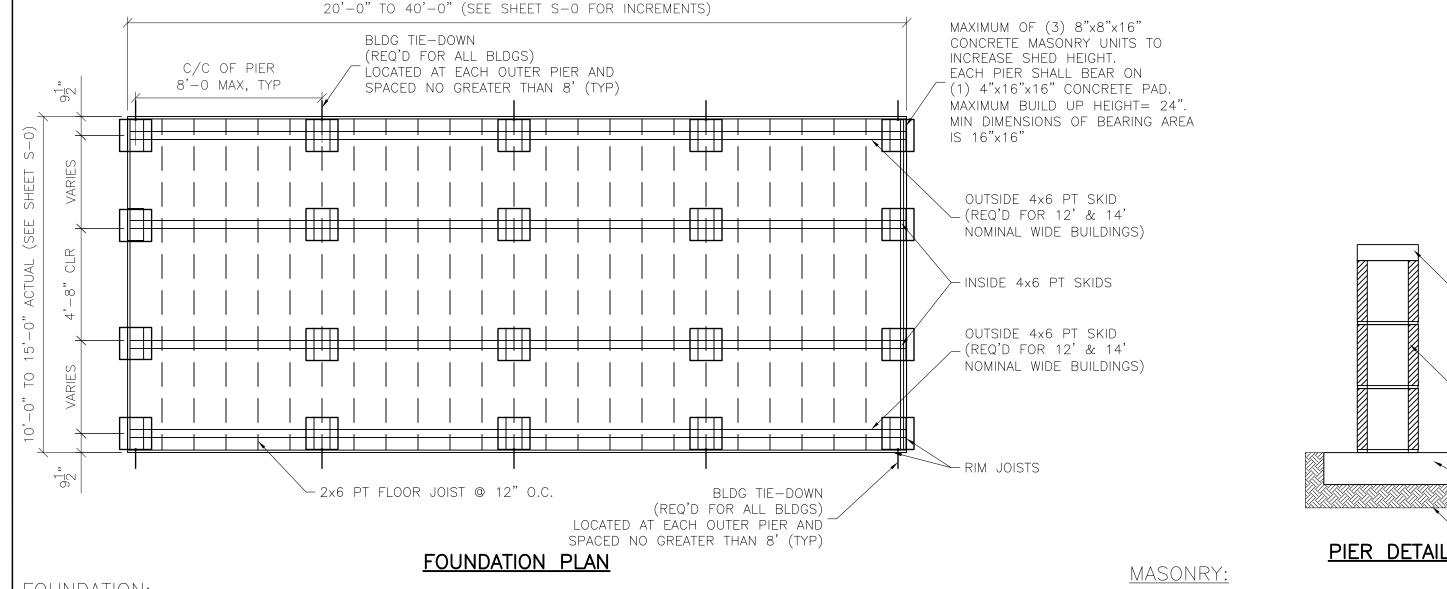

FOUNDATION:

- 1. ANCHORS ARE IRON ROOT DOUBLE HEAD EARTH ANCHORS. PROVIDE ANCHOR AT EACH PERIMETER PIER GIRDER. PROVIDE 1¼" 12 ga OR EQUIVALENT GALVANIZED STRAPS WITH BUCKLE AND SLOTTED PER THE BUILDING CODE.
- 2. ANCHORS AND STRAPS INCLUDING THE INSTALLATION SHALL MEET THE REQUIREMENTS OF APPENDIX E OF THE INTERNATIONAL RESIDENTIAL BUILDING
- 3. THE MINIMUM ALLOWABLE SOIL BEARING CAPACITY OF 2500 psf HAS BEEN ASSUMED FOR FOOTING DESIGN. CONTRACTOR TO HAVE THIS CAPACITY VERIFIED PRIOR TO CONSTRUCTION.
- 4. IF A MINIMUM ALLOWABLE SOIL BEARING CAPACITY OF 1500 psf IS USED, THEN THE PIER SPACING SHALL BE NO GREATER THAN 4'-0. 5. FOOTINGS SHALL BE CARRIED TO AN ELEVATION LOWER THAN THOSE SHOWN ON THE DRAWINGS IF REQUIRED TO REACH SUITABLE SOIL.
- 6. FOOTINGS SHALL BE PLACED ON SUITABLE SOIL THAT MEETS DESIGN ASSUMPTIONS.


CMU f'm = 1.500 PSIMORTAR f'm = 1,900 PSIGROUT f'm = 3,500 PSI

CONCRETE:

1. MATERIALS (COMPRESSIVE STRENGTH AT 28 DAYS) FOOTINGS 3,000 PSI

FOOTINGS AND EXTERIOR CONCRETE SHALL BE AIR-ENTRAINED

THESE PLANS WERE DESIGNED IN ACCORDANCE WITH THE 2010 FLORIDA BUILDING CODE W/ 2012 SUPPLEMENTAL FOR A THREE SECOND GUST OF 150 MPH

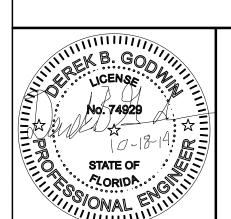

SHEET APPROVAL STAMP PSI Information To Build On Engineering • Consulting • Testing

CODE REVIEW Professional Service Industries 1748 33rd Street

Orlando, Florida 32839 Plan Reviewer: William E. Neary, III ICC # 5185040 LA #U00406 FL SMI-79, SMP-51

PSI APPROVAL 2014-10-20

RAILROAD CONSULTANTS, PLLC 718B SOUTH CHURCH STREET MURFREESBORO, TN 37130 PHONE: (615) 663-1142

GRACELAND PORTABLE **BUILDINGS®**

PORTABLE GARAGE--FL--V=150MPH--FBC 2010

GRACELAND PORTABLE BUILDINGS, LLC 6807 HWY 62 WEST BARDWELL, KY 42023 PHONE: (866) 574-7446 REVISION:

PROJECT NO:	14017
DATE:	10-18-14
DRAWN BY:	DBG
CHECKED BY:	TP

SHEET NUMBER

8"x16" SOLID CAP BLOCK

8" CMU PIER

(3 COURSE MAX)


4"x16"x16" **PRECAST**

FLAT. LEVEL

EXCAVATION

CONCRETE PAD

FREE OF DEBRIS

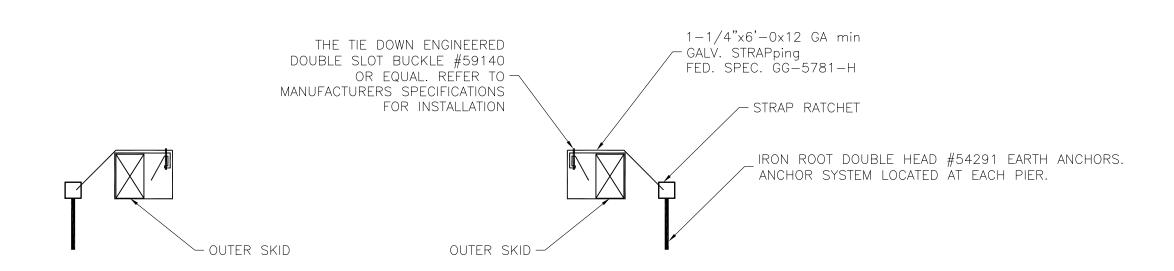

ANCHOR TIE DOWN DETAIL

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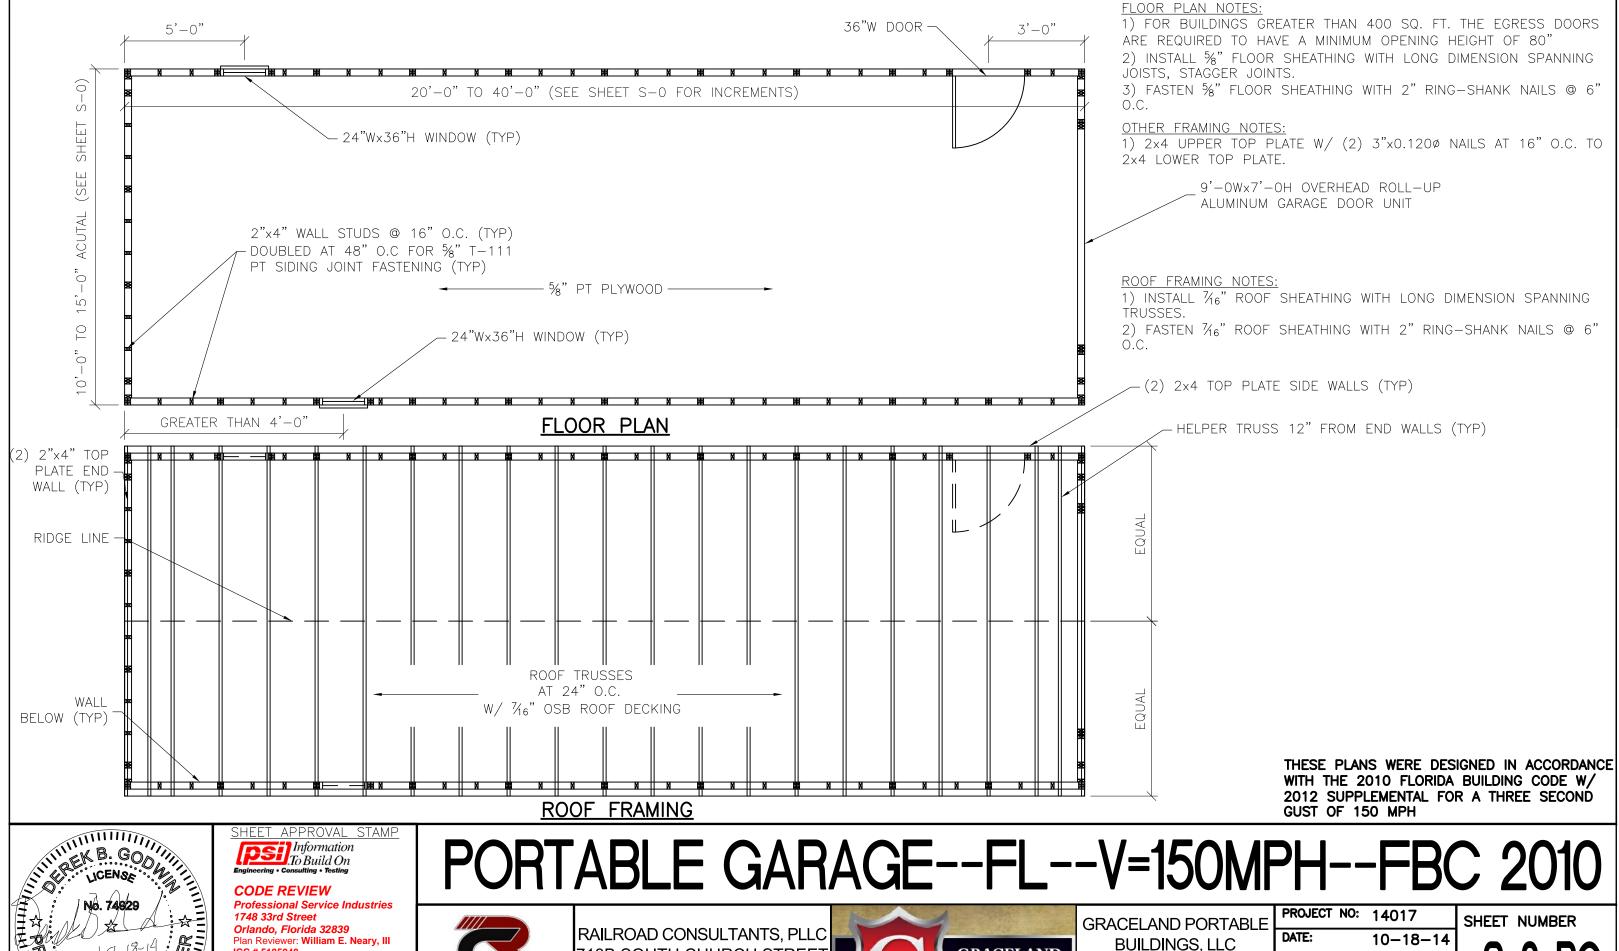
RAILROAD CONSULTANTS, PLLC 718B SOUTH CHURCH STREET MURFREESBORO, TN 37130 PHONE: (615) 663-1142



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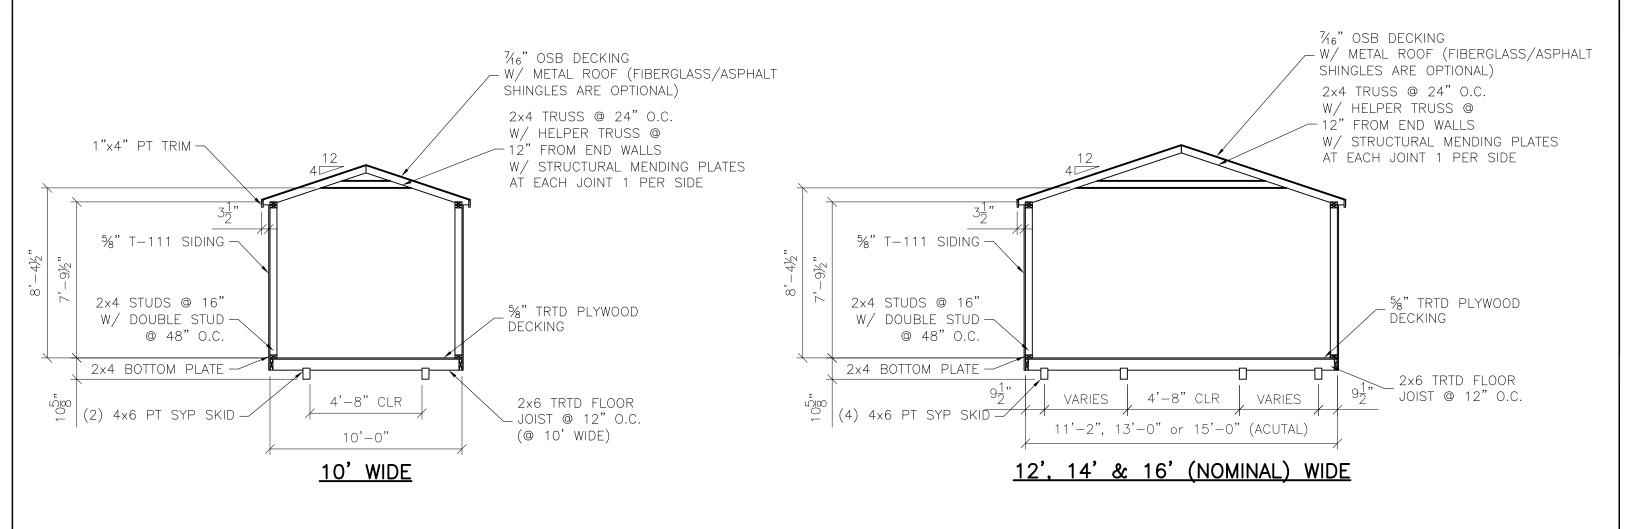


718B SOUTH CHURCH STREET MURFREESBORO, TN 37130 PHONE: (615) 663-1142




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BUILDING SECTIONS

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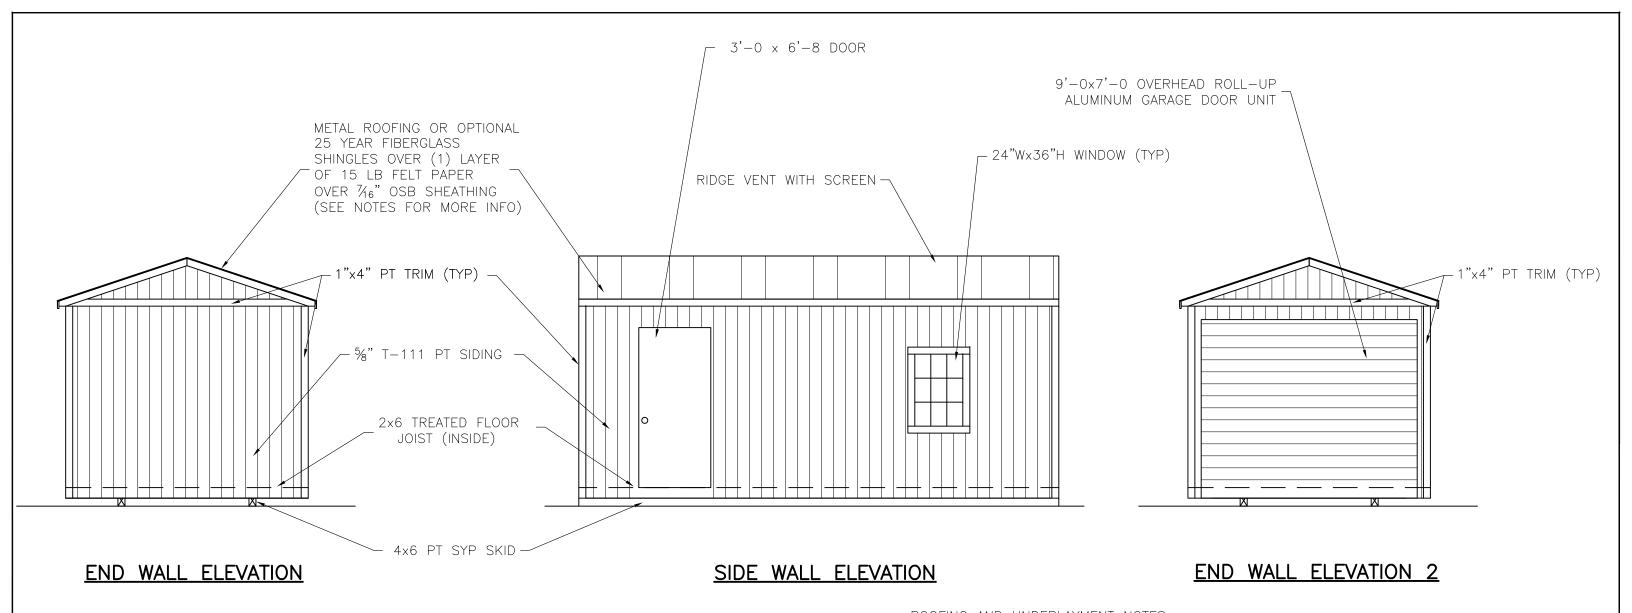


PORTABLE GARAGE--FL--V=150MPH--FBC 2010

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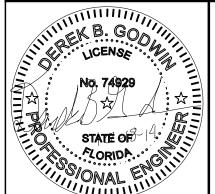


ROOFING AND UNDERLAYMENT NOTES:

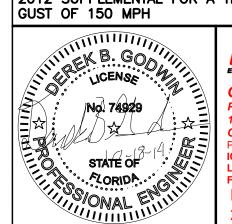PORTABLE GARAGE--FL--V=150MPH--FBC 2010

- 1) PROVIDE A RIDGE VENT TYPICAL WITH INSECT SCREEN.
- 2) METAL ROOFING SHALL BE 29 GAUGE METAL IN ACCORDANCE WITH ASTM A 924 OR ASTM A 924M OVER OSB SHEATHING.
- 3) PROVIDE 29 GAUGE RIDGE CAP, EAVE TRIM AND RAKE TRIM.
- 4) INSTALL AND FASTEN METAL ROOFING PER MANUFACTURER'S INSTRUCTIONS FOR WIND LOADING.
- 5) OPTIONAL SHINGLES SHALL BE IN ACCORDANCE WITH ASTM D 7158 TYPE H OR ASTM D 3161F
- 6) INSTALL 1 LAYER OF 15 LB ROOFING FELT, START WITH A 19" WIDE STRIP PARALLEL WITH AND STARTING AT EAVES FASTENED SECURELY TO HOLD IN PLACE. START AT EAVE WITH A 38" WIDE SHEET WITH OVERLAPPING SUCCESSIVE SHEETS BY 19". FASTEN UNDERLAYMENT WITH CORROSION-RESISTANT FASTENERS PER MAUFACTURER'S INSTRUCTIONS AND SPACED A MAXIMUM OF 36" APART.

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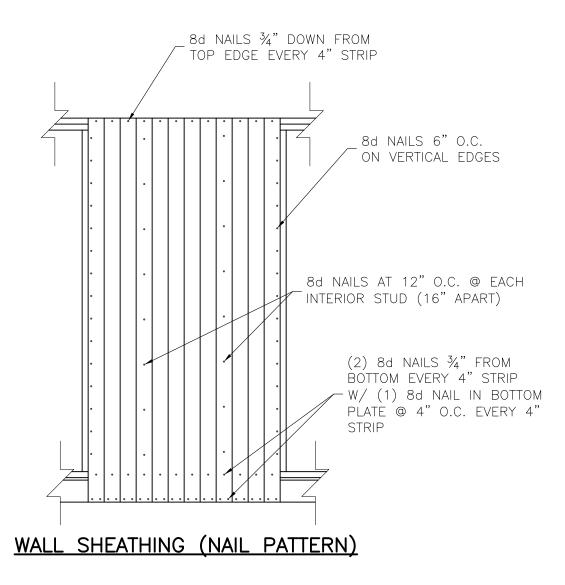
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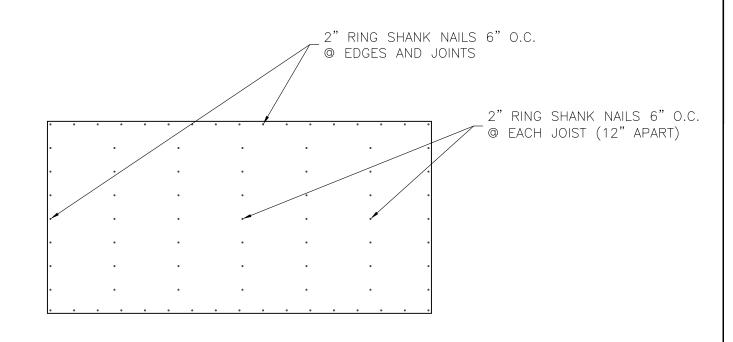


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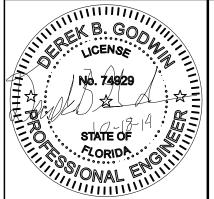
SHEET NUMBER





FLOOR SHEATHING (NAIL PATTERN)

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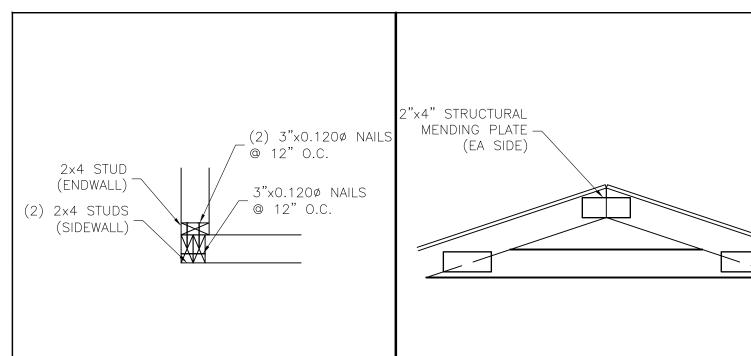
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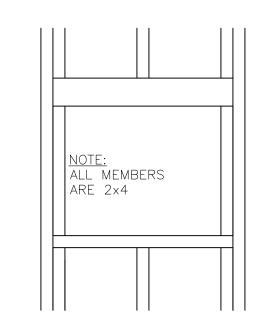
PROJECT NO: 14017 DATE: 10-18-14 DRAWN BY: DBG CHECKED BY: TP REVISION:

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SCALE: 1/2"=1'







TRUSS TO WALL CONNECTION SIMPSON H2.A W/ (5)8d 1-1/2" NAILS EACH END OF CLIP (NOT SHOWN) (4) 3"x0.120¢ NAILS TOE-NAILED TO TOP PLATE @ EA TRUSS 3) 3"x0.120¢ NAILS TOP PLATE TO EACH STUD (6 TOTAL) 2×4 AT CORNERS (6) 3"x0.120¢ NAILS ONLY (TYP) 2 EACH ROW 2x4 STUDS NOTE: INSTALL H2.5A PER MANUFACTURE'S RECOMMENDATIONS 4-CORNER & WALL DETAIL

1-CORNER DETAIL


2-TRUSS SPLICE DETAIL


3-TYP WINDOW FRAMING

7/6" ROOF SHEATHING 2x4 ROOF TRUSS @ 24" O.C. (HELPER TRUSS 12" FROM END WALLS) 1"x4" TRIM (SEE ELEVATIONS) (5) 3"x0.120¢ NAILS 2x6 TO TRUSS TYPICAL EACH END (1) 3"x0.120ø NAIL @ 8" O.C. 2x6 TOE-NAILED TO TOP PLATE %" T-111 SHEATHING →

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5-END WALL DETAIL



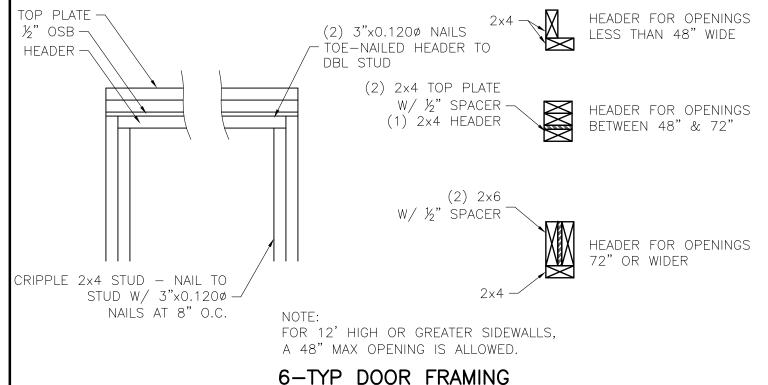
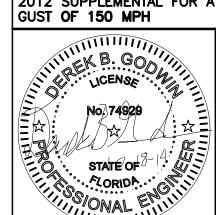
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PORTABLE GARAGE--FL--V=150MPH--FBC 2010


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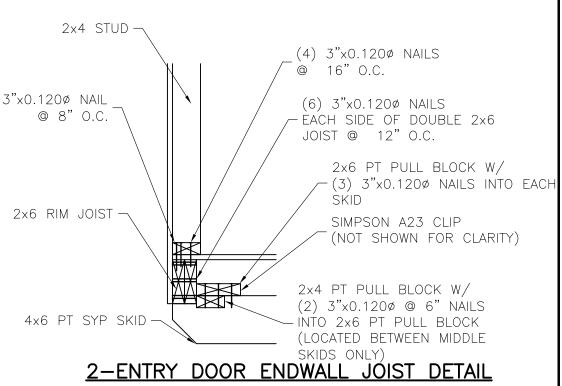
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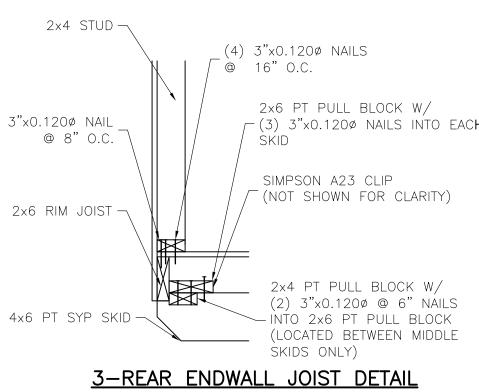
SCALE: 1"=1







1-INNER & OUTER SKID DETAIL @ EVERY JOIST




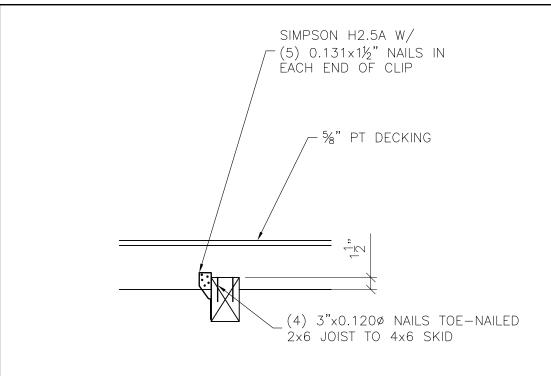

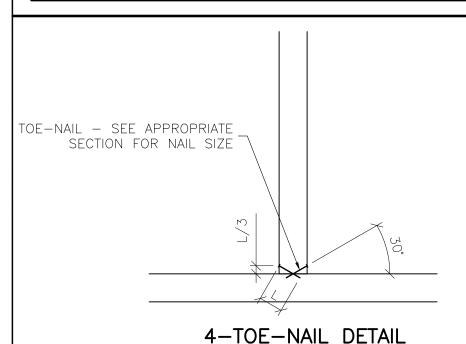


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NOTE: SOFFIT VENTS SHALL BE SPACED AT 24" MAX AND SHALL BE SPACED SO THAT THEY ARE BETWEEN TRUSSES ON EITHER SIDE OF THE EAVES

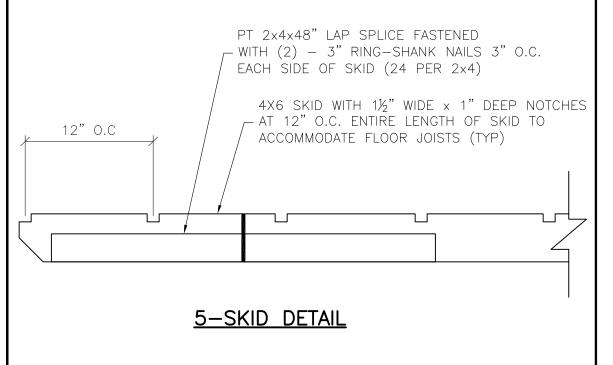6-SOFFIT VENTS

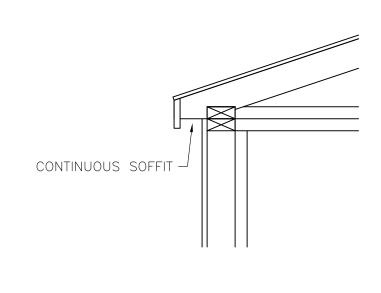

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E	PROJECT NO:	14017
	DATE:	10-18-1
	DRAWN BY:	DBG
3	CHECKED BY:	TP

SHEET NUMBER

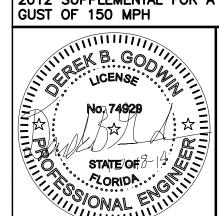SCALE: 1"=1

PORTABLE GARAGE--FL--V=150MPH--FBC 2010