#### REQUEST FOR WAIVER FROM ACCESSIBILITY REQUIREMENTS OF CHAPTER 553, PART II, FLORIDA STATUTES

Your application will be reviewed by the Accessibility Advisory Council and its recommendations will be presented to the Florida Building Commission. You will have the opportunity to answer questions and/or make a short presentation, not to exceed 15 minutes, at each meeting. The Commission will consider all information presented and the Council's recommendation before voting on the waiver request.

1. Name and address of project for which the waiver is requested.
Name: ONE STORY RETAIL BUILDING
Address: 7350 BISCAYNE BOULEVARD
MIAMI FL 33137
2. Name of Applicant. If other than the owner, please indicate relationship of applicant owner and written authorization by owner in space provided:
Applicant's Name: VILLAGE ARCHITECTS
Applicant's Address: 104 CRANDON BLVD STE \$24.
Applicant's Telephone: 305. 361. 5335 FAX: 305. 361. 5329.
Applicant's E-mail Address: ROBERTQ VILLA GE ARCHITECTS. COM
Relationship to Owner: ARCH I TECT
Owner's/Tenant's Name: 7320 BISCAYNE BLUD LLC
Owner's Address: 1244 MICHIGAN AVE
Owner's Telephone: 306.905.2803 FAX
Owner's E-mail Address: DAMIAN NARVEZO GMAIL COM.
Signature of Owner:
3. Please check one of the following:
[ ] New construction.  FBC 2012-01  Request for Waiver  Rule 61G20-4.00 effective 4/25/201

[] Addition to a building or facility.
[] Alteration to an existing building or facility.
[ ] Historical preservation (addition).
Historical preservation (alteration).
4. Type of facility. Please describe the building (square footage, number of floors). Define the use of the building (i.e., restaurant, office, retail, recreation, hotel/motel, etc.)
3,205 SQFT, SINGLE STORT, SINGLE RETAIL TENANT
5. Project Construction Cost (Provide cost for new construction, the addition, or the alteration):
6. <b>Project Status:</b> Please check the phase of construction that best describes your project at the time of this application. Describe status.
Under Design [] Under Construction*
[] In Plan Review [] Completed*
* Briefly explain why the request has now been referred to the Commission.
THIS IS A CONTRIBUTING BUILDING IN THE MIMO (BISCAYNE
HISTORIC DISTRICT. AN EXTERNAL RAMP IS NOT
POSSIBLE DUE TO RUN NECESSARY TO RAMPUP 27".  THE ONLY LOCATION ALLOWED FOR INTERNAL  LANDING & RAMP CONPLICTS of EXISTING FOUNDATION.  7. Requirements requested to be waived. Please reference the applicable section of Florida law. Only Florida-specific accessibility requirements may be waived.
Issue FBC 2012-01 Rule 61G20-4.001

Request for Waiver

effective 4/25/2013

1: FIBC ACCE	SSIBILITY	- SEC. 202.5	ALTERATIO	ons of
QUALIFIED	HISTORIC	BUILDINGS	* WAIVE	ACCESSIBLE
Issue				
2:				
Issue				
3:				
affect owners in gen	eral.	on or set of conditions		
ENTRANCE	Dove To	MAKE ACC	ESSIBLE	
[] Substantial finan	cial costs will be in	curred by the owner if	the waiver is denie	ed.
cannot find an eff	ficient mode of co	restigation into the co ompliance. Provide of es must include bids a	detailed cost estin	with the code, but nates and, where
FBC 2012-01				Rule 61G20-4.001

effective 4/25/2013

FBC 2012-01 Request for Waiver

9. Provide documented cost estimates for each portion of the waiver request and identify any additional supporting data which may affect the cost estimates. For example, for vertical accessibility, the lowest documented cost of an elevator, ramp, lift or other method of providing vertical accessibility should be provided, documented by quotations or bids from at least two vendors or contractors.
a
b
c
10. Licensed Design Professional: Where a licensed design has designed the project, his or her comments MUST be included and certified by signature and affixing of his or her professional seal. The comments must include the reason(s) why the waiver is necessary.
ACCESTIBLE AND WOULD REQUIRE ADDITIONAL
Signature Printed Name ROBERT JOHN GRABOSKI Phone number 305, 772 5250
(SEAL)

### CERTIFICATION OF APPLICANT:

I hereby declare that the applicable documents in support of this Request for Waiver are attached for review by the Florida Building Commission and that all statements made in this application are to the best of my knowledge true and correct.

Dated thisday of	
amian 1	Varray
Signature	•

Printed Name

I understand that if I falsify, misrepresent, or omit any material information on this document, the Commission may revoke any order and will notify the building official of the permitting jurisdiction.

KNOWINGLY MAKING A FALSE STATEMENT IN WRITING WITH THE INTENT TO MISLEAD A PUBLIC SERVANT IN THE PERFORMANCE OF HIS OFFICIAL DUTY IS A MISDEAMEANOR OF THE SECOND DEGREE PURSUANT TO SECTION 837.06 F.S. AND SECTION 775.083, F.S.

Certification of Licensed Design Professional for Replicated Designs to be Placed on Consent Agenda			
Note: Fill out pages only for cases in which design documents are duplicates of previously approved waivers and the project can be placed on a Consent Agenda.			
I, ROBERT JOHN GRABOSKI, a licensed architect/engineer in the state of Florida, whose Florida license number is 91 596, hereby state as follows:			
1. I am the architect/engineer of record for the project known as (name of project) 7320  BISCAY NE BWD, for which the Owner seeks a waiver of one or more accessibility requirements in an application to which this Certification is attached.			
2. I hereby certify that to the best of my knowledge and belief to the Florida Building Commission that the design documents for the (insert project described in paragraph 1 above) 7320 BISCATNE BUDD. are the same as the design documents previously submitted to the Commission and referenced in paragraph 3 below, except that the two projects are built or to be built on different parcels of land at different locations.			
3. The licensed design professional of record (identify the licensed design professional of record), ROBERT OFF GRABOSKI , prepared the design documents for the project known as 7320 BISCATNE BWD. , for which the majority of the Accessibility Advisory Council recommended approval and the Commission granted a waiver of one or more accessibility requirements in Final Order No			
Printed Name: ROBURT JOHN GRABON Affix certification seal below:			
Address: 104 CRANDON BLUD STE 924			
KEY BISCAYNE, FL 33149.			
Telephone: 305. 361. 5335.			
Fax: 305, 361, 5329.			
E-Mail Address: ROBERT @ VILLAGE ARCH I TECTS. COM			

FBC 2012-01 Request for Waiver

# VILLAGE ARCHITECTS

### OF KEY BISCAYNE, INC

ARCHITECTS, PLANNERS, INTERIOR DESIGN & PURCHASING

Florida Building Commission 1940 North Monroe Street Tallahassee, FL 32399-0072

23 October 2013

Dear Commission,

This application is under design and is being submitted for a contributing building in the MiMo/Biscayne Boulevard Historic District in the City of Miami. This 3,205 Sqft single story and single retail tenant building was built in 1953 as the office and private residence of Dr. Carter. The building is approximately 27" above the adjacent grade and currently does not provide an accessible entry, parking space or bathroom. The building has 0'-0" setbacks on both the north and south sides and there is an 11'-0" driveway under a carport on the south side to the rear parking area. It is not possible to have an accessible walkway to the rear of the existing building. The front setback is a non-conforming 4'-1" and does not provide enough room for an external ramp.

We submitted plans to the City of Miami Historic and Environmental Preservation Board which had proposed a new accessible entry location replacing the three vertical windows on the northern side of the facade. This was not approved by the board who stated the entry door must remain in the original location. They would allow us to lower the door in the existing location to provide an interior landing and ramp. We feel this is an undue hardship since the approved landing location conflicts with the existing foundation stem wall and would require considerable additional work to make this location work. We have been working with the City of Miami preservation officer on options that meet the Historic Boards requirements and this application reflects what will be approved.

We have met with the City of Miami Building Official Mr. Maurice Pons. He respects the decision of the Historic Board and understands the design position we face. It is understood that he will not comment on the application since we are still under design and not in the permitting process. We do not want to proceed with construction documents until we understand what will be approved.

Our plans do propose to make the building accessible by providing a handicap accessible parking space that will be served by a ramp in the rear of the building. We are also proposing an accessible bathroom inside of the building. We will also provide handrails at the existing external entry landing and steps.

We ask that the accessible entrance be waived due to the Historic nature of the building and the existing site constraints for the location of a ramp whether internal or external.

Sincerely,

Robert John Graboski

# City of Miami



JOHNNY MARTINEZ, P.E. City Manager

October 23, 2013

Florida Building Commission 1940 North Monroe Street Tallahassee, FL 32399

RE:

Accessibility Waiver for project "7320 Biscayne Blvd"

7320 Biscayne Blvd Miami, FL 33138

#### Dear Sir or Madam:

The City of Miami Historic and Environmental Preservation Board has reviewed the proposed work for this project located at 7320 Biscayne Blvd. This is a contributing structure in the MiMo/ Biscayne Boulevard Historic District and the HEP board did not feel that it was appropriate to relocate doors and windows. The board resolution stated that the entrance door shall be kept in its original location and the (3) vertical windows at the north end of façade shall remain.

We have worked with the applicant on ways to meet the board's requirements. The plans being submitted meet the requirements of the HEP board and would be approved by the City of Miami Historic Preservation Department.

Sincerely,

Marina Novaes

Historic Preservation Special Projects Coordinator



#### Miami Historic and Environmental Preservation Board

Resolution: HEPB-R-13-052

File ID 13-01028

September 9, 2013

Item HEPB.2

Mr. Gerald C. Marston offered the following resolution and moved its adoption:

**ENVIRONMENTAL** RESOLUTION OF THE MIAMI HISTORIC AND PRESERVATION BOARD APPROVING WITH CONDITIONS AS SPECIFIED IN **APPLICATION** CERTIFICATE **EXHIBIT** "A", AN FOR SPECIAL OF CONTRIBUTING **APPROPRIATENESS** FOR THE REHABILITATION Α RESOURCE AT 7320 BISCAYNE BOULEVARD WITHIN THE MIMO HISTORIC DISTRICT.

Upon being seconded by Mr. David Freedman, the motion PASSED by a vote of 7-0:

Mr Timothy A Barber

Will Inflothly M. Darbor	. 00
Mr. David Freedman	Yes
Mr. Robert John Graboski	i Abstain
Mr. Gary Hecht	Yes
Dr. William E. Hopper	Yes
Mr. Jorge Kuperman	Yes
Ms. Lynn B. Lewis	Absent
Mr. Gerald C. Marston	Yes
Mr. Hugh Ryan	Yes
	Maron
	Megan-McLaughlin
V	Preservation Officer
)	

Yes

STATE OF FLORIDA COUNTY OF MIAMI-DADE

Personally appeared before me, the undersigned authority, Megan McLaughlin, Preservation Officer of the Miami Historic and Environmental Preservation Board of the City of Miami, Florida, and acknowledges that she executed the foregoing Resolution.

SWORN AND SUBSCRIBED BEFORE ME THIS 26 DAY OF Serkinger, 2013.


Vanessa Trujilis

Print Notary Name

Notary Public State of Florida

Did take an oath \_\_\_\_\_ or Did not take an oath \_\_\_\_\_

My Commission Expires:

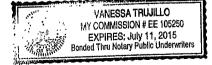

### EXHIBIT "A"

- 1- The entrance door shall be kept on its original location and may be lowered to the sidewalk level.
- 2- The 3 vertical narrow windows at the north end of the façade shall be preserved.3- All glass shall be clear.



October 23, 2013

7320 Biscayne LLC Attention: Mr. Damian Narvaez 1244 Michigan Avenue Miami Beach, Fla. 33140

Re: 7320 Biscayne Boulevard – Miami, Fla.

Dear Mr. Narvaez:

Regarding the above property, the original estimate contemplated the cost to modify the floor joists on (1) side for a landing and <u>straight ramp</u>. However, the Miami HEP Board's approval requires additional structural work to provide a center landing, steps and now a dog leg ramp. This work will include significant additional foundation work to relocate the dividing knee wall for the concrete floor joists. The concrete joists on each side of the foundation will need to be modified per the new knee wall. Below you will find our Original Estimate of \$111,500 will increase by \$40,000 to \$151,500.00.

#### Original Estimate:

Hurricane impact windows and doors - \$30,000;

Façade work/parapet extension (including aluminum) - \$5,000;

Exterior paint - \$4,000;

New HVAC system - \$10,000;

Handicap Parking (stripe, mark, sign) - \$2,500;

New Ramp to rear of property - \$10,000;

New Handrails at existing entry door - \$1,000;

ADA restroom - \$4,000;

Structural work (modify floor joists on one (1) side) to provide straight ramp - \$40,000.



Page 2.

#### Extra work:

Structural work -Additional foundation work post HEP Board decision - \$40,000

Thank you for your consideration.

Very truly yours,

Gavin McKenzie

GM/cdb

#### My Home Miami-Dade County, Florida



### miamidadə.gov

#### **Property Information Map**



Aerial Photography - 2012

\_\_\_\_\_ 115 ft

This map was created on 10/24/2013 9:48:54 AM for reference purposes only.

Web Site @ 2002 Miami-Dade County. All rights reserved.



Close

#### Summary Details:

Folio No.:	<u>01-3207-040-1800</u>
Property:	7320 BISCAYNE BLVD
Mailing Address:	7320 BISCAYNE LLC
	1244 MICHIGAN AVE MIAMI BEACH FL 33139-

#### Property Information:

Primary Zone:	6101 CEN-PEDESTRIAN ORIENTATIO
CLUC:	0009 MIXED USE - RESIDENTIAL
Beds/Baths:	0/0
Floors:	1
Living Units:	0
Adj Sq Footage:	3,205
Lot Size:	7,500 SQ FT
Year Built:	1953
Legal Description:	FEDERAL WAY AMD PB 25-6 LOT 26 BLK 15 LOT SIZE 50.000 X 150 OR 16747-3619 0495 1 OR 28169-4110 0612 12

#### Assessment Information:

Year:	2013	2012
Land Value:	\$337,500	\$262,500
Building Value:	\$30,000	\$30,000
Market Value:	\$367,500	\$292,500
Assessed Value:	\$367,500	\$189,303

#### Exemption Information:

Year:	2013	2012
Homestead:	\$0	\$25,000
2nd Homestead:	NO	YES

#### Taxable Value Information:

Year:	2013	2012
Taxing Authority:	Applied Exemption/ Taxable Value:	Applied Exemption/ Taxable Value:
Regional:	\$0/\$367,500	\$50,000/\$139,303
County:	\$0/\$367,500	\$50,000/\$139,303
City:	\$0/\$367,500	\$50,000/\$139,303
School Board:	\$0/\$367,500	\$25,000/\$164,303

#### Sale Information:

Sale Date:	6/2012
Sale Amount:	\$103,000
Sale O/R:	<u>28169-4110</u>



### Detail by Entity Name

Florida Limited Liability Company

7320 BISCAYNE LLC

Filing Information

Document Number L11000029456
FEI/EIN Number 450632284
Date Filed 03/10/2011

State FL

Status ACTIVE Effective Date 03/09/2011

Principal Address

1244 MICHIGAN AVENUE MIAMI BEACH, FL 33139

Changed: 02/06/2012

Mailing Address

1244 MICHIGAN AVENUE MIAMI BEACH, FL 33139

Changed: 02/06/2012

Registered Agent Name & Address

NARVAEZ, DAMIAN M 1244 MICHIGAN AVENUE MIAMI BEACH, FL 33139

Manager/Member Detail

Name & Address

Title MGRM

NARVAEZ, DAMIAN 1244 MICHIGAN AVENUE MIAMI BEACH, FL 33139

**Annual Reports** 

Report Year Filed Date 2012 02/06/2012 2013 01/24/2013

#### **Document Images**

01/24/2013 -- ANNUAL REPORT View image in PDF format


02/06/2012 -- ANNUAL REPORT View image in PDF format

03/10/2011 -- Florida Limited Liability View image in PDF format


> Copyright © and Privacy Policies State of Florida, Department of State

## MIMO Biscayne District

# 7320 Biscayne Blvd

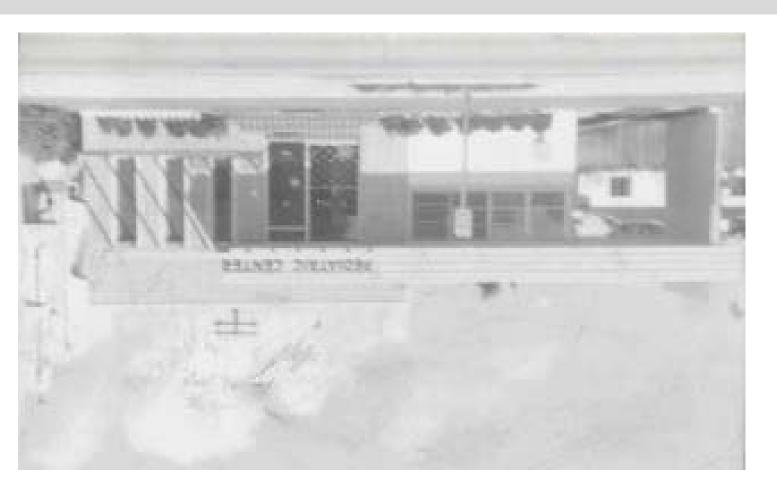



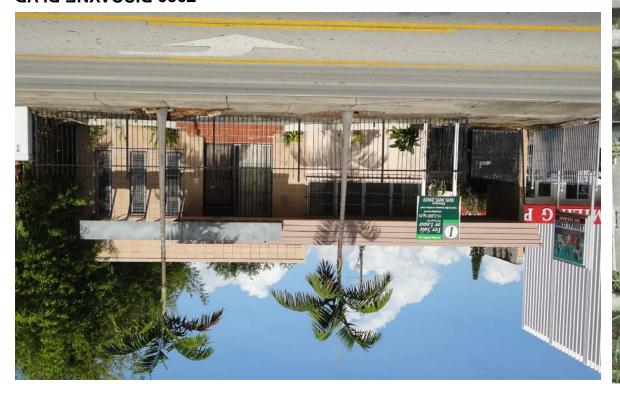

HELL ONGLEN NNE 7310 TS QAST EN 7320 TS HTOR


(TSA3) W3IV TNOA7 **1350 BISCALUE BLVD**  LOCATION

CONTEXT



### **RETAIL BUILDINGS STUDY**

Proposed location for ramp to parking space

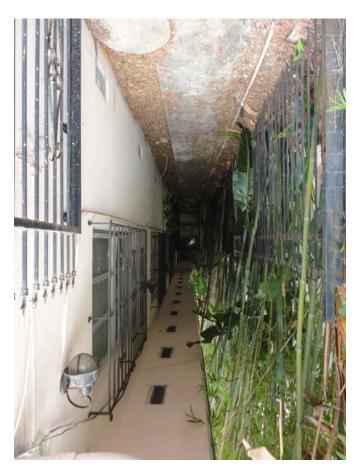

MIMO Biscayne District 7320 Biscayne Blvd

**Existing Front Entry** 



**Existing Rear Elevation** 



### **MIMO Biscayne District**



7320 BISCAYNE BLVD NORTH PROPERTY LINE VIEW



7320 BISCAYNE BLVD SOUTH PROPERTY LINE VIEW



7320 BISCAYNE BLVD SOUTH PROPERTY LINE VIEW

### **CONTEXT**

### **MIMO Biscayne District**



7326 BISCAYNE BLVD- NORTH NEIGHBOR





7310 BISCAYNE BLVD- SOUTH NEIGHBOR



7300 BISCAYNE BLVD- COPPERTONE SIGN BUILDING

### **MIMO Biscayne District**



**575 NE 73 STREET- WEST NEIGHBOR** 



7301 BISCAYNE BLVD- NORTH EAST NEIGHBOR



7281 BISCAYNE BLVD- SOUTH EAST NEIGHBOR


### **ADJACENT PROPERTIES**

### **MIMO Biscayne District**





В

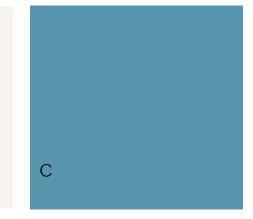

### SHERWIN WILLIAMS PAINT COLORS

A. EARL GRAY SW 7660 (ACCENT WALL)
B. WHITE FLOUR SW 7102 (MAIN BUILDING)
C. GEORGIAN REVIVAL BLUE SW 7609 (ACCENT MOLDS)



# **MATERIALS**

METAL MARQUEE FASCIA SILVER COLOR FINISH

**MIMO Biscayne District** 



### **PROPOSED RENDERING**

Fire Hydrant

Water Meter

Electric Box

Telephone Box

Sewer Manhole

Water Manhole Telephone Manhole Monitoring Well

Chain Link Fence Parking Meter

Sewer Valve

Spot Elevation

Property Corner

Traffic Sign

Catch Basin Drainage Manhole

C.B.S. Wall

Clean Out

Guard Pole

Pool Pump

Temporary Benchmark

Irrigation Control Valve

Mail Box

1.5'-15'-10' Diameter-Height-Spread

Right-of-Way Lines

-//- Wood Fence

Light Pole

Gas Valve

Overhead Utility Lines

--OUL--

 $\triangle$ 

# **BOUNDARY SURVEY**

7320 BISCAYNE BOULEVARD, CITY OF MIAMI, MIAMI-DADE COUNTY, FLORIDA 33138

DAMIAN NARVAEZ

AMENDED PLAT OF FEDERAL WAY (P.B. 25, PG. 6), F.I.P. ø 1/2" LOT 3, BLOCK 15 (NO ID.) N8915'35"W VENUE) RAL WAY 75, Pc. 6) 7, BLOCK BOULE ONE STORY RESIDENCE No. 7320 K F.F.E. = 12.39 AFEE CP B 6th 叫 N.E. 73rd N8915'35"W (NO ID.) 150.00 LOT 25, BLOCK 15. SC AMENDED PLAT OF FEDERAL WAY (P.B. 25, PG. 6) **LEGEND** Back Flow Preventer Concrete Light Pole **BLOCK** Metal Light Pole Guy Wire (NO ID.) Utility Power Pole

### ABBREVIATIONS

Α	Arc Length
A/C	Air Conditioner Pad
ASPH.	Asphalt
B.M.	Benchmark
C.B.S.	Concrete Block Structure
C.G.	Curb & Gutter
CH	Chord Distance
C/L	Center Line
C.L.F.	Chain Link Fence
CONC.	Concrete
C.S.	Concrete Slab
DWY.	Driveway
E.T.P.	Electric Transformer Pad
F.F.E.	Finished Floor Elevation
F.I.P.	Found Iron Pipe
F.N.D.	Found Nail & Disc
F.R.	Found Rebar
I.D.	Identification
INV.	Inverts
L.F.E.	Lowest Floor Elevation
M/L	Monument Line
P. <b>B.</b>	Plat Book
P.C.P.	Permanent Control Point
PG.	Page
PL.	Planter
P/L	Property Line
P.O.B.	Point of Beginning
P.O.C.	Point of Commencement
P.R.M. R/W	Permanent Reference Monument
SWK.	Right—of—Way Line Sidewalk
T.B.M.	Temporary Benchmark
V.G.	Valley Gutter
****	Tallog Cattor

Wood Fence

Utility Easement

Parking Spaces

W.F. U.E.

N.E. 74th STREET BOULEVARD AVENUE AVENUE 12 10 9 8 6 3 5th 26 NE 6th 山 BISCAYN N.E. 15 17 18 19 20 | 21 25 24

N.E. 73rd STREET

LOCATION SKETCH NOT TO SCALE

#### **SURVEYOR'S NOTES:**

1. Field Survey was completed on: July 24, 2012.

2. LEGAL DESCRIPTION:

Lot 26, Block 15, of AMENDED PLAT OF FEDERAL WAY, according to the Plat thereof, as recorded in Plat Book 25, at Page 6, of the Public Records of Miami-Dade County, Florida.

Containing 7,500 Square Feet or 0.17 Acres more or less by calculations.

The above captioned property was surveyed and described based on the above Legal Description furnished by the client.

3. SOURCES OF DATA:

AS TO VERTICAL CONTROL:

By scaled determination the subject property lies in Flood Zone X, as per Federal Emergency Management Agency (FEMA) Community—Panel Number 120650, Map No. 12086C0308, Suffix L, Revised Date: 09—11—2009.

An accurate Zone determination should be made by the preparer of the map, the Federal Emergency Management Agency, or the Local Government Agency having jurisdiction over such matters prior to any judgments being made from the Zone as noted. The referenced Federal Emergency Management Agency Map states in the notes to the user that "this map is for insurance purposes only".

The vertical control element of this survey was derived from the National Geodetic Vertical Datum,

Benchmarks used: Miami-Dade Benchmark E-243 Elevation=11.76' (N.G.V.D.) Location: N.E. 68th Street & N.E. 4th Court

Miami-Dade Benchmark H-243

Elevation=14.05' (N.G.V.D.) Location: N.E. 79th Street & N.E. 4th Avenue

AS TO HORIZONTAL CONTROL:

-North Arrow and Bearings refer to an assumed value of NORTH, along the East line of the Subject Property, Public Records of Miami-Dade County Florida. Said line is considered well established and monumented. -Municipal Atlas City of Miami Sheet No. 9P.

4. ACCURACY:

The accuracy obtained by measurement and calculation of closed geometric figures was found to exceed this

5. LIMITATIONS:

Since no other information other than what is cited in the Sources of Data was furnished, the Client is hereby advised that there may be legal restrictions on the Subject Property that are not shown on the Survey Map or contained within this Report that may be found in the Public Records of Miami-Dade County, or the records of any other public and private entities as their jurisdictions may appear. The Surveyor makes no representation as to ownership or possession of the Subject Property by any entity or individual who may appear in public records. No excavation or determination was made as to how the Subject Property is served by utilities. No improvements were located, other than those shown. No underground foundations, improvements and/or utilities

This notice is required by the "Minimum Technical Standards for Land Surveying in the State of Florida," pursuant to Rule 5J-17 of the Florida Administrative Code. Notice is hereby given that Sunshine State One Call of Florida, Inc. must be contacted at 1-800-432-4770 at least 48 hours in advance of any construction, excavation or demolition activity within, upon, abutting or adjacent to the Subject Property. This Notice is given in compliance with the "Underground Facility Damage Prevention and Safety Act," pursuant to Chapter 556.101-111 of the Florida Statutes.

#### **CERTIFY TO:**

#### **SURVEYOR'S CERTIFICATE:**

I HEREBY CERTIFY: That the Boundary Survey of the above described property is true and correct to the best of my knowledge and belief as recently surveyed under my direction. Further, there are no above ground encroachments unless shown. This survey meets the minimum technical standards set forth by the Florida Board of Professional Surveyors and Mappers, in Chapter 5J-17. Florida Administrative Code, pursuant to section 472.027 Florida Statutes. Examination of the abstract of title will have to be made to determine recorded instruments, if any, affecting the property. Location and identification of utilities adjacent to the property were not secured as such information was not requested. Ownership is subject to opinion of title.

#### J. BONFILL & ASSOCIATES, INC. Florida Certificate of Authorization No. LB 3398

JUAN J. BONFILL **PROFESSIONAL SURVEYOR AND MAPPER No. 3179** STATE OF FLORIDA

Not valid without the signature and the original raised seal of a Florida Licensed Surveyor and Mapper. Additions or deletions to survey maps or reports by other than the signing party or parties is prohibited without written consent of the signing party or parties.



J. Bonfill & Associates, Inc. REGISTERED LAND SURVEYORS & MAPPERS Florida Certificate of Authorization LB3398 7100 S.W. 99th Avenue Suite 104 Miami, Florida 33173 (305) 598-8383

OF MIAMI, A 33138 20 BISCAYNE BOULEŬARD, CITY MIAMI-DADE COUNTY, FLORID. SURVE 73.

REVISIONS


12-0216 12-0216 07-24-2012 Date: Drawn: G.P,E.F,J.S,T.P Checked: J.B. Scale: AS SHOWN Field Book: ON FILE

SHEET 1 OF 1

### **MIMO Biscayne District**

DESCRIPTION  7329 BISSAYNI BAVE.			REAL PROPERTY RECORD . CITY OF MIAMI, FLORIDA TAX ASSESSOR					1-05-3088		END PLATURES		LAND COMPUTATIONS  ENGINEE INSCRICT MERGER AMOUNT								LAND VALUE	BUILDING	TOTAL	CHANGE	TAXABLE VALUE	BEASON FOR CHANG		
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**TAX CARD** 

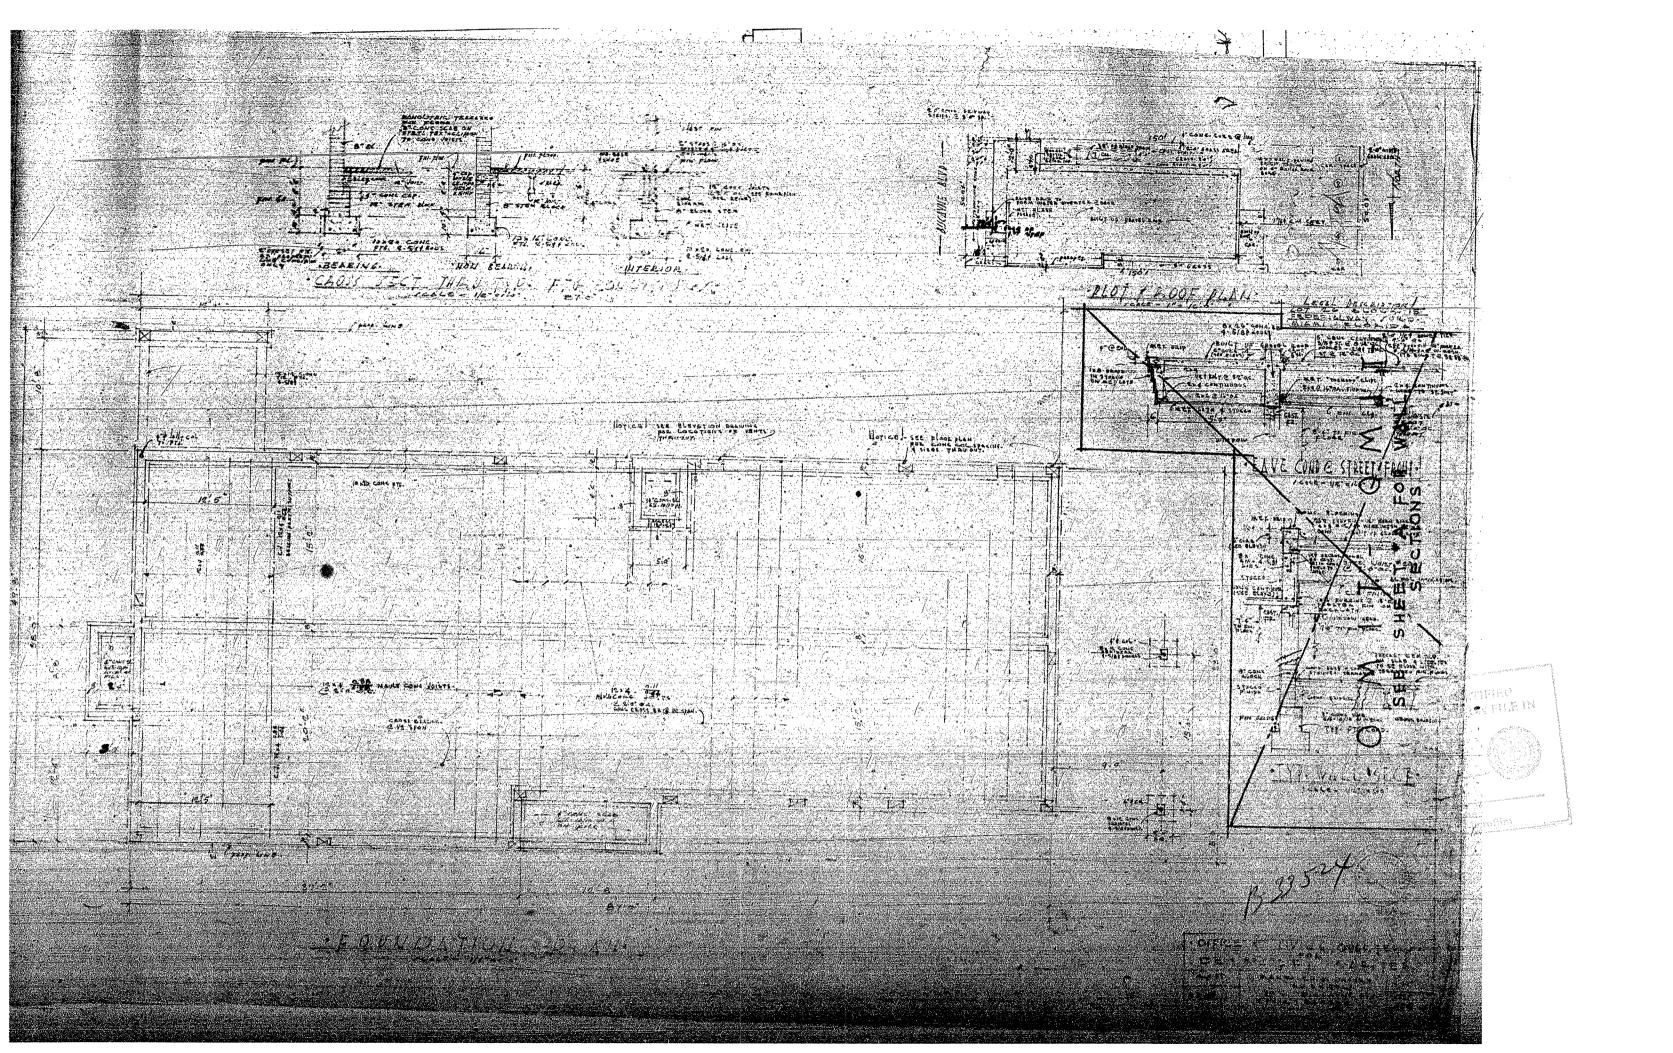

### GENERAL NOTES

### DIVISION I - GENERAL REQUIREMENTS

1.1 These notes refer to general conditions of Construction and some sections may not be relevant in way of approved construction travel. All plants to be removed and relocated shall be done in to this project.

1.2 Scope of work:

from the drawings.

The General Contractor shall provide all labor, materials, supplies, equipment and services to include but not limited to general construction, electrical, plumbing, and HVAC work required for a anticipated settlement and shrinkage. complete and operational job as shown and / or indicated on these drawings. The Contractor shall be responsible for coordination of all work provided by the subcontractors and the various

Items marked on plans as F.B.O. shall be Furnished By Owner and installed by trades. Sub contractors and trades shall be provided with full spec, sheets prior to proceeding with any installation or ordering of custom goods.

1.2.1 Allowances: Contractor shall include in the contract all allowances as listed in the Index to Specifications. When the allowance exceeds the cost, Contractor shall pay the difference to the Owner. When the cost exceeds the allowance, Owner will pay the difference to the Contractor.

1.2.2 Not in Contract (N.I.C.) Items: Items not included in Contract but installed by Contractor:

1. Light fixtures and ceiling fans with exception of recessed light fixtures. 2.Bathroom Accessories.

Items not included in Contract and installed by others:

1. Stereo / security and low-voltage shall be provided by other. 2. Stereo system to be by others. Contractor to coordinate scheduling for pre-wiring. 1.3 Code Compliance:

The Contractor, subcontractor and others performing work on this project shall comply with the Florida Building Code 2010 edition and all applicable local codes and regulations and any other authority having jurisdiction. The General Contractor shall be responsible to secure all applicable permits, licenses, pay all necessary fees and supply the owner with release of liens for all subcontractors in performing this contract.

1.4 Field Engineering:
The Contractor and subcontractors shall examine all areas in which their work is to be installed, and shall report any condition, which is not suitable to receive work under this contract.

When discrepancies occur between construction conditions and the construction documents, the Contractor shall be responsible for notifying the Architect for clarification or verification 3.1 Compressive strength of concrete at 28 days shall be 5,000 PSI. prior to proceeding.

All finish work shall be free from all defects. The Architect reserves the right to reject any material and workmanship which is not considered to be up to the high standards of the various trades involved.

15 Use of Drawings: The Contractor shall use figure measurements noted on the drawings only. Measurements shall not be scaled from the drawings. If additional information is required, the contractor shall notify the architect prior to proceeding. The Contractor shall not interpolate dimensions of information

1.6 Schedules and Reports: for selective demolition work and construction to Architect and Owner for review prior to start of center or span with bulkheads.

work Include coordination for utility locating, shutoff, capping and continuation of services as required, together with notes on dust and noise control protection. 1.7 Shop Drawings, Product Data and Samples: Submit shop drawings for review in the form of one (1) reproducible transparency and three

transparency returned to Contractor. Present in a clear and thorough manner. Title each sheet with the project name, identify ich element of the drawing by reference to sheet number and detail schedule or room number o construction documents, identifying field dimensions showing relationship to adjacent or critical features of work or products.

General Contractor shall review all shop drawings and verify all site conditions and dimensions. Once Contractor has approved Shop Drawings and signed them indicating approval, then they shall be submitted to Architect for review of design content only. Any existing condition found by the Contractor, which will adversely affect the work shall immediately be brought to the attention of the Architect.

Submittals received from sources other than the Contractor's office, and which do not have Contractor's executed review and approved marking, will be returned "without action".

Do not allow submittals without appropriate final "action" markings by Architect to be used in

Provide an approved set of shop drawings to be held with the job site record set.

Submittal of shop drawings shall include but not limited to: Trusses, real keystones columns 4 decorative moldings, wood brackets, exterior \$ interior hardware, mechanical, electrical and pool equipment prior to fabrication or ordering.

All Shop Drawings to be reviewed by the Architect / Engineer. SHOP DRAWINGS REQUIRE APPROVAL BY THE BUILDING DEPARTMENT.

Contractor shall pay for and coordinate with the owner and applicable codes for the use of power, telephone service, working hours, routes for workmen's travel within the structure, location of dumpster or trash pick-up site and construction vehicles, etc. 1.9 Product Substitutions:

Changes and substitutions are permissible only with the prior written approval and authorization of the architect and owner.

1.10 Project Record Documents:

Provide and maintain, at a convenient location within the job site, a complete set of the construction drawings including all latest revisions and supplement sheets for reference and coordination during construction.

1.11 Waste Disposal: Proper disposal of all waste materials shall be by the General Contractor. All individual subcontractors shall be responsible for proper disposal of waste materials due to their

DIVISION 2 - SITE WORK

2.1 Demolition:

2.1.1 Protection: OSHA safety standards shall be met at all times.

Secure and protect premises during demolition. Any resulting damage or loss shall be corrected or replaced by contractor at the Contractor's expense.

Fire envelope integrity shall always be kept during demolition and construction.

Where selected demolition is called for, Contractor / Subcontractor shall verify conditions and proceed with due care not to disturb existing and possible unknown conditions to include: electrical conduit and wire, structural members, plumbing and drainage lines. Unforeseen mishaps

Preserves Bureau". All other wood in contact with masonry or concrete must be wrapped with will be the responsibility of that subcontractor.

Remove or relocate and salvage items as indicated on plans to a safe storage area as indicated by the owner or architect in a safe, orderly manner without damage to other parts of the premises or adjacent properties.

2.2 Landscape Protection: Protect all existing shrubs, trees, flowers etc. to remain. Properly trim back areas that will be an orderly and timely fashion to protect such plant.

Backfill: Bring backfill to suitable elevation above finish grade to provide for

Remove all excess fill not needed for backfill. Do not fill above the finish floor height or foundation venting unless specifically noted on plans. 2.4 Termite Control:

The entire soil area to be covered by footings, slab, porches, etc. shall be treated with Fumideal or equal for protection against termites in accordance with specifications approved for

2.4.1 Termite Treatment Certificate: Provide a jobsite posting board to receive duplicate treatment certificates as each

required treatment is completed, I copy - permit holder, I copy - building department. Certificate to include± product used, identity of the applicator, time \$ date of the treatment, site location, area treated, chemical used, percent concentration and number of gallons used, to establish a verifiable record of protective treatment. <u>Refer to F.B.C. 104.2.6</u>

Water supply lines shall be protected and marked to prevent accidental breakage.

Sewage line shall be marked and protected to prevent damage due to construction equipment.

Contractor is responsible to remove all debris, rubbish and other materials resulting from construction in a timely fashion. Transport and legally dispose of off-site.

DO NOT BURN ANY BUILDING MATERIALS ON SITE!

details and specifications. Minimum Lap = 10".

DIVISION 3 - CONCRETE Note: Structural Specifications supersede the General Notes.

3.0 All work shall be in accordance to the Florida Building Code, (High Velocity Hurricane Zones),

3.2 Reinforcing steel shall be in accordance with A.S.T.M. specification A-615, Grade 60. Reinforcing steel shall be bent, lapped and spliced in accordance with A.C.I. standard

3.3 Concrete coverage unless otherwise noted or shown: 3" for Bottom and Sides B. Beams 1 1/2" to Stirrups or Ties C. Columns 1 1/2" to ties D. Slabs (Ground Floor) 2" for Bottom and Top E. Slabs (Other) 11/2" for Bottom and Top

The Contractor shall provide a schedule indicating the proposed sequence of operations 3.4 All concrete beams shall have no horizontal joints. Any stop in concrete work shall be made at

All concrete beams marked T.B. shall be placed using walls as bottom forms and shall have continuous top and bottom reinforcing, splices, where necessary, shall be made in middle 1/3 of span for top bars, and end  $\frac{1}{2}$  of span for bottom bars. Provide 40" diameter lap minimum at all splices. ill exterior corners shall have 4'-0" corner bars, one top and one bottom, bent at mid-point. (3) opaque reproductions. Opaque copies of reproduction will be retained by Architect, and the

> 3.5 Dowel all columns to foundation with bars of same size and number as in column. Dowel splice 36" diameter minimum.

Columns shall be poured to full height and allowed to attain initial set prior to placing beams above. Minimum time interval 12 hours. 3.6 The soil conditions at this site are adequate to support the design noted in Soil Report dated 1/14/08 submitted by Dynatech Engineering Corp.. Should other conditions or materials be encountered, the Engineer / Architect shall be notified before proceeding with the work

3.7 Fill for floor slabs shall be placed on 12" layers and rolled and / or compacted to minimum field density of 95% as measured by the "Modified Protector Test". All fill shall be clean sand or sand/rock mixture free of organic or other deleterious materials. 3.8 Provide  $8" \times 8"$  precast concrete lintels over door and window openings in masonry walls.

2 #4 bottom bars B. Spans over 4'-0" C. Spans to 11'-0" 2 #4 bottom bars As detailed on Plans.

D. Spans over 11'-0"

DIVISION 6 - WOOD AND PLASTICS

Lumber used structurally shall be identified by the grade mark of an approved lumber grading agency. Stress Grade lumber shall be DOUGLAS FIR #2 or better and conform to the "National Design Specifications" for Stress grade Lumber and it's Fastenings," latest edition, with 1200 PSI min. fiber stress in bending, and 19% or less moisture content, unless otherwise noted.

Framing shall be done in a workman like manner by skilled labor. Before framing shall be installed, contractor shall chalk out walls and walk through with Architect and owner. Framing shall be square, level and plumb unless otherwise noted on plans.

A. All nailing shall conform to the Building Code nailing schedule. B. Provide double studs at each side of door openings.

C. Cutting of wood structural members shall be done in accordance to the Florida Building

All rafters, trusses and framing members shall be strapped with 1" x 1/8" galvanized metal strap to wrap around top plate or be embedded in tie beam as per Structural Engineer's specifications. Manufacturer to provide Shop Drawings to Architect and Structural Engineer for design review ONLY. Straps are to bear manufacturer print on strap.

Shall be a minimum of 5/8" exterior grade CDX, structural 1, unless otherwise specified, nailed to trusses or rafters with 8d nails at 4" c/c at panel edges and 6" c/c at interior supports.

Interior metal partitions shall be 20 Ga. I 5/8" imes 3 5/8" metal studs (unless otherwise specified on plans.) Single sill plate and a single top plate (nonbearing) and double top plate (bearing).

\*All bathrooms \$ kitchen to have 18 Ga. metal studs at 12" c/c. or as indicated on plans. Provide Horiz. Bracing on all wall hung fixtures/cabs as per FBC 2510.5, 2318.1.15 and R4409.5.1.15 To be with 1 x 2 PT wood furring at 16" c/c. Provide 1 x 4 @ all doors & windows openings &

coordinate blocking with soffits. Pressure treat all lumber in contact with masonry or concrete, as per "American Wood

All rough hardware for exterior use shall be galvanized.

6.17 Exterior Trim: All exterior trim boards to be as shown on Drawings. 6.18 Ceiling furring strips shall be 1" x 3" PT wood @ 16" O.C. or metal high-hat.

6.19 Provide all blocking for ceiling mounted electrical fixtures, wall mounted cabinetry, plumbing fixtures, etc. 6.2 Finish Carpentry:

Install millwork square and accurately with tight joints and true surfaces well sanded and free from defects. At length joints, join at 45° angle.

See Specifications for all cabinetry specifications.

DIVISION 1 - THERMAL AND MOISTURE PROTECTION

Typical insulation shall be installed as per manufacturer's instructions as follows: R-30 Rigid insulation above new roof deck R-4.2 U-back foil insulation on P.T. wood furring at new exterior walls. R-II Batten and sound insulation partition walls as indicated on plans.

New Built-up waterproof membrane. Manufacturer to provide sample for approval. -Provide color sample for aproval.

7.4 Flashing: Provide 26 GA Galv. copper flashing and drip edges at vertical wall/roof intersections and roof ends with antique patina finish or as indicated on plans.

7.5 Joint Sealers: Provide Butyl base sealant under all new exterior door thresholds and oleo resinous

caulking at all new doors, new windows, and other areas as required. Provide weather-stripping and manufacturer specified water proofing at all new exterior doors, windows and thresholds. Submit sample for Architect's / Owner approval.

7.6 Slab on grade: Provide 6 mil Visqueen moisture barrier below slabs on grade.

7.7 Waterproofing & Damp Proofing: All water proofing and water protective sealant shall be done as per requirements specified in the A.S.T.M. standards & specifications.

All water proofing shall be appropriate for it's conditions.

hydrostatic conditions. Consult manufacturer for system properties and uses.

All materials shall be installed as per manufacturers & Industry standard. General contractor shall submit specification \$ shop drawings indicating water proofing methods through. All trade involved included, but not limited to: painting, exterior lighting, exterior window & door installation, tile installation, roofing installation penetration through structure, flat

Membrane, hydrolytic and chemical admixtures in concrete are typical types of water proofing and damproofing systems. Choice of the appropriate system depends upon the prevailing

Specify installation to conform strictly to the recommendations of the manufacturer of the system selected.

General Contractor shall be responsible that all trades involved and that have part in the waterproofing have provided appropriate systems that meet A.S.T.M. standards 4 specifications. DIVISION 8 - DOORS AND WINDOWS

8.1 Security:

8.11 All exterior doors and windows to comply with Chapter 36 (Burglary and Intrusion) of Miami-Dade County Code and the components of the Florida Building Code with Miami-Dade County Product approvals to include impact resistance.

8.12 All locks on exterior doors shall be capable of resisting a force of 300#'s applied in any moveable direction and in accordance with resistance standards set forth in the Florida Building

minimum of 6000 possible key changes or locking auxiliary single dead bolt with hardened bolt

8.13 All single exterior swing doors shall have a lock to be key operated from the exterior with a

8.14 The active leaf of pairs of exterior swing doors shall have same locks as required for single exterior swing doors. The inactive leaf shall have multiple points of locks with 5/8 min. throw bolts 8.15 Jambs of all exterior offset type in swing doors shall be rabbited or of similar fabrication to

prevent defeating the purpose of the strike and the integrity of the locks and latches. 8.16 Hinges on exterior out swing doors shall have non-removable pins and non-exposed screws. 8.17 Glass and exterior doors shall comply with the American National Standards Institute's

8.18 Vision Panel exterior doors other than glazing within 40% of the inside locking activating device of loose and swing doors shall comply with the American National Standard Institutes

8.19 Windows shall be installed and constructed so that no panel can be lifted from the tracks when in the locked position and so as to comply with the architectural aluminum mags association standards for forced entry resistance, AAMA 1303.3.

Exterior window shall be locked with device capable of withstanding a force of 150\* applied in an operable direction. 8.19.1 Exterior windows used as a means of escape shall comply with FBC latest edition Section

8.19.2 Front main entrance doors shall be provided with a door scope or vision panels.

All exterior windows/doors shall be impact resistant white ESP. Alum. or approved equal. Contact: PGT Industries located @ 1070 Technology Drive, Nokomis, FL 34275. NOTE: Window/Door Mfg. to provide Product Approval which meet wind pressures stated on drawings. MFG. also required to obtain permit prior to manufactoring/ordering.

8.22 Interior doors to be composite paint grade | 3/8" wood doors.

8.23 All door frames to be stain grade solid wood without finger joints.

It is mandatory for door and window suppliers to submit Shop Drawings for Architect review prior to their fabrication. Verify framed openings with door / window manufacturer prior to framing

8.4 Installation: Follow manufacturers' installation instructions and waterproofing details. All windows and doors shall be level and operate with ease.

8.5 Finish Hardware: See window and door hardware schedules or confirm with owner. DIVISION 9 - FINISHES

Provide 5/8" thick stucco finish on CBS and concrete walls and / or over paper backed metal lath, see plans. Apply stucco with 3 coat finish. Finish to be smooth.

Provide necessary furring, nail cover, hangers, tie wire, corner ties, control joints, corner beads etc.

Provide 1/2" thick cement board (Durock) with 15# felt paper backing at all areas to receive tile/stone finishes and to include wet wall areas surrounding tub, shower and vanity. Note: Showers/tubs shall have floors and walls of non-absorbent materials (up to 10") as per

Provide 5/8" thick SHEETROCK brand MOLD TOUGH w/ Level 6 finish on 2 x 4 wood or metal studs. Non- structural soffit areas may use 15/8" metal studs and 1/2" SHEETROCK brand MOLD TOUGH gypsum board. Tape, patch, and sand smooth all surfaces.

9.7 Fire Retardant Coatings:

9.3 Cement Board

9.7.1 1-Hour Fire Rated Wall: 2x4 wood or metal studs at 16" c/c with single top and sill plates and 5/8" thick Type "X" gypsum wall board finish, both sides.

1x4 PT or metal high hat track @ 16" c/c with (2) layers 5/8" thick Type "X" gypsum wall board

Apply, patch, finish, and make paint ready all work specified herein as per the particular manufacturer's printed specifications or instructions. In areas of remodeling, patch and plaster as required, finish to match existing finish.

All areas of new construction and existing areas abutting, shall be painted shall be painted with top grade paint (Benjamin Moore) or approved equal.

Paint colors to be selected by Architect.

Protect all equipment, furnishings, electrical devices, and fire alarm equipment from over-spray or drips. Never paint orange sprinkler lines or sprinkler heads!

Provide one prime coat and two (2) finish coasts on all surfaces

Contractor shall provide sample on wall as indicated on Specifications. 9.10 Ceramic Tile, Floors & Pavers, Hard Surfaces: All installation and waterproofing of flooring, but not limited to: exterior or Interior floors, countertops, walls and backsplashes, shall meet the requirement of the manufacturer specifications

and the industry standards specified in the Tile Council of America standards. See Specification for the selected materials. Coordinate w/ Architect for any changes in materials prior to installation.

Provide actual bid for installation of all specified materials. Price shall include waterproofing or sealing as per manufacturer specifications. Contractor shall provide all material samples for Owner / Architect and interior designers approval.

Scope of Work

This is a contributing building in the MIMO/ Biscayne Historic District in the City of Miami

Remove existing interior partition walls and change from mixed Business/Residence to Retail Use. Remove and replace windows and doors with Impact Resistant type Install new ADA Ramp to handicap accessible parking space and Provide new ADA accessible Bathroom

Provide new Handrail at existing entry landing and steps Raise Front parapet for future tenant signage

List of Drawings

### Architectural

A0.01 General Notes and List of Drawings A2.00 Site Plan/ Demolition Floor Plan

A2.01 Proposed Floor Plan

A4.01 Front & North Side Elevations


A2.02 West & South Side Elevations

26002085 ARCHITECTS PLANNERS NTERIOR DESIGNERS 104 CRANDON BOULEVARD SUITE 424 KEY BISCAYNE, FLORIDA 33149 Fel 305-361-5335, Fax: 305-361-532 E-Mail: info@villagearchitects.com CONSULTANTS

# One Story Retial Interior & Exterior Renovations

7320 Biscayne Boulevard MiMo Historic District Miami, FL 33138

Owners: Damian Navaes 1244 Michigan Avenue Miami Beach, FL 33139

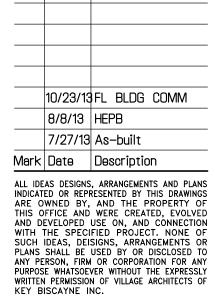


ROBERT JOHN GRABOSKI AR. 0091596

2600208E PROJECT Yr. : 2013

CAD DWG FILE : 7320 BISC DRAWN BY : CHECKED BY : R.J. SHEET TITLE

General Notes SHEET No.

Drawing Index &

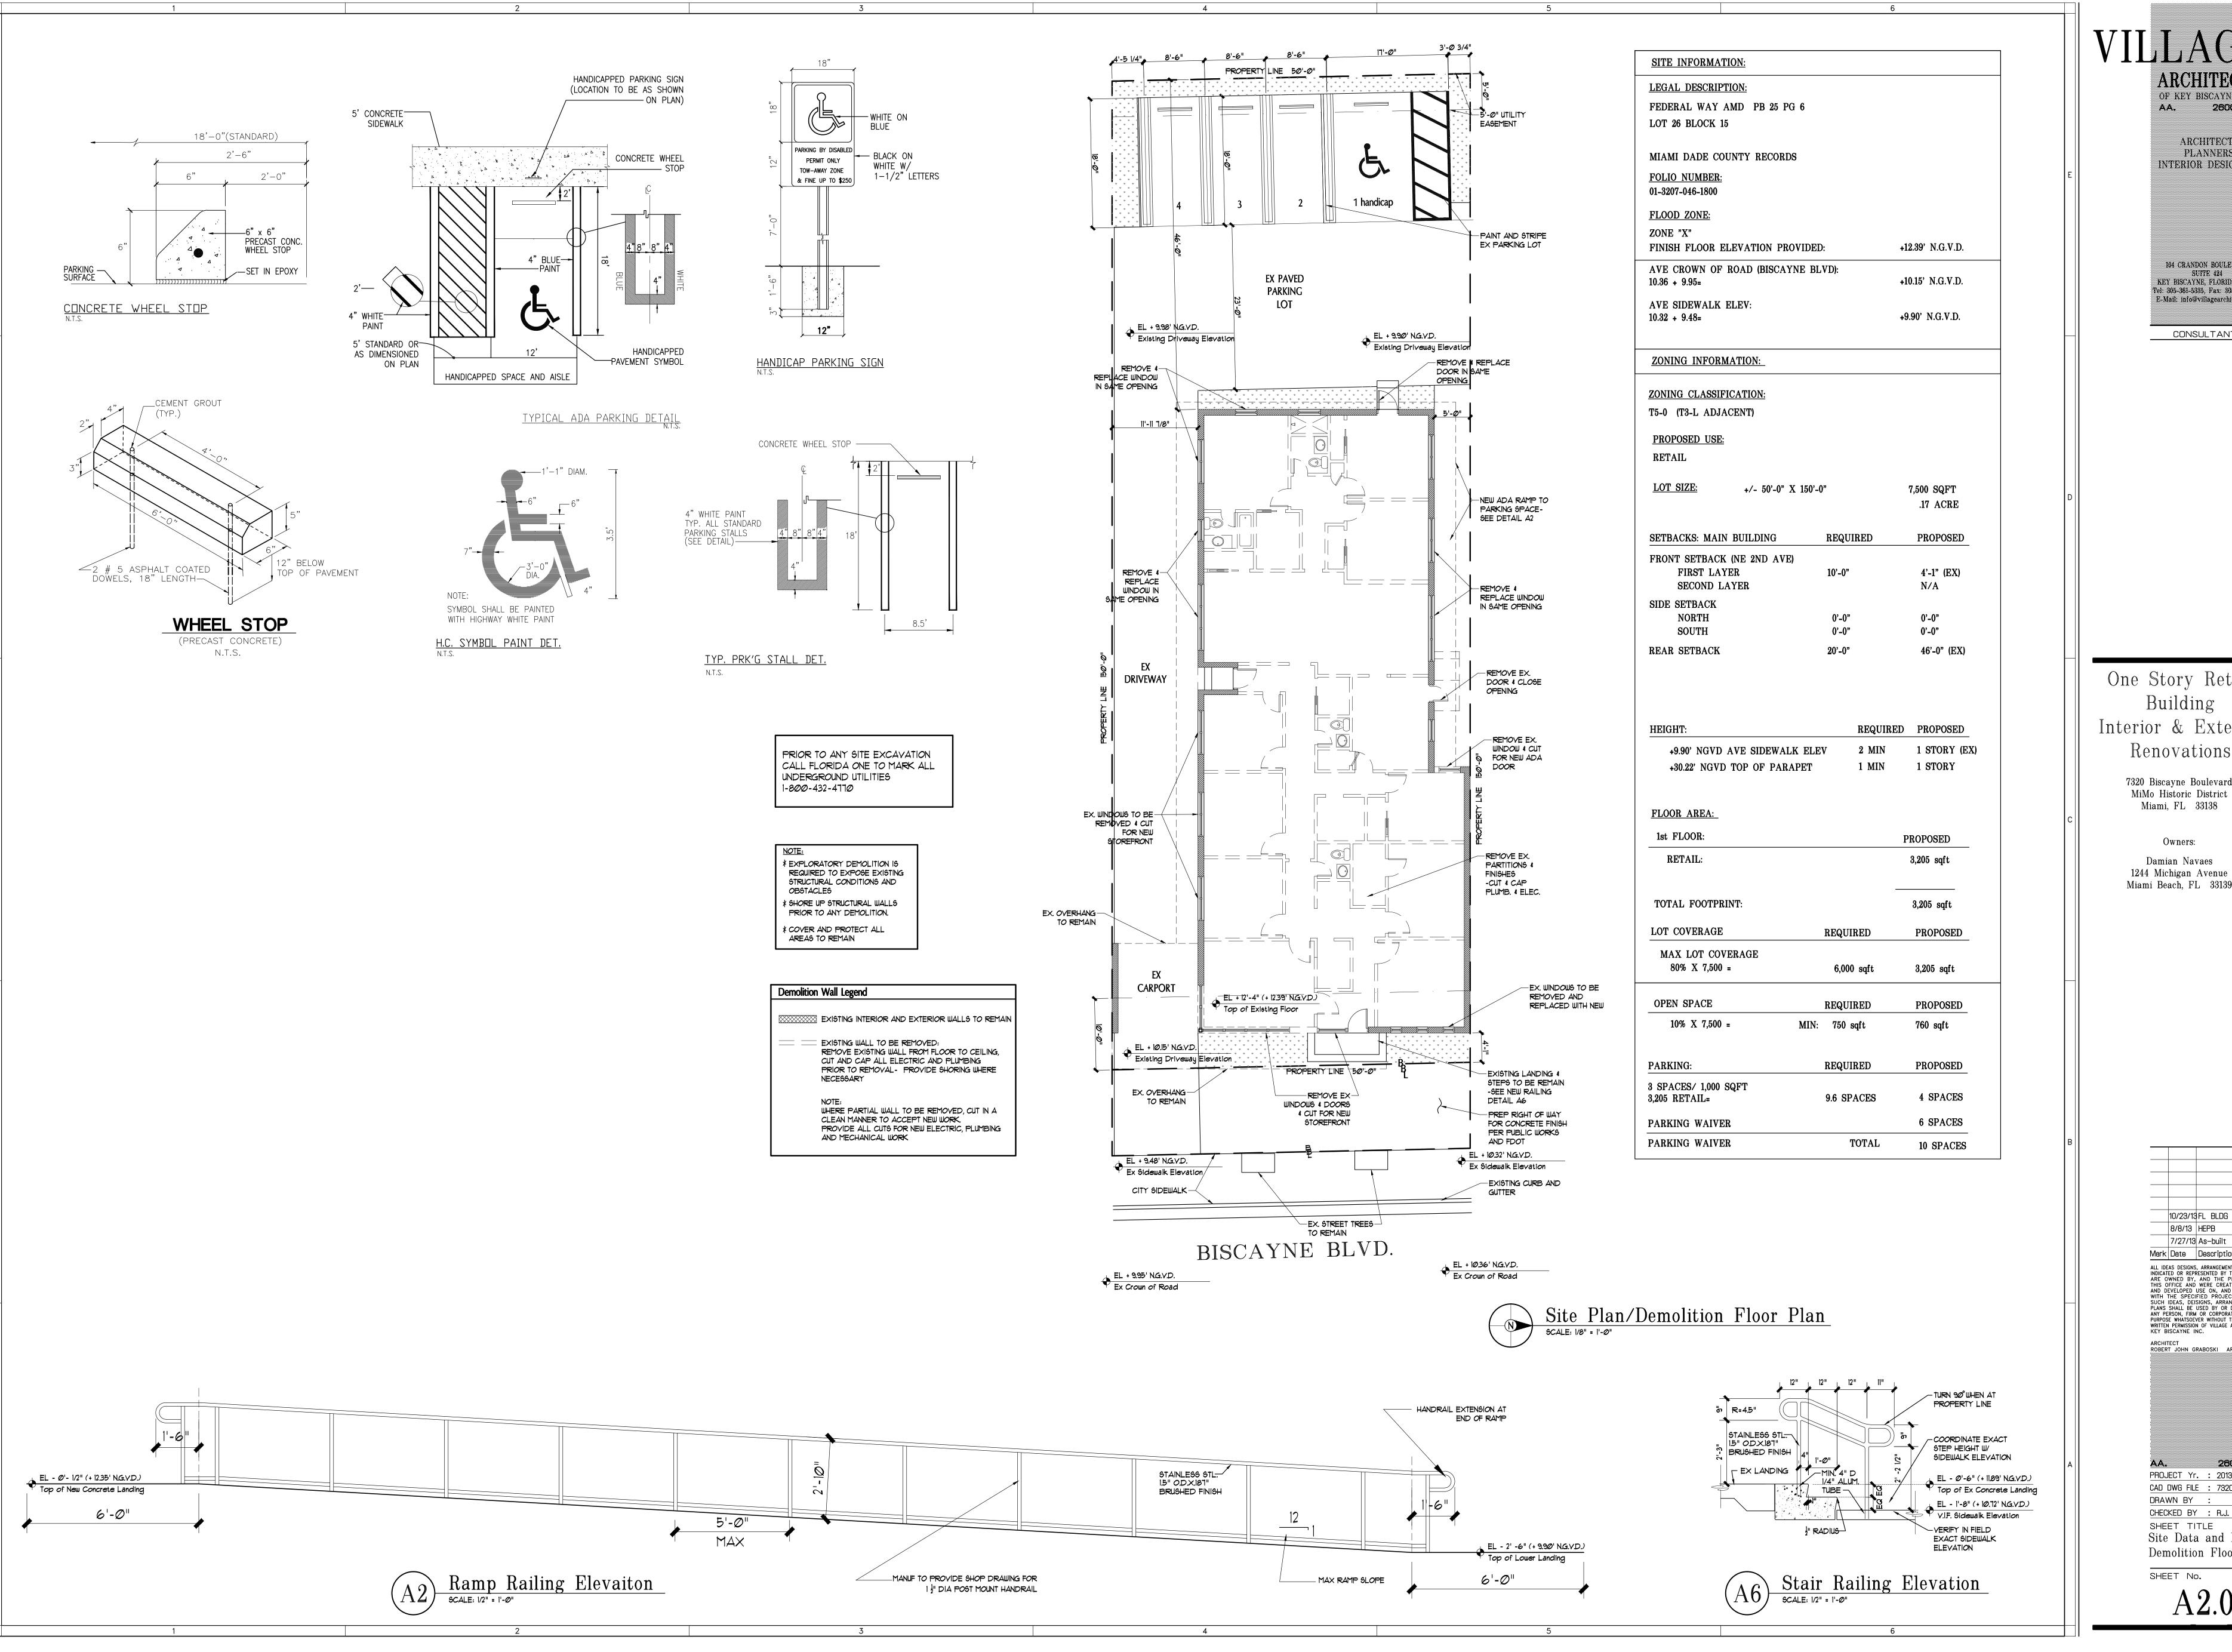

OF KEY BISCAYNE, INC. 26002086 ARCHITECTS PLANNERS INTERIOR DESIGNERS 104 CRANDON BOULEVARD SUITE 424 KEY BISCAYNE, FLORIDA 33149 Tel: 305-361-5335, Fax: 305-361-5329 E-Mail: info@villagearchitects.com CONSULTANTS

## One Story Retial Building Interior & Exterior Renovations

7320 Biscayne Boulevard MiMo Historic District Miami, FL 33138

> Owners: Damian Navaes 1244 Michigan Avenue

> > |10/23/13|FL BLDG COMM 8/8/13 | HEPB 7/27/13 As-built


Mark Date Description ALL IDEAS DESIGNS, ARRANGEMENTS AND PLANS INDICATED OR REPRESENTED BY THIS DRAWINGS ARE OWNED BY, AND THE PROPERTY OF THIS OFFICE AND WERE CREATED, EVOLVED AND DEVELOPED USE ON, AND CONNECTION WITH THE SPECIFIED PROJECT. NONE OF SUCH IDEAS, DEISIGNS, ARRANGEMENTS OR PLANS SHALL BE USED BY OR DISCLOSED TO ANY PERSON, FIRM OR CORPORATION FOR ANY PURPOSE WHATSOEVER WITHOUT THE EXPRESSLY WRITTEN PERMISSION OF VILLAGE ARCHITECTS OF KEY BISCAYNE INC.


ARCHITECT ROBERT JOHN GRABOSKI AR. 0091596

26002085 PROJECT Yr.: 2013 CAD DWG FILE : 7320 BISC DRAWN BY : CHECKED BY : R.J.

SHEET TITLE Site Data and Plan/ Demolition Floor Plan

SHEET No. A2.00

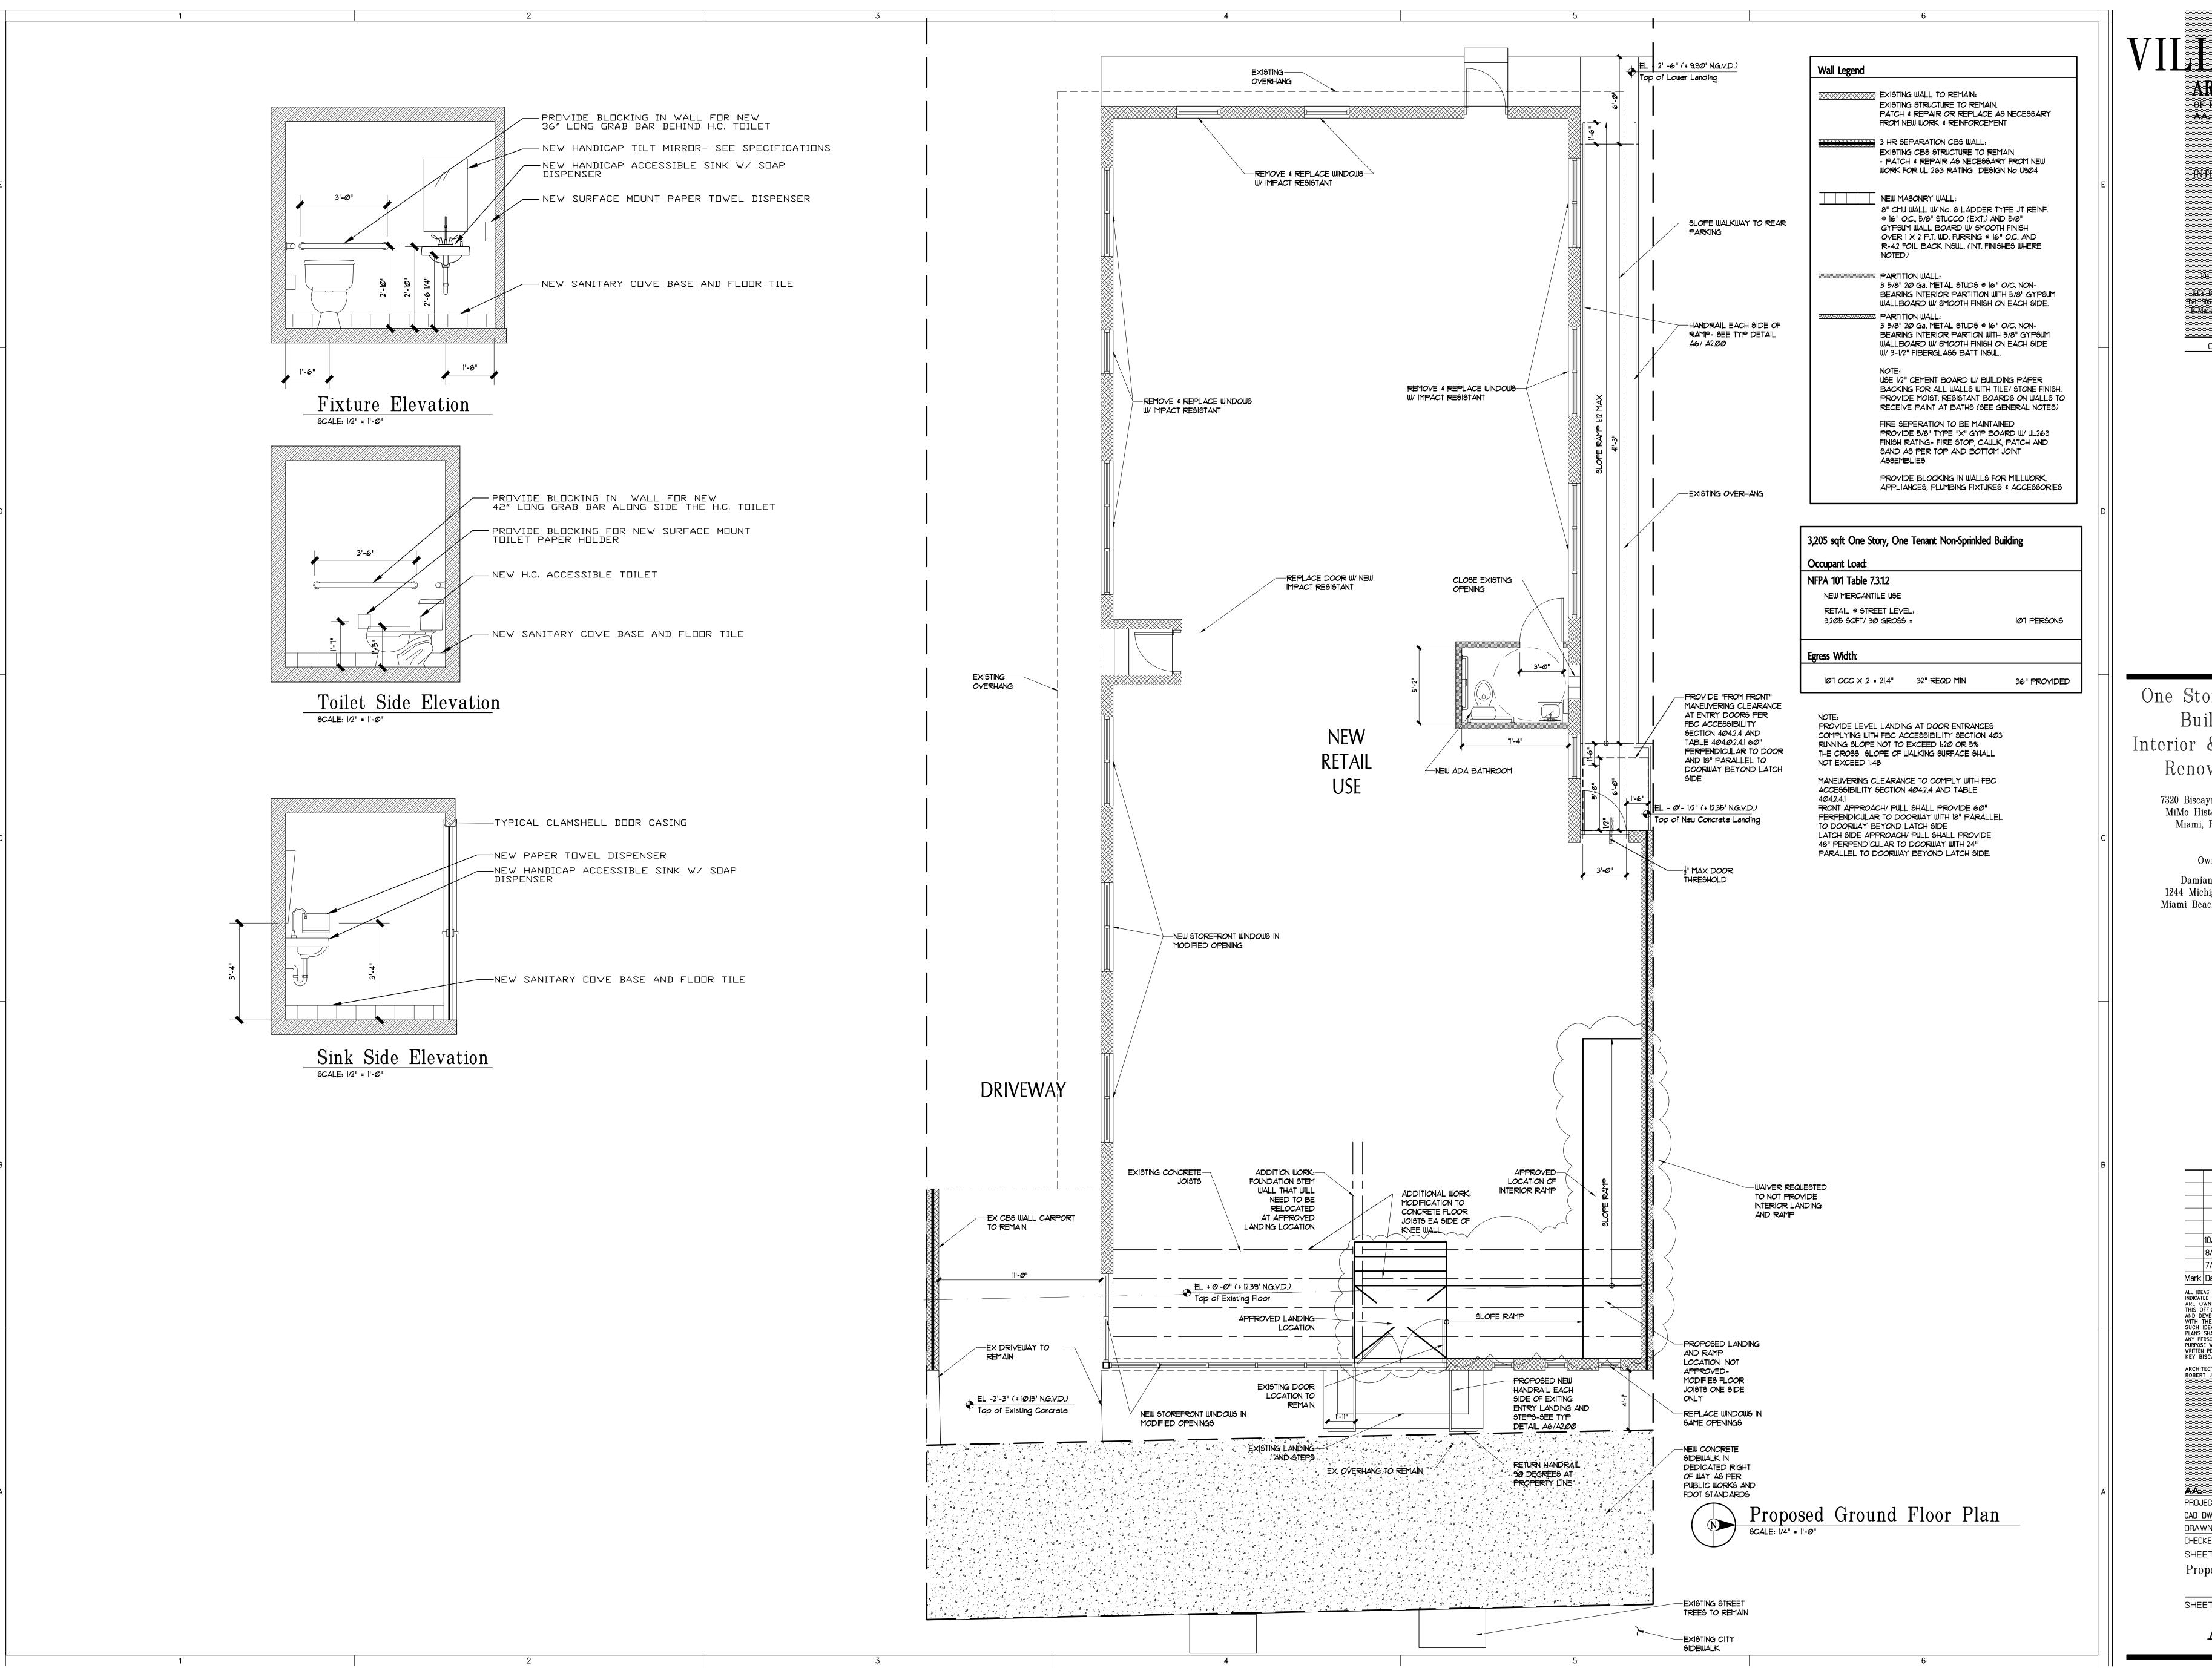

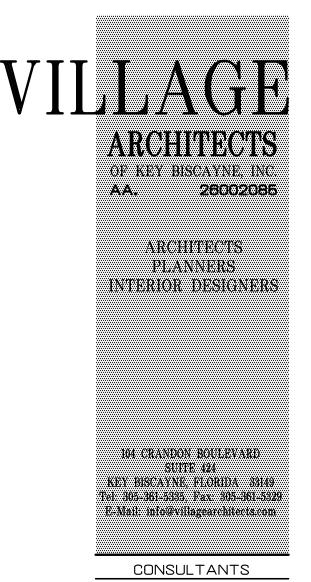

# One Story Retial Building Interior & Exterior Renovations

7320 Biscayne Boulevard MiMo Historic District Miami, FL 33138

Owners:

Damian Navaes 1244 Michigan Avenue Miami Beach, FL 33139

> 10/23/13 FL BLDG COMM 8/8/13 | HEPB 7/27/13 As-built Mark Date Description


ALL IDEAS DESIGNS, ARRANGEMENTS AND PLANS INDICATED OR REPRESENTED BY THIS DRAWINGS ARE OWNED BY, AND THE PROPERTY OF THIS OFFICE AND WERE CREATED, EVOLVED AND DEVELOPED USE ON, AND CONNECTION WITH THE SPECIFIED PROJECT. NONE OF SUCH IDEAS, DEISIGNS, ARRANGEMENTS OR PLANS SHALL BE USED BY OR DISCLOSED TO ANY PERSON, FIRM OR CORPORATION FOR ANY PURPOSE WHATSOEVER WITHOUT THE EXPRESSLY WRITTEN PERMISSION OF VILLAGE ARCHITECTS OF KEY BISCAYNE INC. ARCHITECT ROBERT JOHN GRABOSKI AR. 0091596


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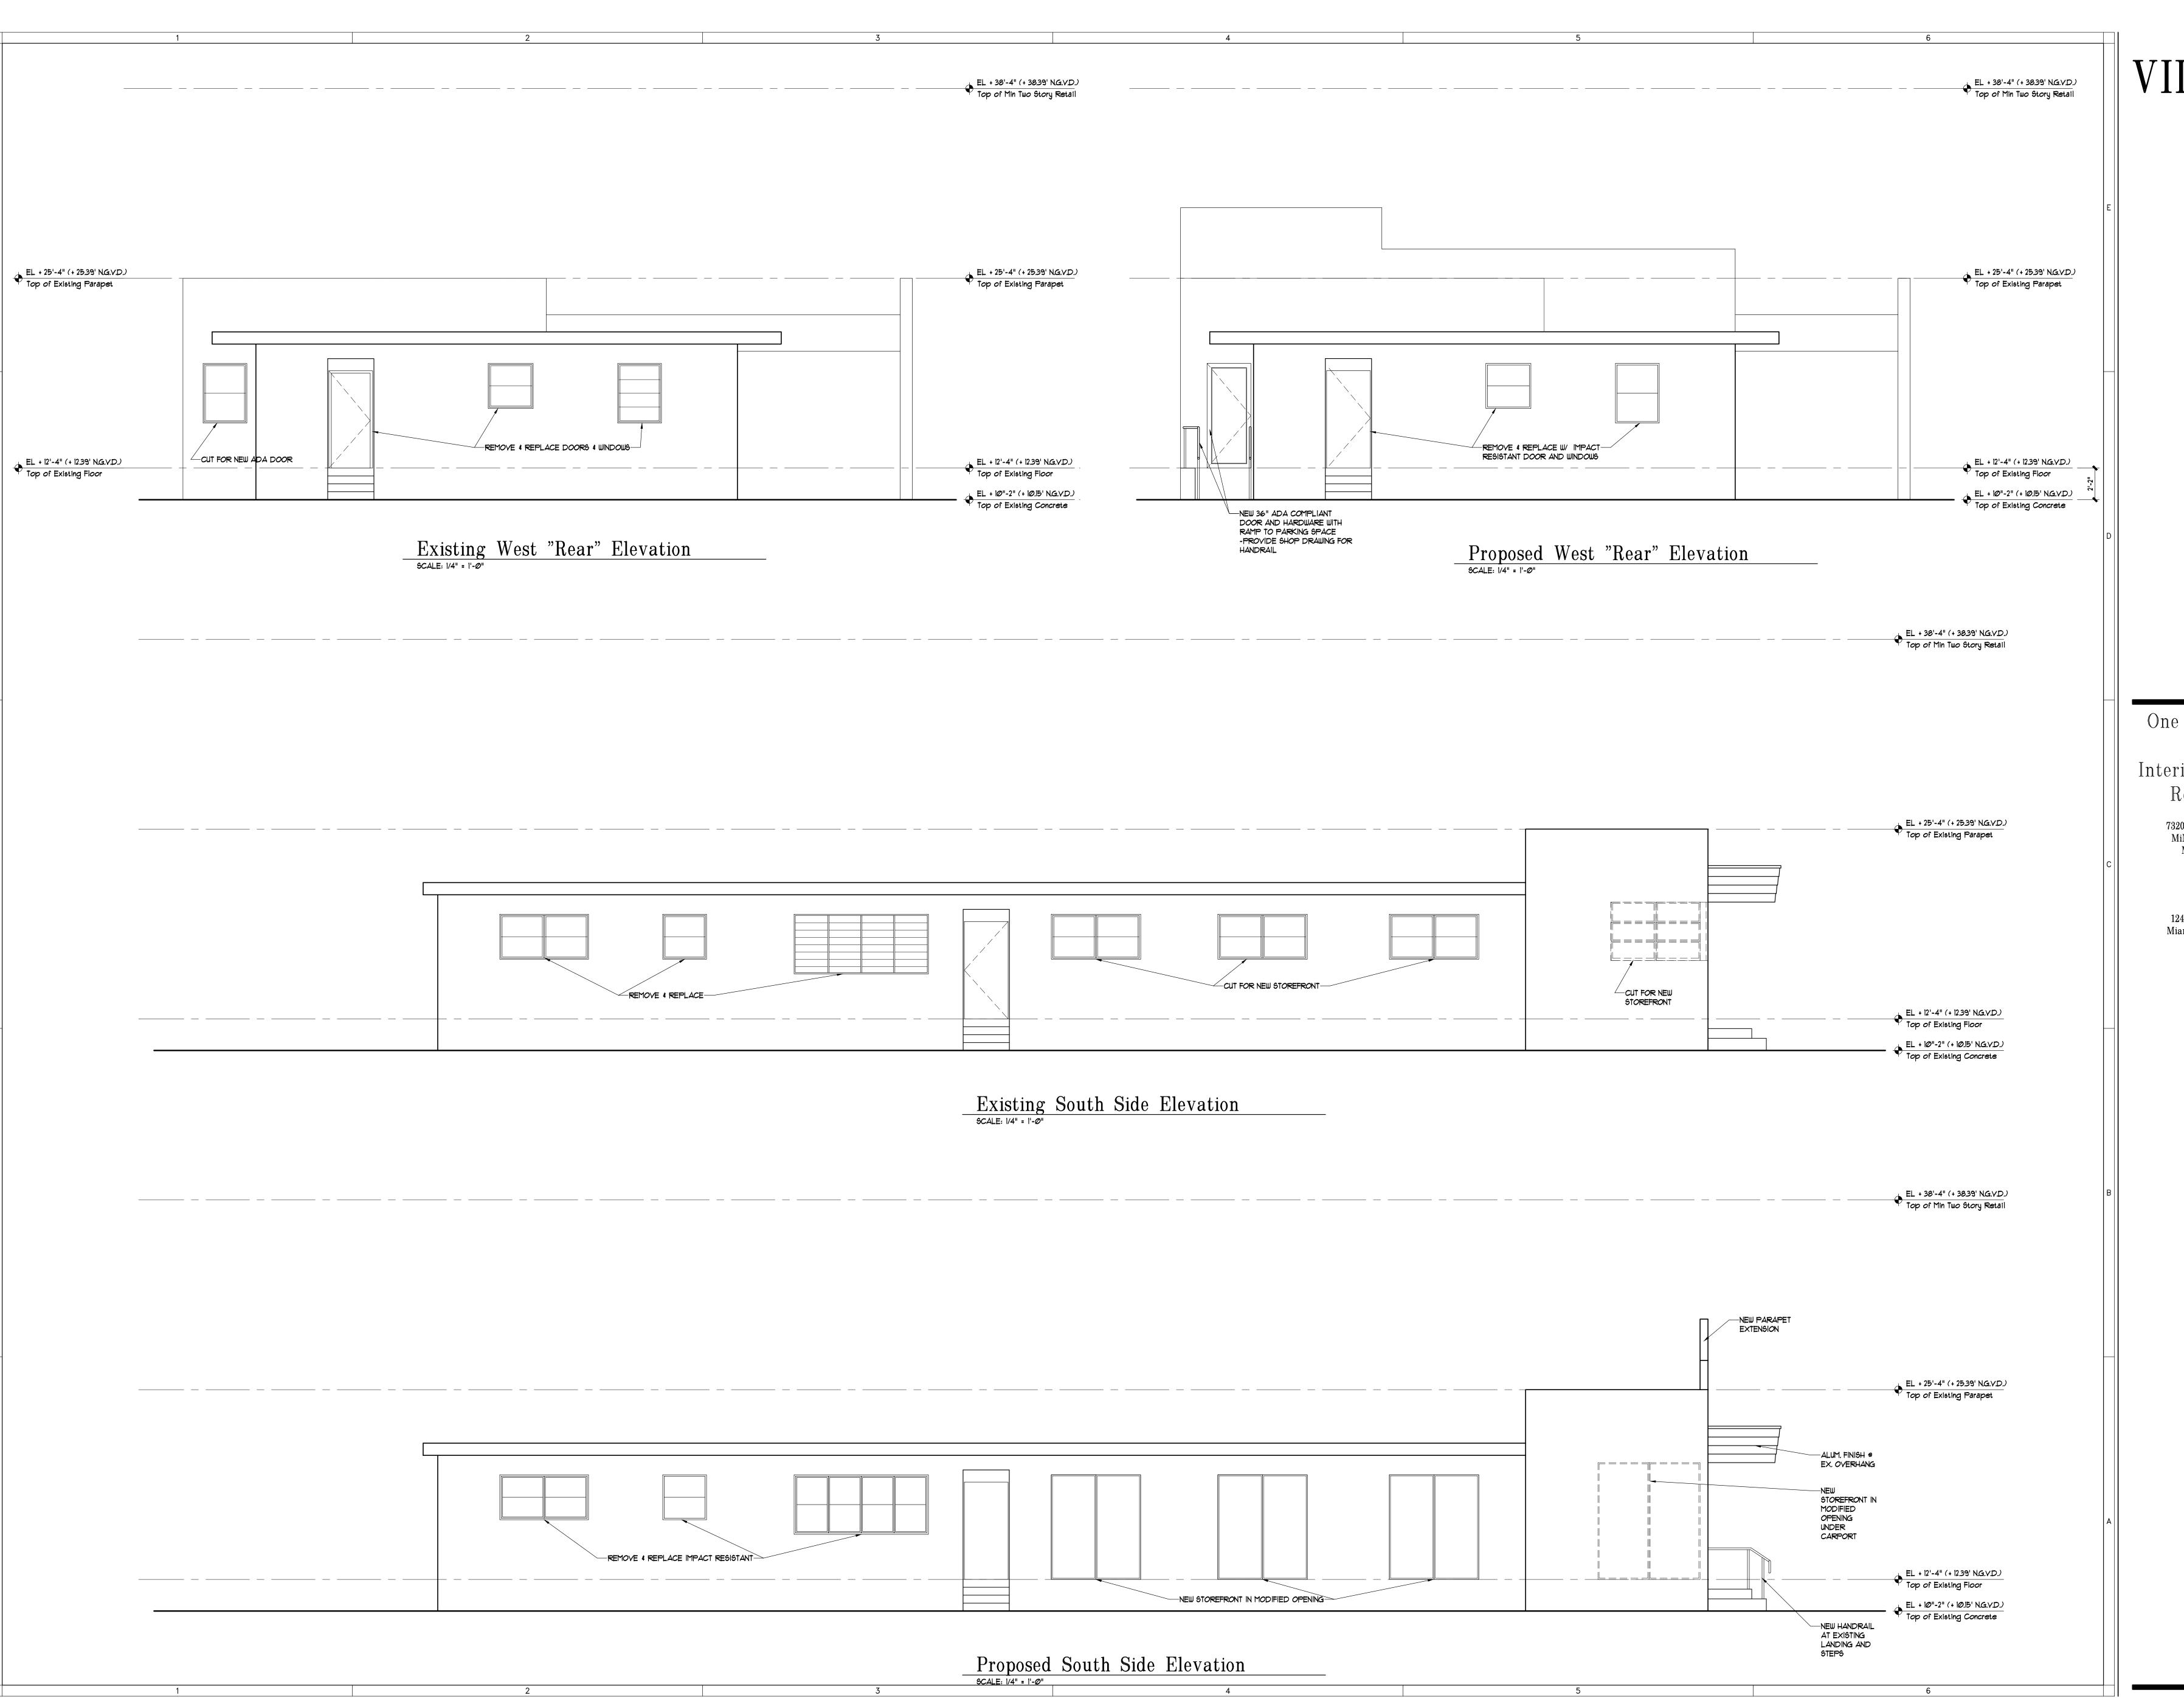
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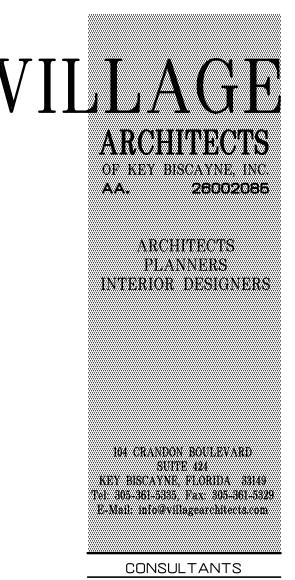
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SHEET No.








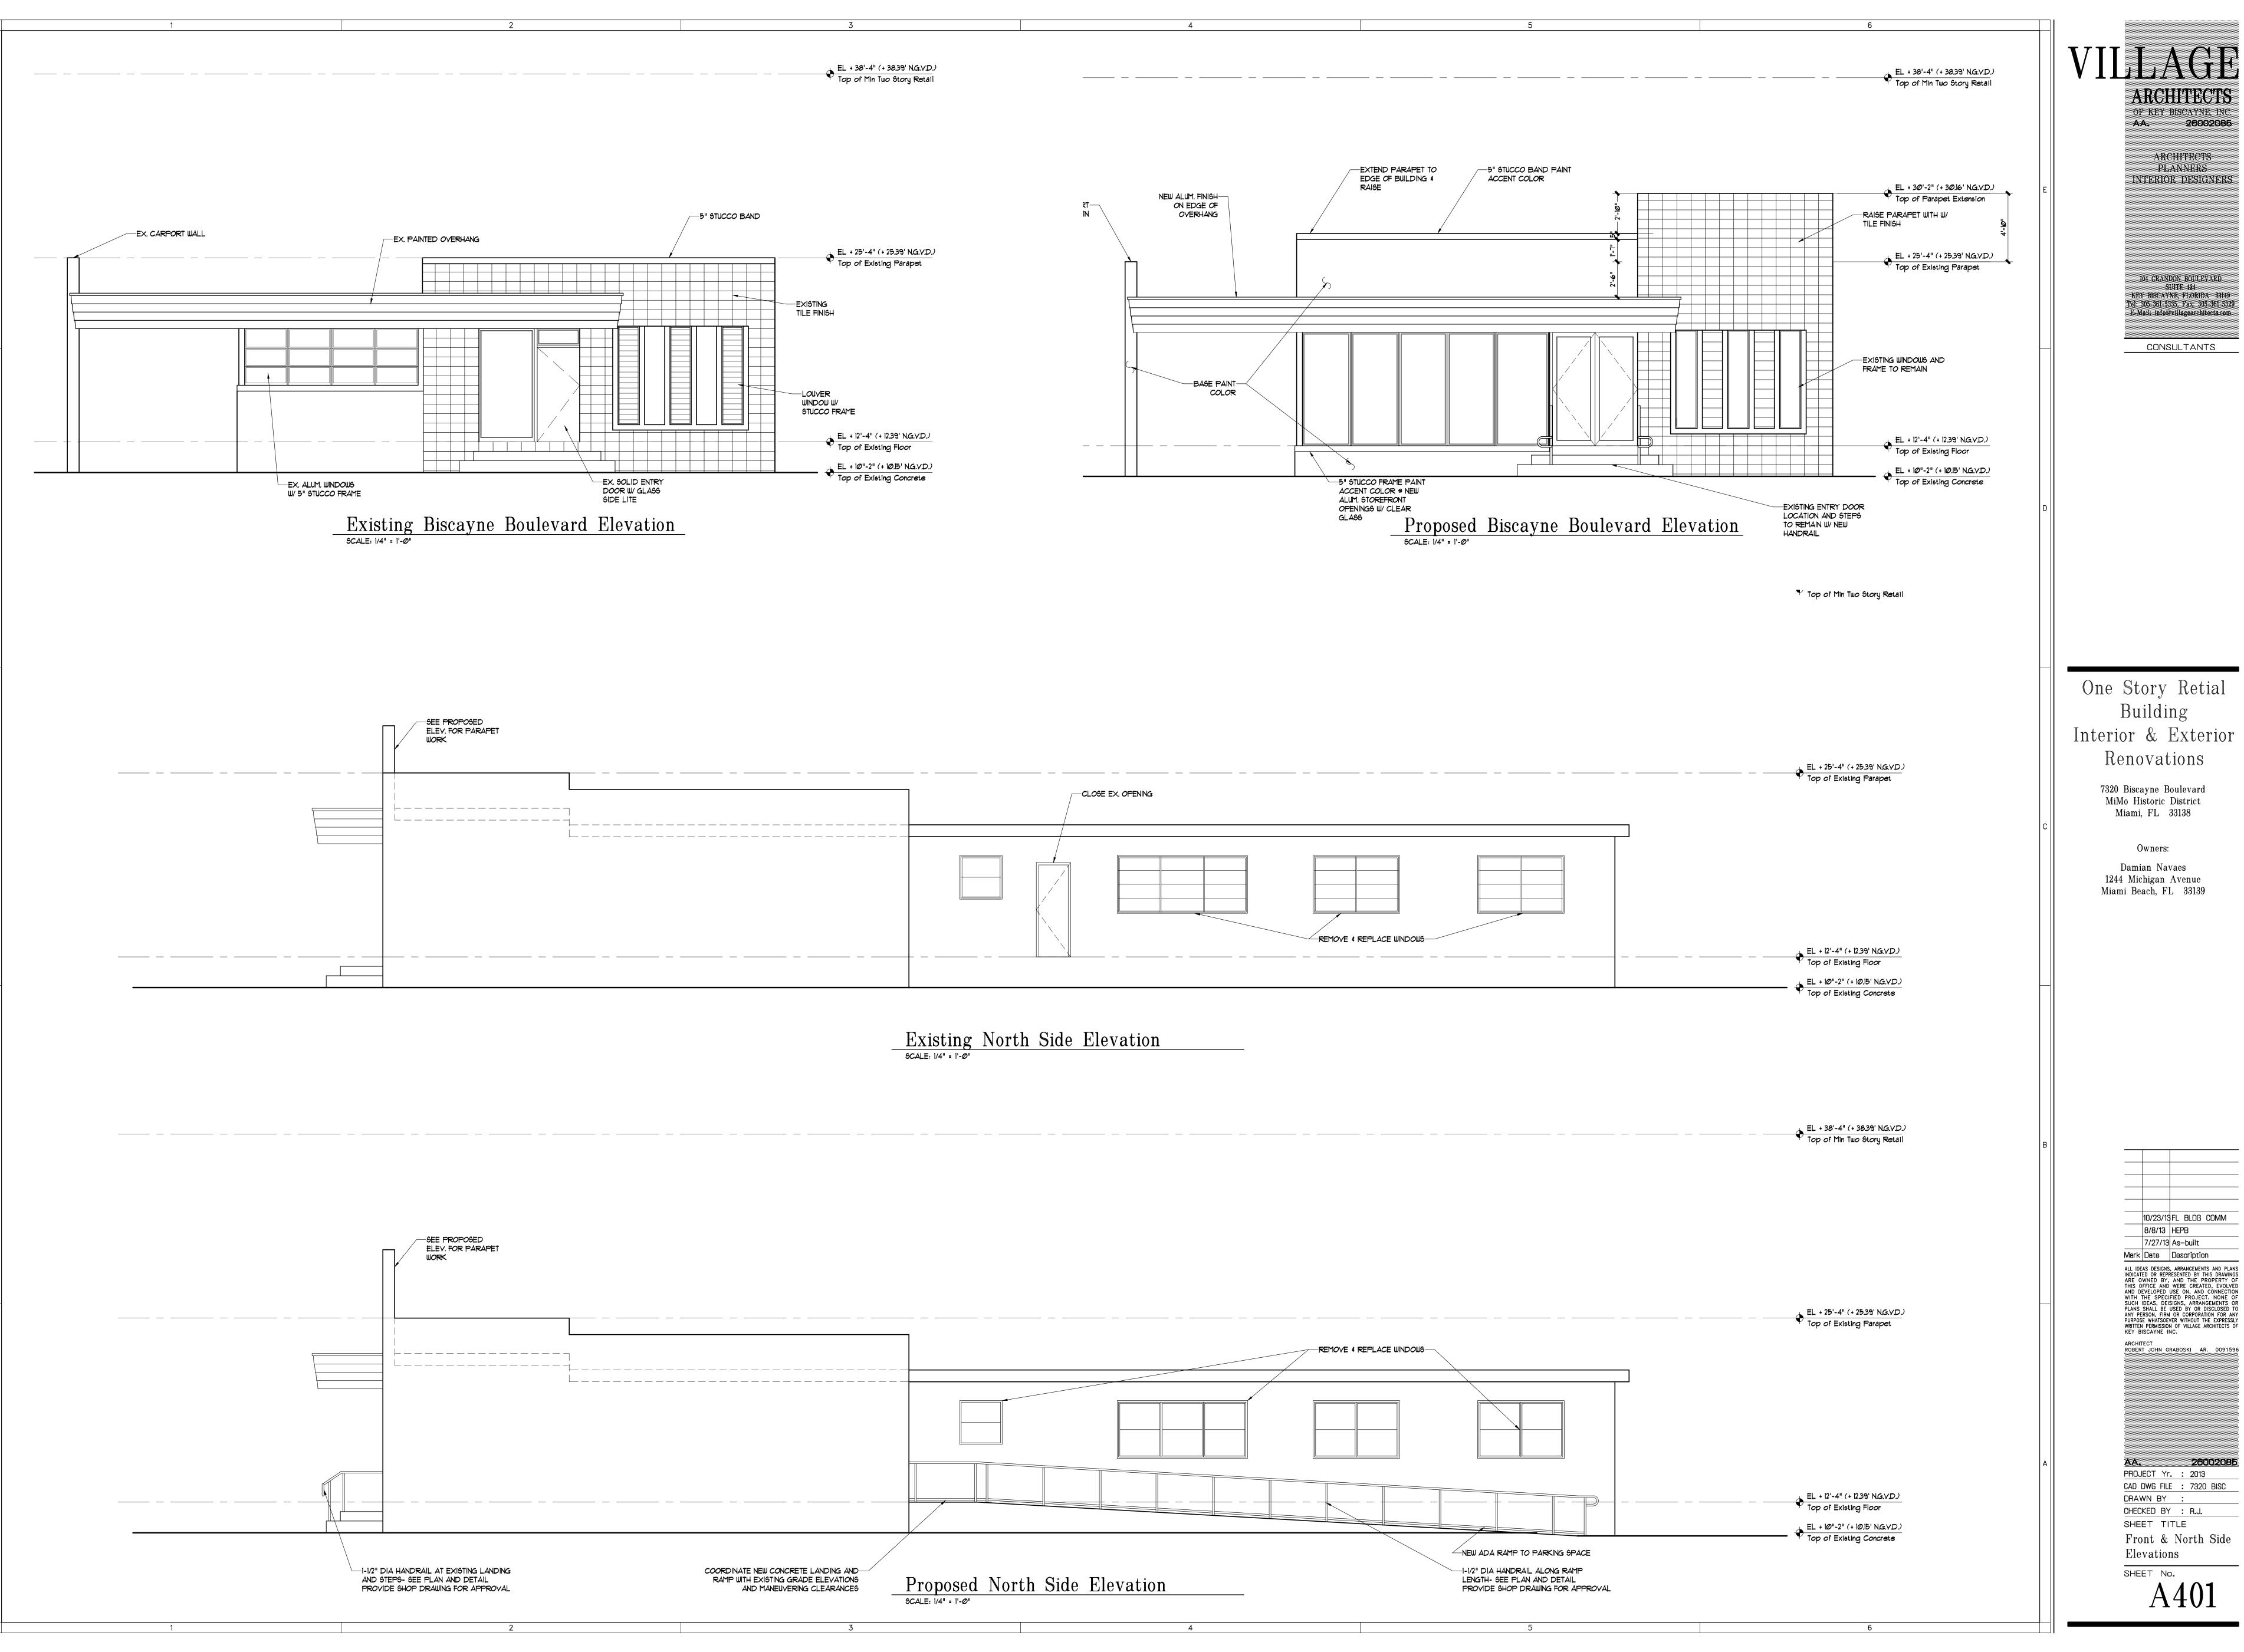

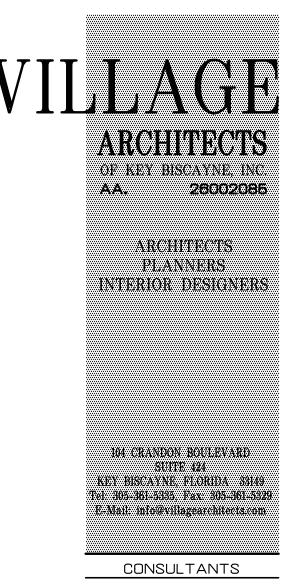One Story Retial
Building
Interior & Exterior
Renovations

7320 Biscayne Boulevard MiMo Historic District Miami, FL 33138

Owners: Damian Navaes 1244 Michigan Avenue Miami Beach, FL 33139

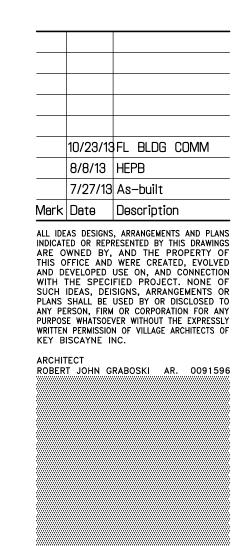

PROJECT Yr. : 2013
CAD DWG FILE : 7320 BISC
DRAWN BY :
CHECKED BY : R.J.
SHEET TITLE
South & West
Elevations

28002085

SHEET No.