Department of Business and Professional Regulation FLORIDA BUILDING COMMISSION

1940 North Monroe Street
Tallahassee, Florida 32399-0772
Form FBC 2012-01
Request for Waiver

NOTICE TO WAIVER APPLICANTS

Please make certain you comply with the following:

- X The person submitting the waiver request application as the Applicant MUST sign the application. Should you fail to do so, your application will be returned.
- X If a licensed design professional (architect or engineer) has designed the project, his or her comments MUST be included as a part of this application.
- X Be as explicit as possible. The more information provided to the Florida Building Commission, the more informed its decisions can be. If you are claiming financial hardship, please specify why and to what degree. Two estimates substantiating a claim for disproportionate cost must be included.
- Petitioners are strongly advised to participate in the Council's conference call, webinar or onsite meeting for application review. Sometimes pertinent facts are inadvertently omitted, or information provided/presented in the Request for Waiver application is not clear. Your participation in the meetings to answer questions will enhance the possibility of the waiver being approved, since the Council and the Commission will receive the most complete information from you. When we receive the completed application, we will send you a notice of the time, date, and place for both the Council and the Commission meetings.

Enclosed is a List of Required Information and the Request for Waiver application.

If you have any questions or would like additional information, please call the Codes and Standards Section at (850) 487-1824.

Please mail this application to the Department of Business and Professional Regulation at the address above. Include a copy of the application, photos where appropriate and drawings or plans on a CD in PDF format. NOTE: Please do not send files in CAD format but rather provide the files in pdf format.

This application is available in alternate formats upon request. LIST OF REQUIRED INFORMATION: 1. Drawings that will clearly present your project and that identify the issue(s) that relate to the waiver you are requesting. As a minimum, the following drawings must be submitted: Project site plan if pertinent to the application 24" x 36" minimum size drawings Building/project sections (if necessary to assist in understanding the waiver request) Enlarged floor plan(s) of the area in question 2. When substantial financial cost of compliance is alleged, supporting cost estimates with quotes from at least two vendors or contractors and catalog information. 3. If you feel photographs and/or renderings are necessary for your presentation, provide legible color copies of the photographs and/or renderings on the CD with the application and plans in jpeg, tif or pdf format. Please submit one hard copy of this application and attachments to the Florida Building Commission, Department of Business and Professional Regulation.

General Information:

a. Verbal Descriptions: Presentations may be to sight or hearing impaired persons; visual presentations should consider adequate verbal and text descriptions of charts and pictures.

Your application will be reviewed by the Accessibility Advisory Council. You will have the opportunity to answer questions and/or make a short presentation **not to exceed 15 minutes**. The Council will provide recommendations to the Florida Building Commission. The Commission will review the application, where you will have another opportunity to answer questions and /or give a short presentation **not to exceed 15 minutes**. The Commission will consider all information and the Council's recommendation before voting on the waiver.

This application is available in alternate formats upon request.

REQUEST FOR WAIVER FROM ACCESSIBILITY REQUIREMENTS OF CHAPTER 553, PART II, FLORIDA STATUTES

Your application will be reviewed by the Accessibility Advisory Council and its recommendations will be presented to the Florida Building Commission. You will have the opportunity to answer questions and/or make a short presentation, not to exceed 15 minutes, at each meeting. The Commission will consider all information presented and the Council's

recommendation before voting on the waiver request.

1. Name and address of project for which the waiver is requested.	
Name: FRESHAVELI	
Address: 20 NE 41 ST # 3 MIAMI, FL 33137	
MIAMI, FL 33137	
2. Name of Applicant. If other than the owner, please indicate relationship of applicant to owner and written authorization by owner in space provided:	
Applicant's Name: MANUEL SOTO	
Applicant's Address: 20 NE AI ST # 3 MIAMI, FU 3	3313
Applicant's Telephone: (787) 396 8274 FAX: (786) 364 7121	
Applicant's E-mail Address: FRESHAVELI® LIVE.COM	
Relationship to Owner: TENANT	
Owner's/Tenant's Name:	
Owner's Address:	
Owner's Telephone: (305)498 1227FAX	
Owner's E-mail Address:	
Signature of Owner:	
3. Please check one of the following: N/A	
[] New construction.	
[] Addition to a building or facility.	
[] Alteration to an existing building or facility.	
[] Historical preservation (addition).	•
[] Historical preservation (alteration).	

	Type of face of the build). Defin	e the
	COMME	FRCI	AU B	uiu	ING	2 F1	,00k	<u>S</u>	4 Ur	VITS	
	2877										FT
	STYLIN	IG C	PFICI	= (1	BAPB	ER SH	OP 1	. CH1	tip)		
 5. a	Project Co	enstruct t	ion Cos	t (Provi	ide cost a	for new	constru i	o	the addi	tion, or	the
tin	Project State of this app	olication	. Describ	e status.		nstruction	that bes	t describ	oes your	project a	t the
	In Plan Revi										
*]	Briefly expla	in why 1	the reque	st has no	w been r	eferred to	the Con	nmission	ı .		
	PEQL	IEST	ing	WA	FIVER	- FOI	2 A	CCES	SIBI	UM	1
	LIFT.(1	ELEV	1ATOR	-)	*****			· · · · · · · · · · · · · · · · · · ·		·········	
									<u></u>		
					· · · · · · · · · · · · · · · · · · ·			***************************************		······································	
	Requiremer aly Florida-s _l							olicable	section o	f Florida	ı law.
Iss	sue										
1:_		· · · · · · · · · · · · · · · · · · ·		· · · · · · · · · · · · · · · · · · ·	· · · · · · · · · · · · · · · · · · ·			- 	······································	titus statistics and a statistics	
Iss	ue										
2:_	····							-1	· · · · · · · · · · · · · · · · · · ·		

Issue
3:
8. Reason(s) for Waiver Request: The Florida Building Commission may grant waivers of Florida-specific accessibility requirements upon a determination of unnecessary, unreasonable or extreme hardship. Please describe how this project meets the following hardship criteria. Explain all that would apply for consideration of granting the waiver.
[] The hardship is caused by a condition or set of conditions affecting the owner which does not affect owners in general.
Substantial financial costs will be incurred by the owner if the waiver is denied.
COSTS EXCEEDING BUDGET-
[] The owner has made a diligent investigation into the costs of compliance with the code, but cannot find an efficient mode of compliance. Provide detailed cost estimates and, where appropriate, photographs. Cost estimates must include bids and quotes.
9. Provide documented cost estimates for each portion of the waiver request and identify any additional supporting data which may affect the cost estimates. For example, for vertical accessibility, the lowest documented cost of an elevator, ramp, lift or other method of providing vertical accessibility should be provided, documented by quotations or bids from at least two vendors or contractors.
a. \$31,500. DOES NOT INCLUDE REQUIRED
PIT
b

C	
comments MUST be in	rofessional: Where a licensed design has designed the project, his or her necluded and certified by signature and affixing of his or her professional
seal. The comments mu	st include the reason(s) why the waiver is necessary.
Signature	Printed Name
Phone number	
(SEAL)	

CERTIFICATION OF APPLICANT:

I hereby declare that the applicable documents in support of this Request for Waiver are attached for review by the Florida Building Commission and that all statements made in this application are to the best of my knowledge true and correct.

Dated this 5 day of July 2013
Signature
MANUEL SOTO

Printed Name

I understand that if I falsify, misrepresent, or omit any material information on this document, the Commission may revoke any order and will notify the building official of the permitting jurisdiction.

KNOWINGLY MAKING A FALSE STATEMENT IN WRITING WITH THE INTENT TO MISLEAD A PUBLIC SERVANT IN THE PERFORMANCE OF HIS OFFICIAL DUTY IS A MISDEAMEANOR OF THE SECOND DEGREE PURSUANT TO SECTION 837.06 F.S. AND SECTION 775.083, F.S.


REVIEW AND RECOMMENDATION BY LOCAL BUILDING DEPARTMENT.


Please state why the issue is being referred to the Florida Building Commission as well as a recommendation for disposition. The Building Official or his or her designee should review the application and indicate that to the best of his or her knowledge, all information stipulated herein is true and accurate. Further, if this project is complete, explain why it is being referred to the Commission. The Building Official or his or her designee should sign a copy of the plans accompanying this application as certification that such plans are the same as those submitted for building department review. Please reference the applicable section of the Accessibility Code.

a	
b	
c	
Has there been any p so, what was the cos	permitted construction activity on this building during the past three years? st of construction?
[] Yes [] No Cost o	f Construction
Comments/Recomm	mendation
Jurisdiction	
Building Official or	Designee
	Signature
	Printed Name
	Certification Number
	Telephone/FAX
	Email Address
Address:	

Certification of Licensed Design Professional for Replicated Designs to be Placed on Consent Agenda Note: Fill out pages _____ only for cases in which design documents are duplicates of previously approved waivers and the project can be placed on a Consent Agenda. I,______, a licensed architect/engineer in the state of Florida, whose Florida license number is ______, hereby state as follows: 1. I am the architect/engineer of record for the project known as (name of project) , for which the Owner seeks a waiver of one or more accessibility requirements in an application to which this Certification is attached. 2. I hereby certify that to the best of my knowledge and belief to the Florida Building Commission that the design documents for the (insert project described in paragraph 1 above) are the same as the design documents previously submitted to the Commission and referenced in paragraph 3 below, except that the two projects are built or to be built on different parcels of land at different locations. 3. The licensed design professional of record (identify the licensed design professional of _____, prepared the design documents record), for the project known as for which the majority of the Accessibility Advisory Council recommended approval and the Commission granted a waiver of one or more accessibility requirements in Final Order No. Printed Name: _____ Affix certification seal below: Address: Telephone:

E-Mail Address:

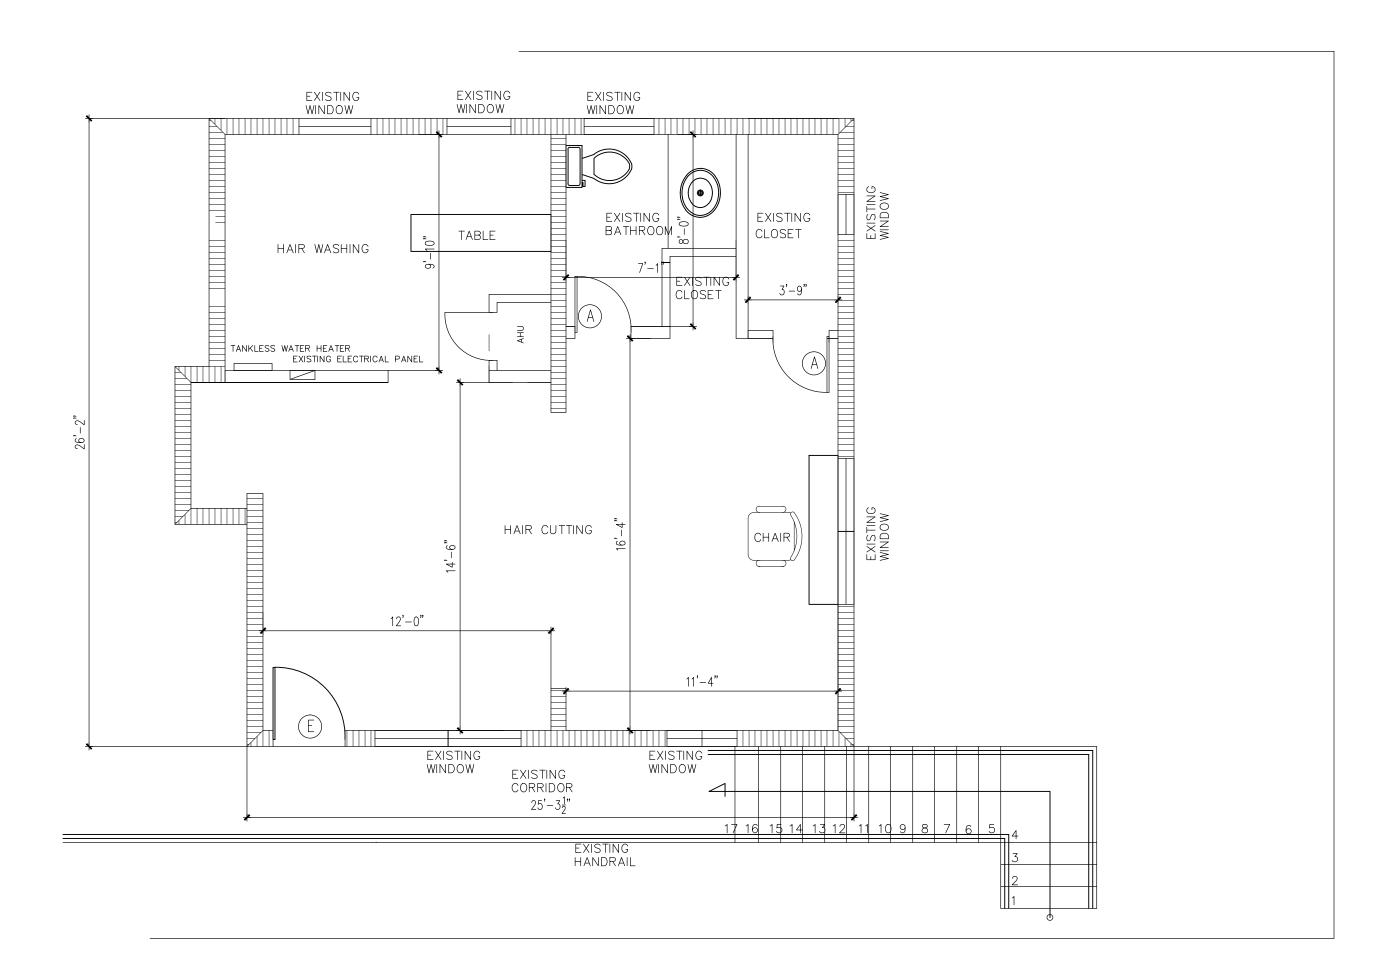

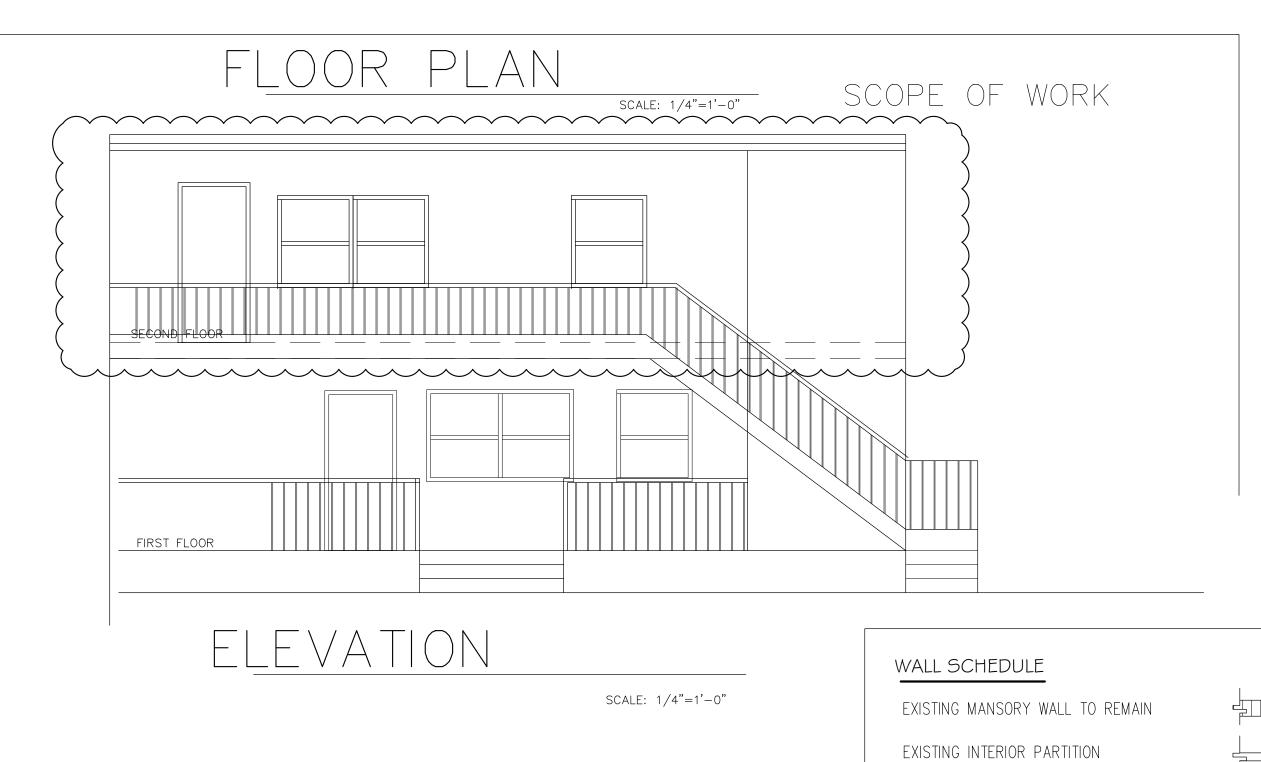



KEY PLAN LOCATION



SCALE: 1/4"=1'-0"



			DOOR	SC	HED	ULE	-	
	MARK	DESCRI	PTION		SIZE		MATE	RIAL
	IVIT VI VI V	DEGOIN	1 11011	W	Н	Т	DOOR	FRAME
	A	H.C WOOD	(EXISTING)	2'-4"	6'-8"	1 3/4"	WOOD	WOOD
2.	E	EXISTING		3'-0''	6'-8"	1 3/4"	METAL	MTL

NOTES:

1. OPEN TO OUTSIDE
2. HANDICAP ACCESS AND HARDWARE

SAFETY NOTES FOR DOORS

(CLOSETS AND BATHROOMS)

NFPA 101 - 1994 CHAPTER-21

(21-2,4,3) EVERY CLOSET DOOR LATCH SHALL BE SUNCH THAT CHILDREN CAN OPEN THE DOOR FROM INSIDE THE CLOSET

(21-2,4) EVERY BATHROOM DOOR LOCK SHALL BE DESIGNED TO PERMIT THE OPENING OF THE LOCKED DOOR FROM THE OUTSIDE IN AN EMERGENCY.

INDEX OF DRAWINGS

SHEET 1: (A1) FLOOR PLAN AND KEY PLAN SHEET 2: (A2) LIFE SAFETY PLAN

SHEET 3: (MI) EXISTING MECHANICAL PLAN


SHEET 4: (P-I) EXISTING PLUMBING

SHEET 4: (E-I) EXISTING ELECTRICAL

SCOPE OF WORK

AS BUILT OF A NEW STYLE OFFICE.
CHANGE OF USE APPLICATION: PRIOR OCCUPANCY
RESIDENTIAL.

TOTAL AREA = 602 SQ. FT.

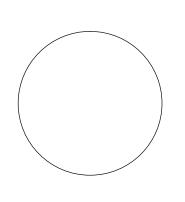

DESIGN 2004
PRODUCTIONS LLC
CA # 9844
ENGINEERING SERVICES
F.N # G02308900335

513854-0 01 01318 4471 N.W. 36 ST. SUITE # 206 MIAMI SPRINGS

FLORIDA 33166

MOBIL (305)-915-7625

E-MAIL D2004PRODU	JCTION@AOL.NET
REVISION	BY:

GILBERTO GAVARRETE
Professional Engineer
Professional Engineer
51371
State of Florida
SEAL, SIGN AND DATE:

PERSONAL STYLING OFFICE


TO: FRESHAVELI — MANUEL SOTO

UNIT 3

20 NE 41 ST. MIAMI FL

BY:	
05/-2013	
3:	
	05/-2013

 $\triangle - 1$

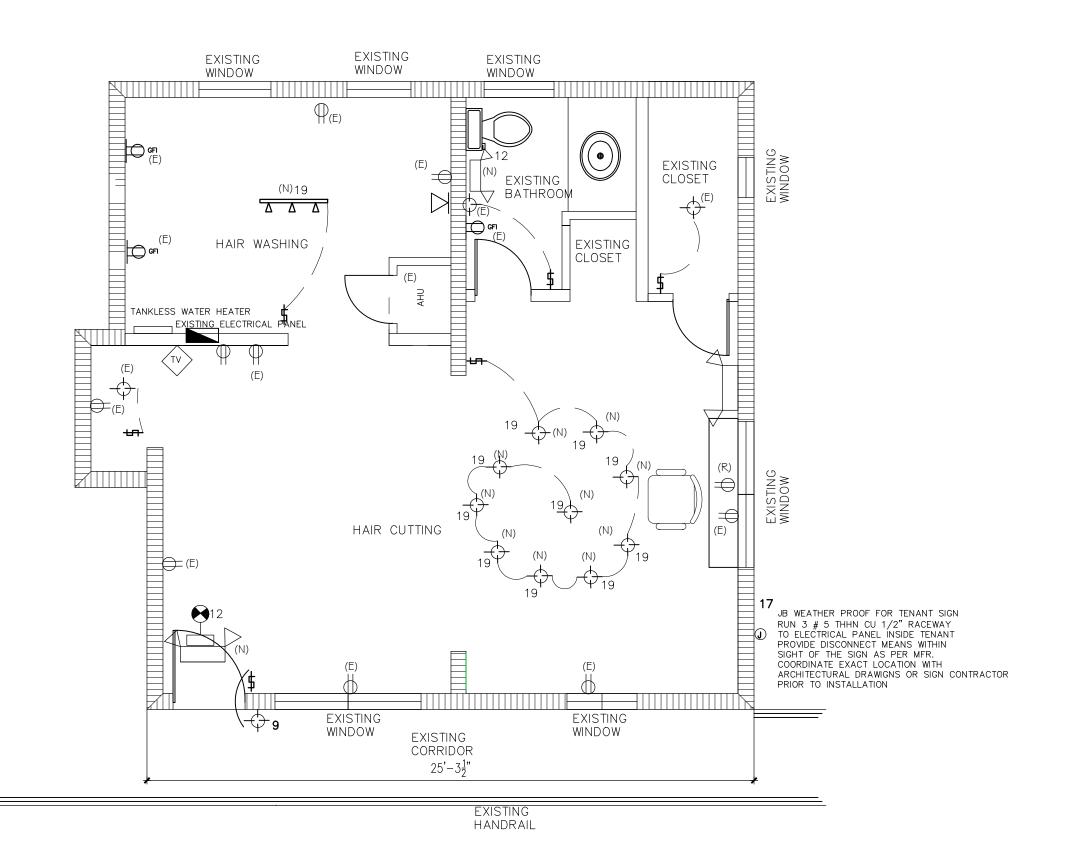

ELECTRICAL	PLAN	
SCALE $1/4" = 1'$		

			_													(EXISITNG)		_
	PAN	NEL	AMPS	VO	LTAGE	CIRCUITS	WIRE	PHASE	MAI	N/AIC		MOU	NTING	L	OCATION	CATALOG NUM	1BER		
	А		150	120	/240	24		1	22.0 SERIES		ED	FLUSI	1	IN:	SIDE				
	CKT.		COND	CKT	BKR					CKT.		COND	CKT	BKR					
	NO.	WIRE	INCH F	POLE	AMPS	SE	ERVING	;	WATTS	NO.	WIRE	INCH	POLE	AMPS	SER'	VING		WATTS	
	1	8	3/4	2	50				1700	2	8	3/4	2	30	W.H.			11.400	
	5 7	8	1	2	60	AHU UNI	Т		5327	6 8	8	1	2	50	C.U UNIT			5000	
	9	12	1/2	1	20	LIGHTS			1080	10]
	11	12	1/2	1	20	REF			700	12	12	1/2	1	20		LIGHTS & EXIT	SIGN	360	(N
	13	14	1/2	1	15	RECEPTA	CLES		540	14	10	12	1/2	1	20 WINDO	W SIGN		1600	
	15	12	1/2	1	20	RECEPTA			270	16									
(N)	17	12	1/2	1	20	EXTERIOR	SIGN		1200	18									
(N)	19	12	1/2	1	20	LIGHTS			660	20									
	21	_	_	_	_	SPACE			_	22									
	23	_	_	-	-	SPACE			_	24]

CONNECTED LOAD = 29837 W AMPERES @ 240 V/ 10 = 125 A.

ELECTRICAL LEGEND

COMBO OF EXIT SIGN & EMERGENCY LIGHT WITH BATTERY BACK UP

EMERGENCY LIGHT
WITH BATTERY BACK UP
TELEPHONE JACK

ELECTRICAL PANEL

ELECTRICAL METER

□ G.F.C.I. 110 DUPLEX OUTLET

(E) existing fixture to remain

EXHAUST FAN VENTILATION


t TOGGLE SWITCH

LIGHTING FIXTURE

GENERAL ELECTRICAL NOTES

- ALL ELECTRICAL WORK PERFORMED UNDER THIS CONTRACT SHALL COMPLY WITH LOCAL CODES AND ORDINANCE & ALL STANDARDS OF CONSTRUCTION ESTABLISHED BY THE LANDLORD.
- ALL CONDUCTORS SHALL BE THHN OR THWN COPPER. ALL EXPOSED CONDUITS SHALL BE RUN AS NEAT AS POSSIBLE AND PAINTED TO MATCH COLOR OF SURROUNDINGS. P.V.C. CONDUIT SHALL ONLY BE USED IN SLAB OR UNDERGROUND AT A MINIMUM DEPTH OF 24".
- FLEXIABLE CONDUIT SHALL BE USED FOR CONNECTION TO ALL VIBRATING EQUIPMENT SUCH AS MOTORS, ETC.
- ALL WIRING DEVICES SHALL BE LEVITON "DECORA" SERIES OR EQUAL AS APPROVED BY ARCHITECT OR ENGINEER. COLOR SELECTED BY ARCHITECT.
- ALL RECEPTACLES SHALL BE INSTALLED AT 12"A.F.F. UNLESS CONTRACTOR.
 OTHERWISE NOTED.
- ELECTRICAL POWER AND CONTROL WIRING FOR HVAC AND MECHANICAL EQUIPMENT SHALL BE FURNISHED AND INSTALLED BY THE ELECTRICAL

- ELECTRICAL CONTRACTOR SHALL VERIFY THE CEILING FINISHES AND SUSPENSION SYSTEM FOR SELECTION OF THE PROPER TRIM AND SUPPORT ARRANGEMENT OF THE FIXTURE.
- ELECTRICAL CONTRACTORS SHALL COORDINATE HIS WORK WITH THE ARCHITECT BEFORE ROUGH INSTALLATION OF LIGHTS, RECEPTACLES, SWITCHES AND EQUIPMENT FOR EXACT LOCATIONS.
- ALL ELECTRICAL EQUIPMENT MUST BE U.L. APPROVED.
- NEW FIRE ALARM DEVICES SHALL BE FROM SAME MANUFACTURER AND 100% COMPATIBLE WITH EXISTING BUILDING FIRE ALARM SYSTEM. THE ELECTRICAL CONTRACTOR SHALL SUBMITT FOR PERMIT COMPLETE FIRE ALARM SHOP DWGS. SHOWING CONNECTIONS OF NEW DEVICES WITH THE EXISTING FIRE ALARM PANEL.

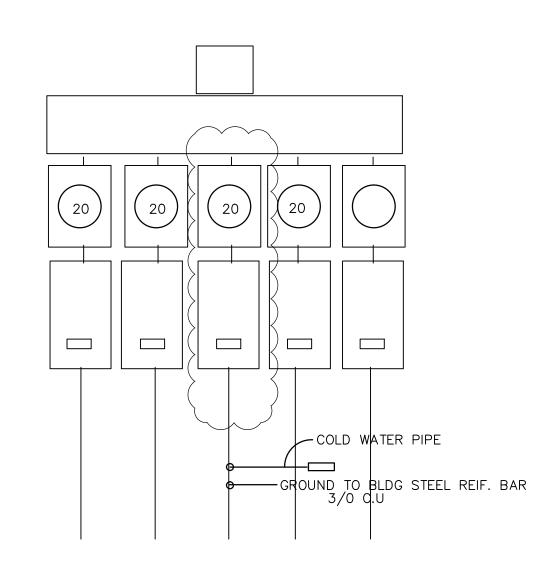


ELECTRICAL RISER
DIAGRAM (EXISTING TO REMAIN AT THIS FLOOR) CONDITION NO WIRE SIZED VERIFIED,
NO WORK TO BE PERFORMANCE

SCOPE	OF	WORK


ADD TWO NEW ELECTRICAL CIRCUITCONNECTION FOR NEW FIXTURES LIGHTS, SIGN AND EMERGENCY LIGHTS TO BE CONNECTED TO THE EXISTING ELECTRICAL PANEL SHOWN.

DESIGN 20 PRODUCTION CA # 98 ENGINEERING SE F.N # G02308900 513854-0 01 01318 4471 N.W. 36 SUITE # 206 MIAMI SPRINGS FLORIDA 33166 MOBIL (305)-9	NS LLC 344 RVICES 0335 ST.
E-MAIL D2004PRODU	JCTION@AOL.NET
REVISION	BY:
GILBERTO GAVARRETE Professional Engineer Professional Engineer # 51371 State of Florida	SEAL, SIGN AND DATE:
PROPOSED NEW PERSONAL STYLING OFFICE TO: FRESHAVELI — MANUEL SOTO UNIT 3	20 NE 41 ST. MIAMI FL
DRAWN BY:	
SCALE:	

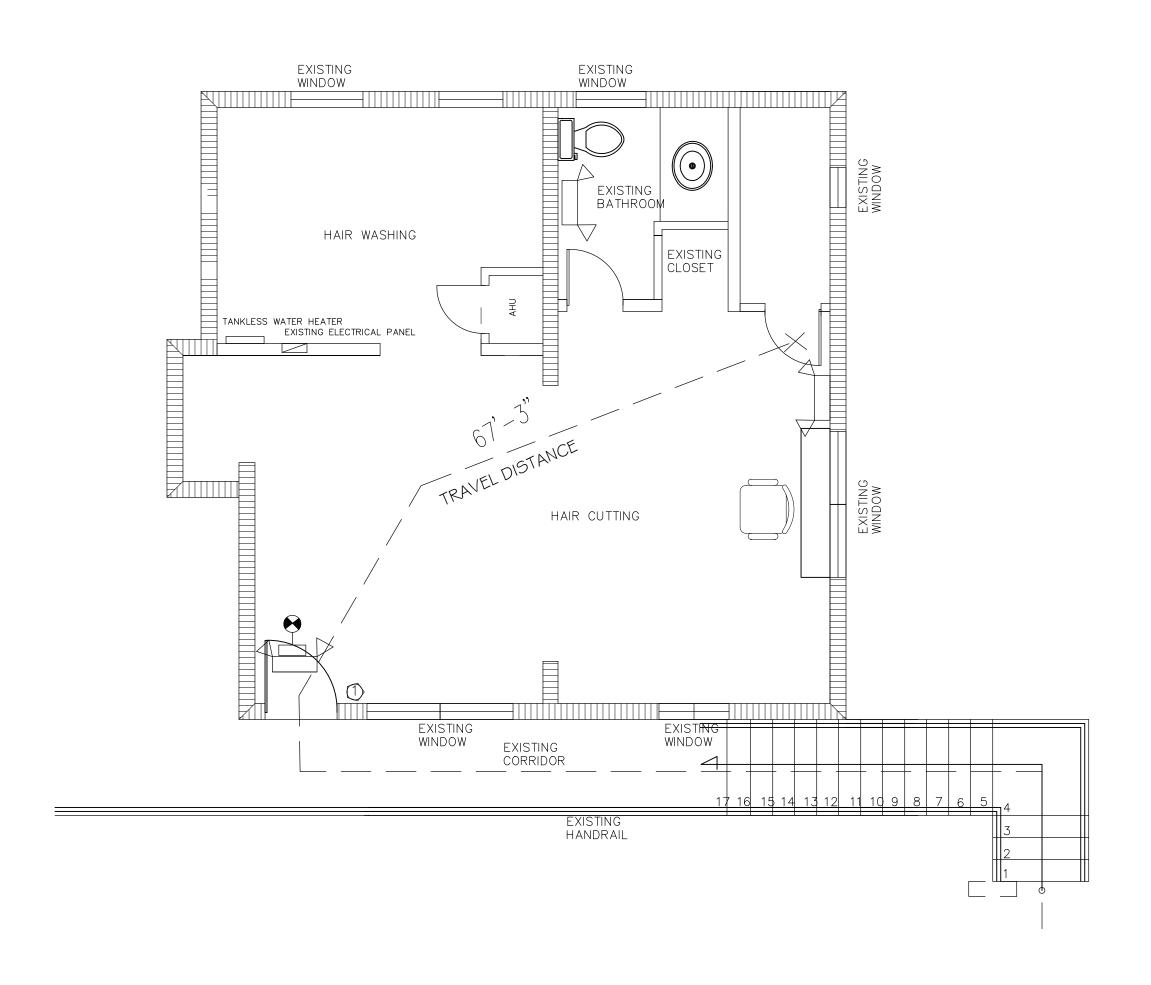

LIFE SAFETY PLAN

SCALE 1/4" = 1'

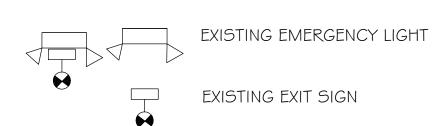

A SIGN WITH "PUSH FOR ASSISTANCE" TO BE PROVIDED AT THE STAIR ACCORDING WITH ADA REGULATIONS 2010, SMALL BUSINESS.

In some instances, especially in older buildings, it may not be readily achievable to remove some architectural barriers. For example, a restaurant with several steps leading to its entrance may determine that it cannot afford to install a ramp or a lift. In this situation, the restaurant must provide its services in another way if that is readily achievable, such as providing takeout service. Businesses should train staff on these alternatives and publicize them so customers with disabilities will know of their availability and how to access them.

When barrier removal is not possible, alternatives such as curbside service



APPLICABLE CODES

FLORIDA BUILDING CODE 2010 AND SUPPLEMENTS
NFPA 101 (2009)
FLORIDA ACCESIBILITY CODE 2010

FLORIDA ACCESIBILITY CODE 2010

CONSTRUCTION TYPE

OCCUPANC`	r. F.B.C 2010			
PROJECT DATA: FLORIDA BUILDING CODE—2010 EDITION				
304.1 Business Group B.				
	cy includes, among others, the use of a portion thereof, for office			
1004.1.1 MAXIMUM FLOOR	1004.1.1 MAXIMUM FLOOR AREA ALLOWANCES PER OCCUPANT			
OCCUPANCY	FLOOR AREA IN SQ FT. PER OCCUPANT			
Business area	602 SQFT / 100 GROSS =			
	6 OCCUPANCY MAX.			
BATHROOMS:	46 SQ. FT.			

ER OCCUPANT	CLASS / MATERIAL	FLAME SPREAD RATING	SMOKE DEVELOPED	FLAME SPREAD CLASS	OCC. NON SPRINKLERED EXITS CORRIDORS OTHER SPACES
	А	0 - 25	0 - 450	ı	■ B C C
I SQ FT. Ant	В	26 - 75	0 - 450	Ш	
)SS =	С	76 – 200	0 - 450	III	
	GYPSUM WALLBD.	10 - 15		I	EGRESS DOOR NOTES
JPANCY MAX.	DOUGLAS FIR	90		Ш	ALL DOORS IN THE MEANS OF EGRESS SHALL BE SINGLE ACTION RELEASE, NOT REQUIRE THE USE OF A KEY, TOOL,
	RED/WHITE OAK	100		III	OR SPECIAL KNOWLEDGE TO OPEN FROM THE EGRESS SIDE.
	OAK PLYWOOD	125–185		Ш	

FLAME SPREAD CHART FOR

INTERIOR WALLS & CEILING FINISH

AGENT.

MIN. INTERIOR FINISH CLASSIFICATION FBC TABLE 803 .9

NOTE: POSTING OF OCCUPANT LOAD 6 PEOPLE MAX.

POSTED SIGNS SHALL BE OF AN APPROVED

LEGIBLE PERMANENT DESIGN AND SHALL BE

MANTEINED BY THE OWNER OR AUTHORIZED

TRAVEL DIST. TO EXIT AS PER F.B.C 2007. 1016.1

OCCUPANCY
CLASSIFICATION


GROUP B

TRAVEL DIST. TO EXIT
(FT) PROPOSED

L= 43'-9"

FE FIRE EXTINGUISHER:

① FIRE EXTINGUISHER, TYPE ABC, 5 LBS CAPACITY, MOUNTED @48" AFF TO HANDLE.

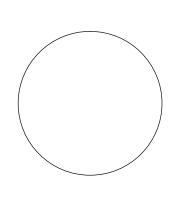

DESIGN 2004
PRODUCTIONS LLC
CA # 9844
ENGINEERING SERVICES

F.N # G02308900335
513854-0
01 01318

4471 N.W. 36 ST. SUITE # 206 MIAMI SPRINGS FLORIDA 33166

MOBIL (305)-915-7625

E-MAIL	D2004PRODU	JCTION@AOL.NET
REVIS	SION	BY:

GILBERTO GAVARRETE
Professional Engineer
Professional Engineer
51371
State of Florida
SEAL, SIGN AND DATE:

PROPOSED NEW
PERSONAL STYLING OFFICE

TO: FRESHAVELI — MANUEL SOTO
UNIT 3
20 NE 41 ST. MIAMI FL


DRAWN BY:


SCALE:

DATE:

05/-2013


SHEET 3:

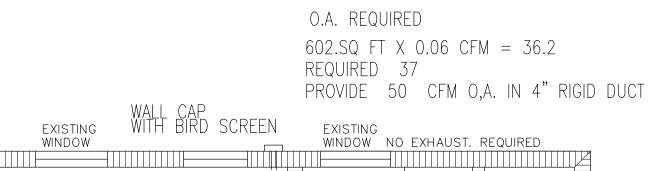

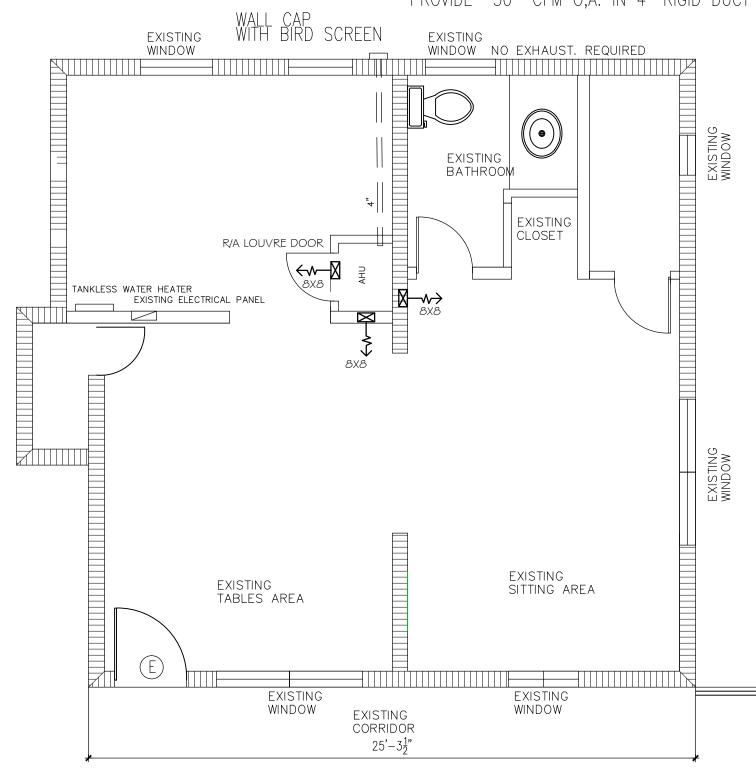

MECHANICAL PLAN

SCALE 1/4" = 1'

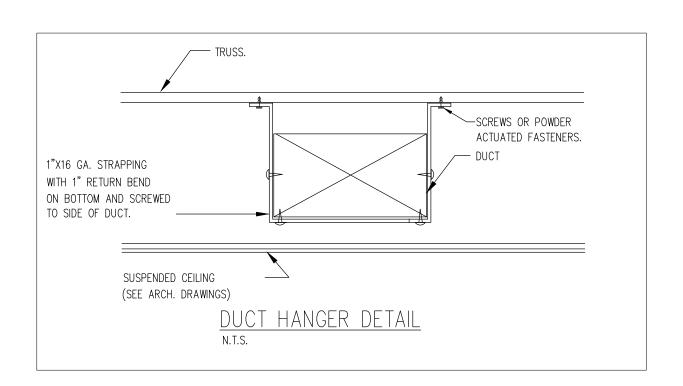

HANDRAIL

HVAC DESIGN CHART (EXISTING)

HVAC DESIGN REQUIRES	YES	NO
DUCT SMOKE DETECTOR		/
FIRE DAMPER(S)		✓
SMOKE DAMPER(S)		~
FIRE RATED ENCLOSURE		/
FIRE RATED ROOF/FLOOR		/
FIRE RATED CEILING ASSEMBLY		~
FIRE STOPPING		/
SMOKE CONTROL		/

SPECIFICATIONS. (GODMAN AR 32-1 EXISTING UNIT)


Cooling Capacity (btu) 36,000 Btu Heating Capacity (btu) 34,600 Btu EER 12.4 eer Compressor RLA 17

Voltage-HZ / Phase 208/230 60 | Phase Max Breaker Size 35 Amps

Min/Max Volts 197/253 Refrigerant Type R410 A Suction Line Size 7/8" Liquid Line Size 3/8"

Unit Dimensions 3 | 5/8" W x 3 | 5/8"L x 27 3/8 "H

Sound Level 75 DB HEATER MODEL HKR.03

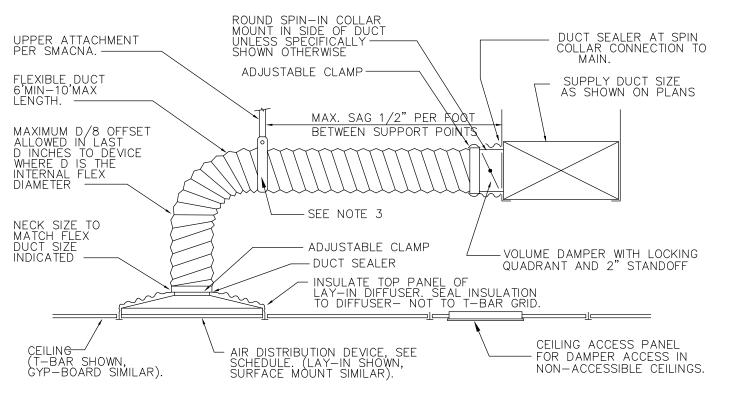


FLEXIBLE DUCT DETAIL (for new s.a)


FLEXIBLE DUCT NOTES

LESS THAN R/D = 1.0.

- 1. FLEXIBLE DUCTS SHALL BE ONE-PIECE AND SHALL NOT BE SPLICED TOGETHER.
- 2. EXTEND FLEXIBLE DUCT INSULATION TO DUCT/DIFFUSER PANEL INSULATION AND SEAL WITH MASTIC. 3. MINIMUM 1" WIDE 26 GALVANIZED STRAP HANGER WITH HEMMED EDGES PER SMACNA, FIGURE 3-10 4. FLEXIBLE AIR DUCT SHALL BE FULLY EXTENDED AND NOT COMPRESSED WITH ELBOW RADIUS NO

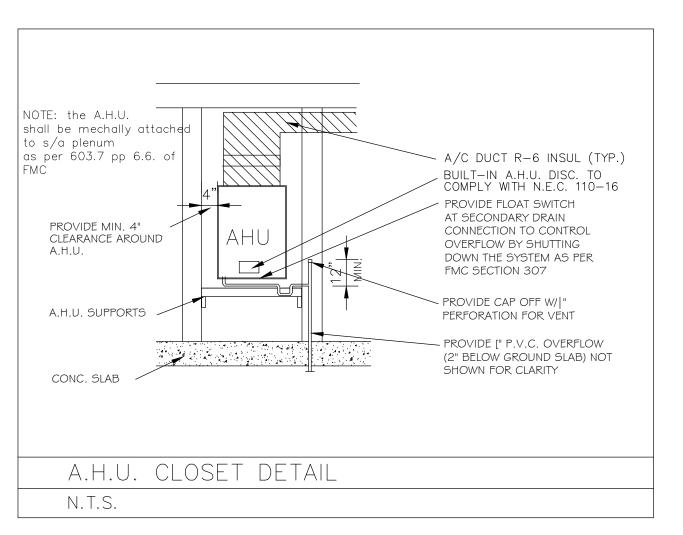

AHU UNIT MOUNTING DETAIL (EXISTING)

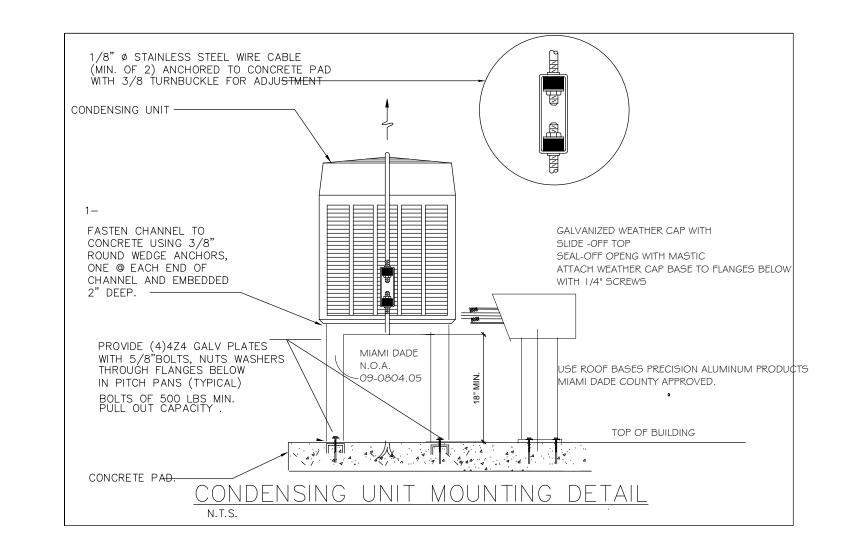

GENERAL NOTES-HVAC

1. GENERAL

- A. ALL WORK SHALL be done in accordance with the Florida Building Code and with all applicable regulations.
- B. DRAWINGS: Refer to all drawings for coordination of the HVAC work. C. ARRANGE AND PAY for all permits licenses, inspections and tests.
- Obtain the required certificates and present to owner. D. GUARANTEE: The completed installation shall be fully guaranteed against defective materials and/or improper workmanship for a minimum of one year for material and labor. Compressors shall be guaranteed for a minimun of five years.
- 2. SHOP DRAWINGS: Contractors shall submit for approval, within 30 days after signing contract, a minimum of five copies of fully descriptive literature, including but not limited to: fans, air outlets. No work shall proceed without approval of these submittals.

DESIGN PARAMETERS:

- A. Outdoor design temperature (Summer): 91^ F B. Outdoor design temperature (Winter): 46^ F C. Indoor design temperature (Summér): 75^ F DB D. Indoor design temperature (Winter): 70° F DB
- THERMOSTAT to be low voltage, one step cooling, one step heating and switching sub-base. All electrical wiring per manufacturer's recommendations.
- 5. ELECTRICAL CONTROLS AND POWER WIRING: Under electrical contract.
- 6. EQUIPMENT SPECIFIED BY manufacturer's number shall include all accessories, controls, etc., listed in the catalog as standard with the equipment. Optional or additional accessories shall be furnished as specified.


MATERIALS: REFRIGÉRANT PIPING:

a. Piping shall be type L soft drawn, copper tubing, dehydrated for refrigerant use. Sized as shown on drawings or as per manufacturer's recommendations.

b. INSULATION: refrigerant suction piping shall be insulated with 1/2 inch foamed plastic insulation, fire retardant type. All duct dimensions are clear inside dimensions. Insulation shall be installed in pipinf before assembly. No split insulation will be acceptable. Seal joints with manufacturer's approved adhesive and gray tape.

B. DUCTWORK:

- a. All supply air ductwork shall be 1-1/2" thick fiberglass ductboard, fabricated and installed as per latest edition of SMACNA "Fibrous Glass Duct Manual". (R—6 MIN). All grilles, registers, diffusers shall be aluminum construction. White baked enamel finish. All supply air outlets shall be provided with opposite blade dampers.
- b. All exhaust ductwork shall be galvanized sheet metal or aluminum duct not lighter than 26 gauge.
- c. All duct dimensions are clear inside dimensions.
- d. Flexible insulated ductwork with 1-1/2" thick fiberglass insulation with FRK vapor barrier. (R-6 MIN)
- 8. TEST AND BALANCE: Contractor shall test and balance all ventilation and air conditioning systems.
- 9. CONTROLS: Air conditioning unit shall be started and stopped thru individual thermostat. Individual thermostat shall start/stop supply fan and activate cooling/heating system as selected.
- All EXHAUST DUCTS shall be constructed of sheet metal, terminate outside the building, and be equipped with a backdraft damper.— (No T—Fin allowed)
- Ducts from "toilet rooms," shall discharge to the outside of the building, shall be terminated not less than 6 inches above the finished roof surface, and shall be screened with a corrosion resistant material having a mesh size not larger than 1/2 inch.— (Provide goose neck or rain cap on roof terminations)
- Clothes dryer exhaust duct shall "NOT" be screened,
- Clothes dryers exhaust ducts (or vents) shall comply with manufacturer's installation instructions, be constructed of a minimum 30 gauge metal pipe, having smooth interior surface with joints running in the direction of the air flow. Duct joints shall not be assembled with sheet metal screws or other fasteners which would extend into the duct.

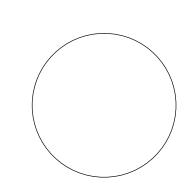

DESIGN 2004 PRODUCTIONS LLC CA # 9844 ENGINEERING SERVICES

513854-0 01 01318 4471 N.W. 36 ST. SUITE # 206

MIAMI SPRINGS

FLORIDA 33166

F.N # G02308900335


MOBIL (305)-915-7625


E-MAIL D2004PRODU	JCTION@AOL.NE
REVISION	BY:
09/05/12	

	PROPOSED NEW PERSONAL STYLING OFFICE TO: FRESHAVELI — MANUEL SOTO UNIT 3 20 NE 41 ST. MIAMI FL
--	---

DRAWN BY:			_
SCALE:			
DATE:			
SHEET 3:			

M-1

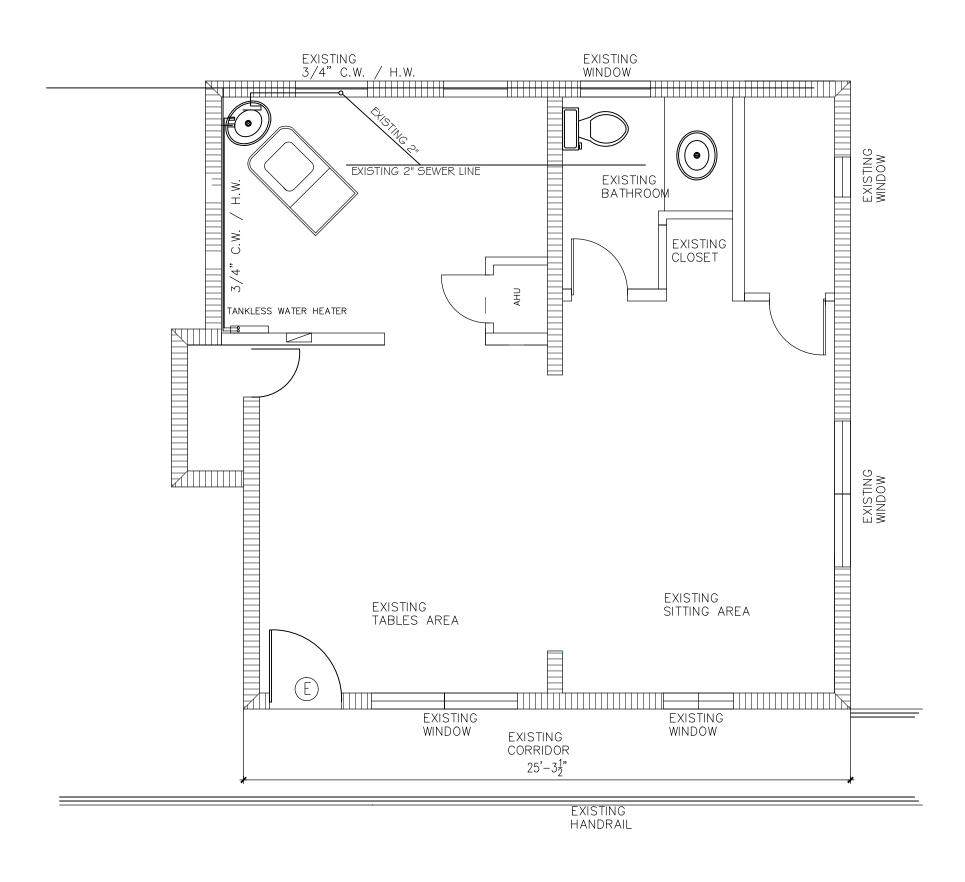

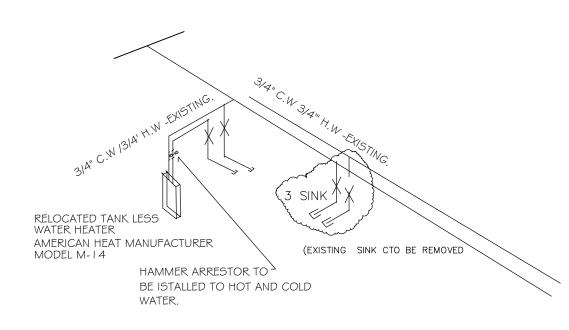

WATER RISER DIAGRAM

PLUMBING NOTES:

- ALL PLUMBING SHALL BE DONE IN ACCORDANCE WITH "PLUMBING F.B.C."
 AND ALL OTHER PERTAINING CODES AND ORDINANCES HAVING JURISDICTION.
 PLOUBING CONTRACTOR SHALL PAY ALL FEES, INSPECTIONS AND CONNECTION CHARGES
- 3. PLUMBING CONTRACTOR SHALL FURNISH AND INSTALL AIR CONDITIONING CONDENSATE DRAIN AND TRAP. SEE AIR CONDITIONING PLANS FOR LOCATION OF UNITS AND

- DRAINS.

 4. PLUMBING CONTRACTOR SHALL VERIFY ALL SPACE CONDITIONS AND DIMENSIONS AT JOB SITE PRIOR TO FABRICATION AND INSTALLATION OF MATERIALS AND EQUIPMENT.

 5. COORDINATE WORK WITH OTHER TRADES.

 6. SUBMIT SHOP DRAWINGS TO ENGINEER FOR APPROVAL OF ALL EQUIPMENT, MATERIALS AND LAYOUTS PRIOR TO INSTALLATION.

 7. FURNISH AND INSTALL BATHROOM FIXTURES AS SPECIFIED (BY ENGINEER).

 8. PLUMBING CONTRACTOR SHALL GUARANTEE ALL WORK FREE OF DEFECTS IN MATERIAL AND WORKMANSHIP FOR A PERIOD OF ONE YEAR FROM DATE OF ACCEPTANCE.

 9. EACH BATHROOM GROUP SHALL BE PROVIDED WITH AIR CHAMBERS AS PER FLORIDA BUILDING CODE
- RIDA BUILDING CODE.

 10. PROVIDE SHUT-OFF VALVE FOR EACH FIXTURE.

 11. WHEREVER DISSIMILAR METALS ARE TO BE JOINED, A DI- ELECTRIC FITTING SHALL BE PROVIDED TO CONNECT BOTH TYPES OF PIPES.
- BE PROVIDED TO CONNECT BOTH TYPES OF PIPES.

 12. PIPES.

 A. COLD WATER PIPING DOWNSTREAM OF WATER METER SHALL BE TYPE "L" COPPER BELOW GROUND AND TYPE "M" COPPER ABOVE GROUND.

 B. SANITARY WASTE AND VENT 4" AND SMALLER SHALL BE PVC SOIL PIPE.

 C. CONDENSATE DRAIN PIPE SHALL BE SCHEDULE 40, PVC PIPE AND FITTINGS.

 D. STORM LINES SHALL BE SAME AS FOR SANITARY SYSTEM.

 13. THERE SHALL BE NO JOINTS IN WATER LINES BELOW SLAB.

 14. PROVIDE ANTI—SCALD DIVERTORS @ ALL SHOWERS AND TUBS.

THE MAXIMUN WATER CONSUPTION FLOW RATES AS PER MIAMI DADE ORDINANCE 08-14 THE MAXIMUN WATER CONSUPTION FLOW RATES PLUMBING FIXTURE

PLUMBING FIXTURE OR FIXTURE FITTING


LAVATORY FAUCET SHOWER HEAD SINK FAUCET WATER CLOSET

1.0. GPM AT 60 PSI 1.5 GPM AT 80 PSI 1.0. GPM AT 60 PSI


OR FIXTURE FITTING

1.28 GALLONS PER FLUSHING CYCLE


FIXTURE UNITS						
FIXTURE	#	COLD WATER	HOT WATER	SANITARY	F.U.	
HAND SINK	1	3/4"	3/4"	2"	2	
MOP SINK	1	1/2"	1/2"	2"	2	

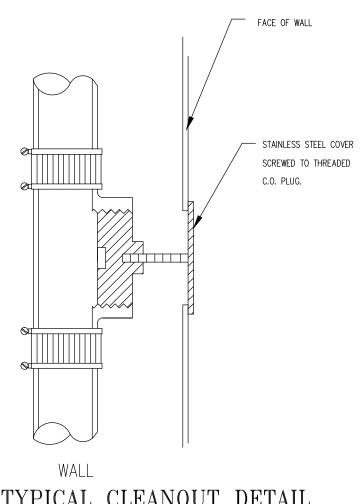

TYPICAL CLEANOUT DETAIL

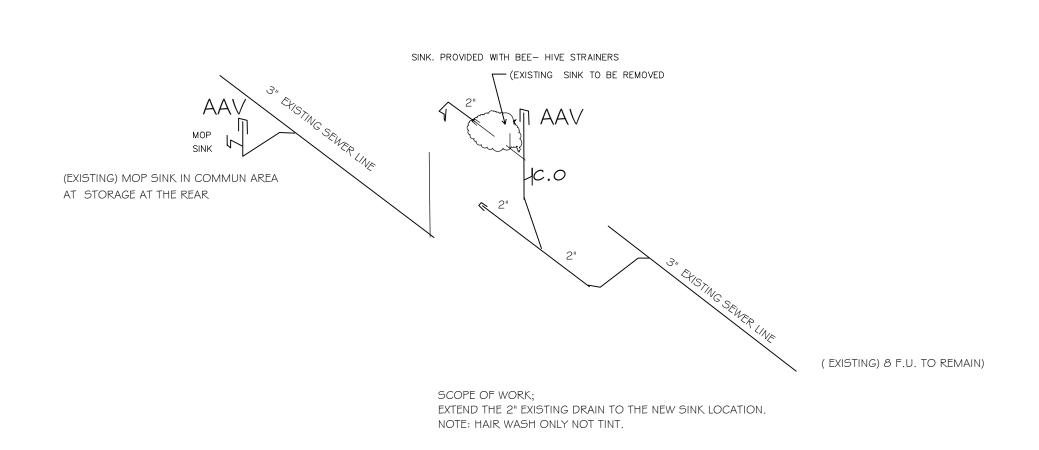

SEWER RISER DIAGRAM

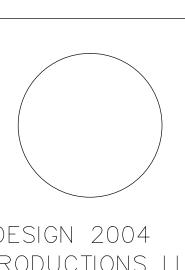

DESIGN 2004 PRODUCTIONS LLC CA # 9844 ENGINEERING SERVICES

F.N # G02308900335 513854-0 01 01318

4471 N.W. 36 ST. SUITE # 206 MIAMI SPRINGS FLORIDA 33166

PH (305)-915-7625 FAX (305)-620-0014

E-MAIL	D2004PRODU	JCTION@AOL.NET
REVI	SION	BY:
	<u> </u>	

GILBERTO GAVARRETE Professional Engineer	Professional Engineer # 51371 State of Florida	SEAL, SIGN AND DATE:	

PROPOSED NEW	PERSONAL STYLING OFFICE	TO: FRESHAVELI - MANUEL SOTO	UNIT 3	20 NE 41 ST. MIAMI FL	
--------------	-------------------------	------------------------------	--------	-----------------------	--

DRAWN	BY:	
SCALE:		
DATE:		
SHEET	3:	

ARQBUILT INC. CGC 1516312

986 | NW 2^{ND} CT. Plantation Fl. 33324 Phone (305)8 | 5 | 94 | argbuilt@qmail.com

July 10, 2013

REF. Commercial project located at: 20 NE 41 ST UNIT 3. Miami Fl.

Exterior New Wheelchair Lift Installation

Dear MANUEL SOTO

We hereby propose to furnish the following work:

- WHELCHAIR LIFT: Commercial 2 stops custom size to meet ADA, Cap type selection handing front and rear with auto door operator, hall call stations: flush mounted in frame, power supply of 110 VAC 60 hz. All electrical connections required.
- **PIT, FOUNDATION AND ENCLOSURE:** Exterior enclosure, include foundation, required pit, walls with reinforcing where required and roof. Finish to match exterior building appearance.
- PERMIT AND INSPECTIOS REQUIRED BY CITY AND DIFFERENT ENTITIES.

NOTE: OWNER TO PROVIDE APPROVED SET OF PLANS WITH LOCATION AND SPECIFICATIONS OF JOB

TOTAL: \$41,697.00

Payments:

50% when signed the contract

20% with progress at job

10% due completion and permit is closed

Contractor shall diligently pursue and substantially complete all work to be performed under this proposal within a reasonable period of time, taking into consideration delays that are beyond the control of the Contractor, including, but not limited to, weather conditions, delays in selection or delivery of materials and change orders requested by Client. The above price, specification and condition are satisfactory and are hereby accepted. You are authorized to perform the work as specified under this proposal. Payment shall be made as outlined above. In the event that litigation arises, here under the prevailing party, shall be entitled to reasonable attorney's fees and costs through final appeal. Venue shall lie exclusively in Miami Dade County, Florida and the parties shall waive trial by jury.

Note-This proposal may be withdrawn by us if not accepted within 15 days.

Accepted By (Owner):	Date:	
	By ARQBUILT INC:	

South Shore Elevator Service Corp

3951 NW1st Street Miami, FL, 33126 Ph(786)205-6451~~Fax(305)603-9268 Web Address: www.sshoreelevator.com Email:sshoreelevator@yahoo.com

To: Amelia Granados 20 NE 41 St #3 Miami, FL, 33137

From: South Shore Elevator Service. Roger Villarnovo Ph(305)878-9102

Fax(305)603-9268

Reference: Proposal for New Wheelchair Lift Installation.

Proposal Number: 14505

SCOPE OF WORK:

New Wheelchair Lift Installation

South Shore Elevator Service Corp would furnish you with one wheelchair lift with the following specifications:

- 1. Type: Inclinator not to exceed 144" vertical travel with clear plexiglass inserts
- 2. Project Type: Commercial
- 3. Power Supply: 110 VAC 60 hz
- 4. Number of Stops: 2-Stop
- 5. Outdoor Options: Yes
- 6. Pit Required: Yes (By others)
- 7. Floor to Floor Travel: Approx. 138"
- 8. Ramp: N/A
- 9. Underpan Sensor: Not Required
- 10. Cab Type Selection and Handing: Front and Rear
- 11. Landing Door Locations/Swing: Lower Level: RH; Upper Level RH
- 12. Cab Size: Custom Size to meet ADA
- 13. Car Station: Keyless

- 14. Lower Landing Entrance: Standard 80" High Door with plexiglass insert in door and WR500 locks with Auto Door Operator (commander)
- 15. Intermediate Landing1 Options: N/A
- 16. Intermediate Landing 2 Options: N/A
- 17. Upper Landing Entrance Options: 42" x 80" Pro Swing Door with Prolocks and Auto Door Operator (commander)
- 18. Locks: N/A
- 19. Hall Call Stations:
 - a. Bottom Landing: Flush mounted in frame
 - b. Upper Landing: Flush mounted in frame
- 20. Enclosure Extension above top landing: 83" enclosure extension above top landing
- 21. Enclosure Roof: Yes
- 22. Light Screen: N/A
- 23. Telephone: None
- 24. Elevator Contractor to use Stainless Steel 304 for anchoring where practicable.
- 25. Color: Standard Beige
- 26. Touch up Paint: No
- 27. Misc: N/A

PRICE: \$31,500.00 (Thirty one Thousand Five Hundred)

South Shore Procedure Payment and Scheduling:

We will not perform work, order material until down payment is received of 75% for all jobs over \$5,000.00 with 25% balance to be paid in full at job completion & 100% down-payment for all jobs under \$5,000.00-No exceptions. South Shore Elevator Service Corp may not release the elevator for public use until final payment and or any past due amounts have been received in full. We will not start on the job until the customer has completed all work by others and any code requirements the building would have to adhere to. We will not be responsible for any building fines by city for late inspections due to past due inspections.

This proposal #14505 when accepted by you below and approved by our authorized representative, constitute the entire contract between us.

CUSTOMER Approved by an Authorized Representative	South Shore Elevator Service Corp Approved by an Authorized Representative
Date:	Date:
Signed:	Signed:
Print Name:	Print Name:
Title:	Title:
Name of Company:	

Message: Thank you for your business