


CITY OF MIAMI BEACH

Mayor: Dan Gelber

Commissioner: Micky Steinberg Commissioner: Mark Samuelian Commissioner: Michael Gongora Commissioner: Kristen Rosen Gonzalez Commissioner: Ricky Arriola
Commissioner: John Elizabeth Aleman

City Manager: Jimmy L Morales City Attorney: Raul J Aguila

Director of C.I.P. Office: David Martinez, P.E., LEED AP

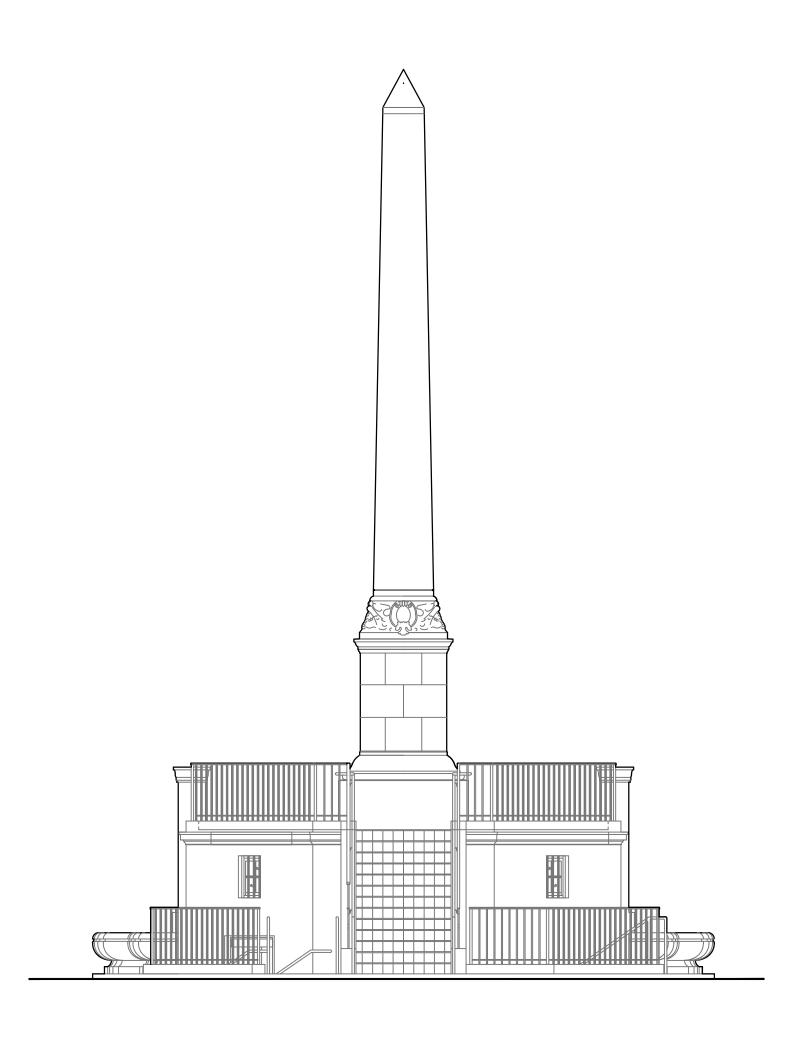


28th Street Obelisk and Pump Station Restoration Project

300 West 28th Street Miami Beach, Florida 33139

> Permit Set Date: 01/22/2018

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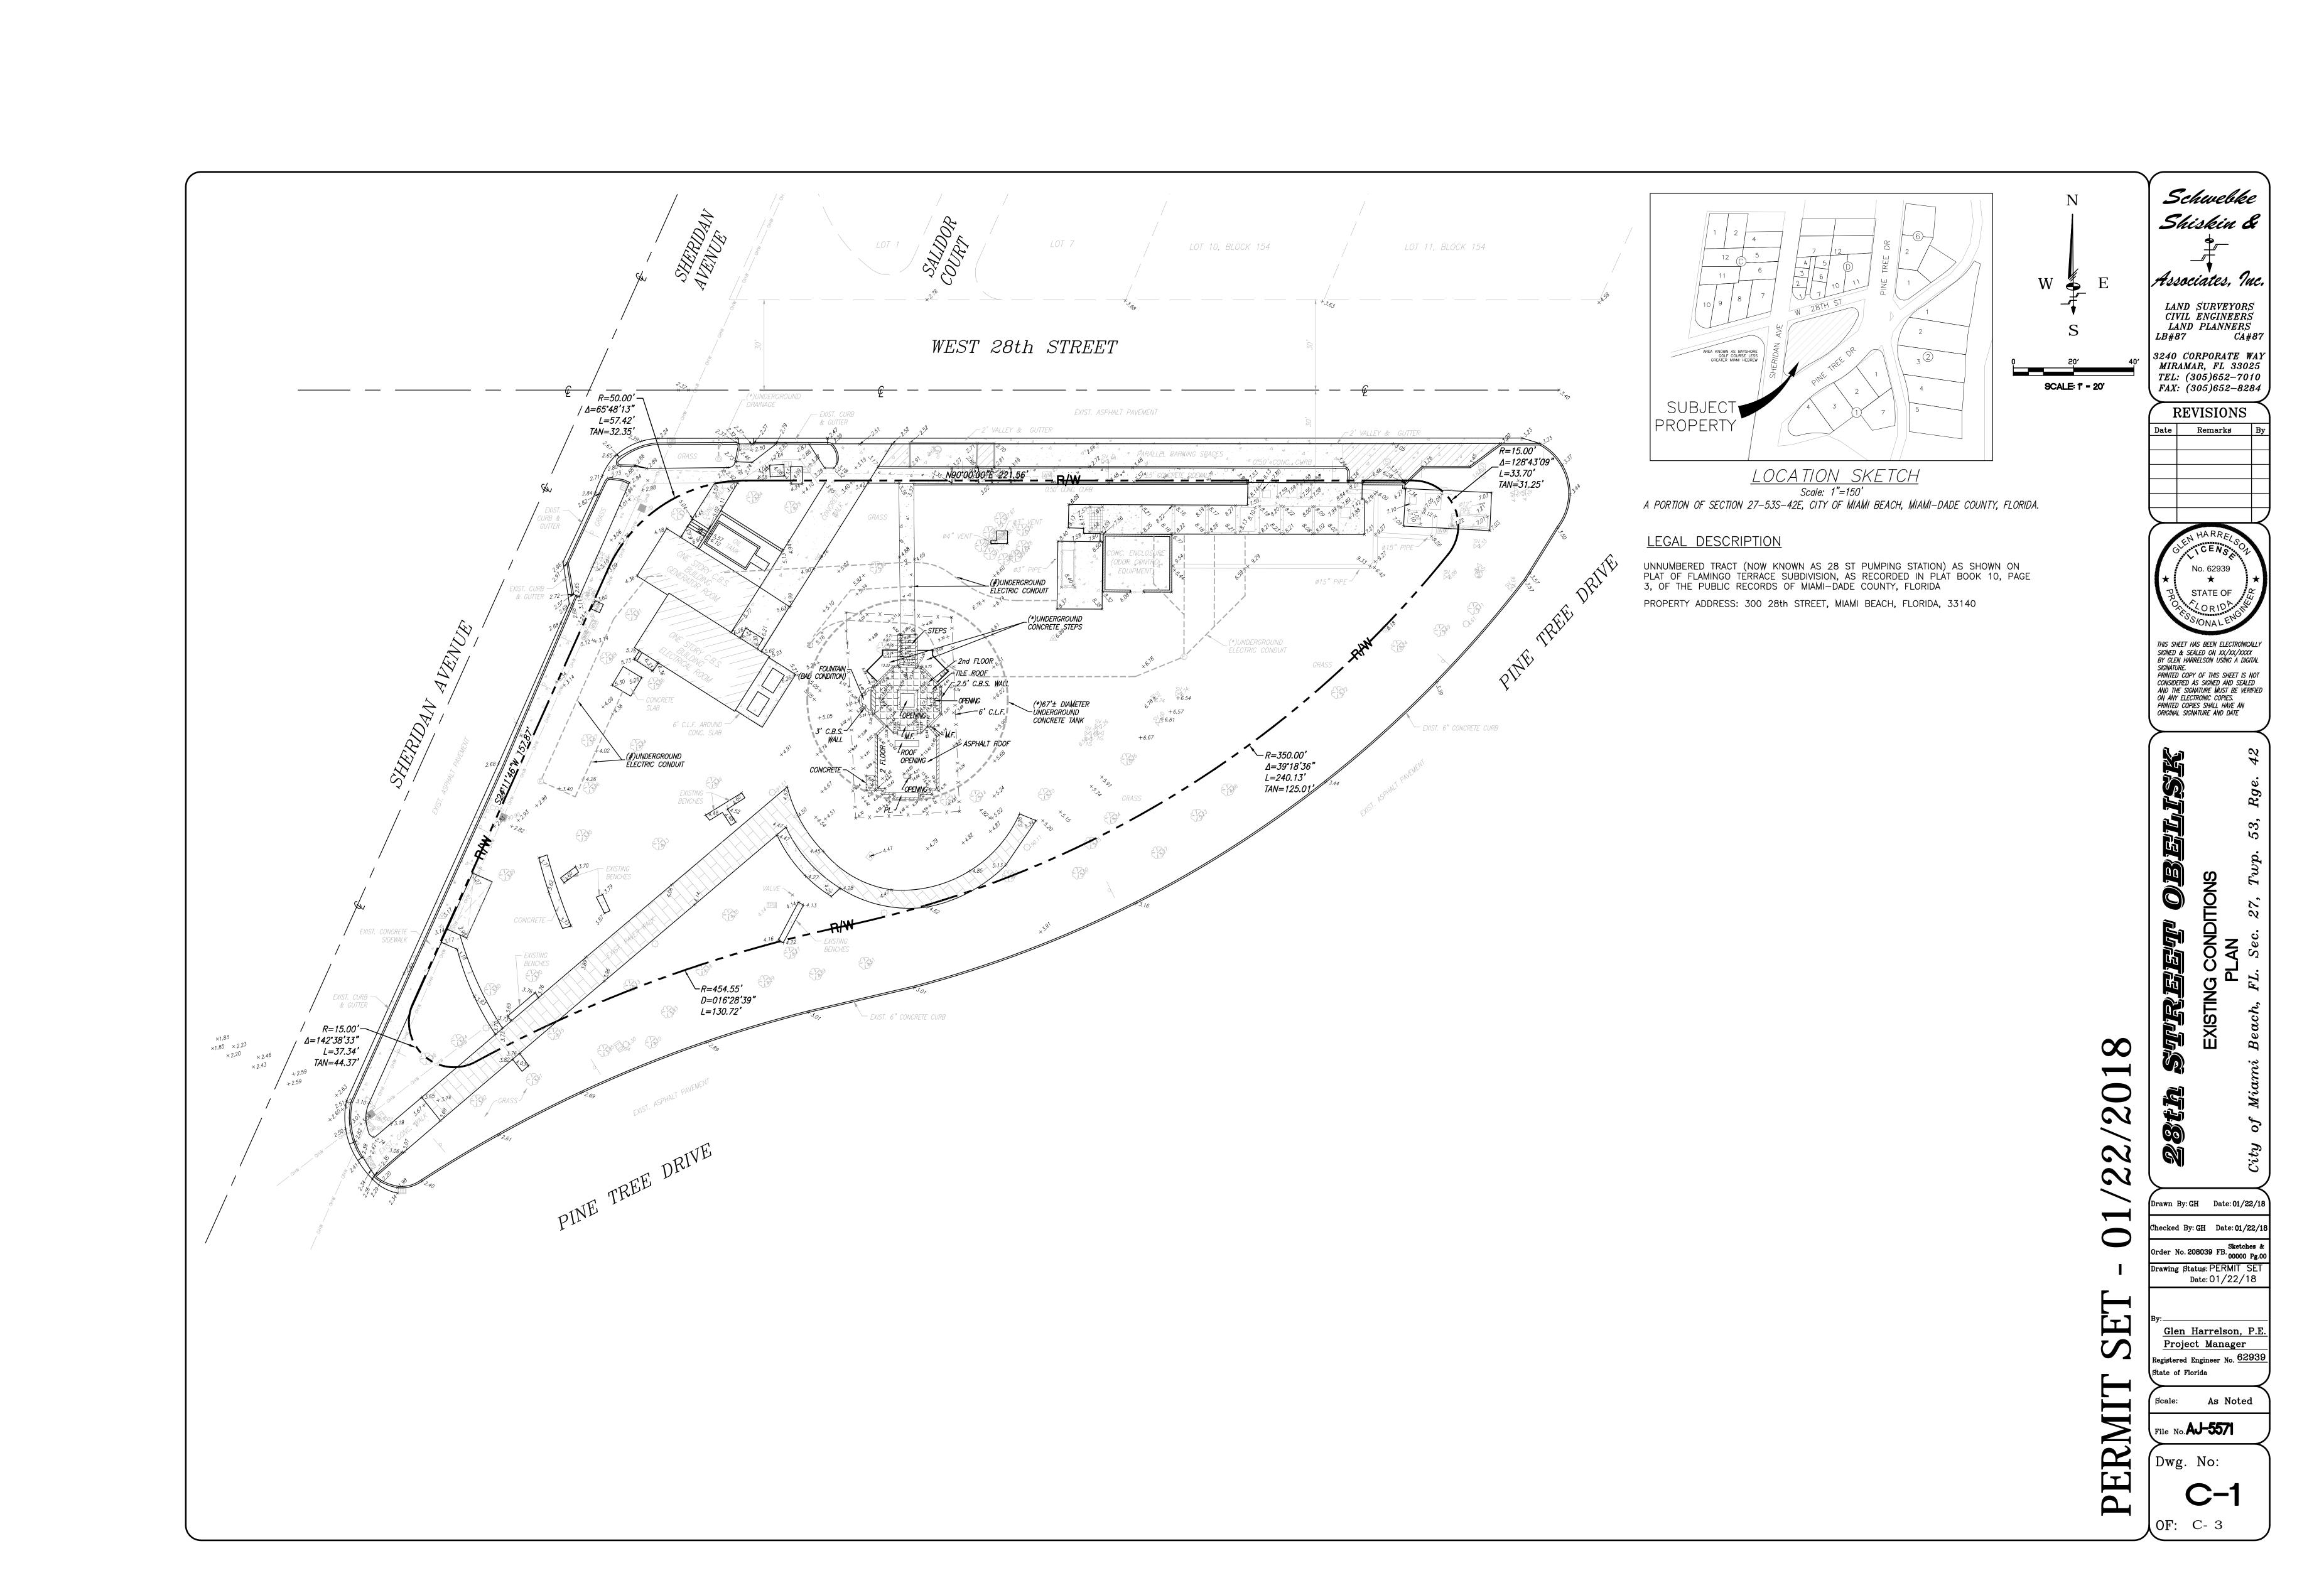


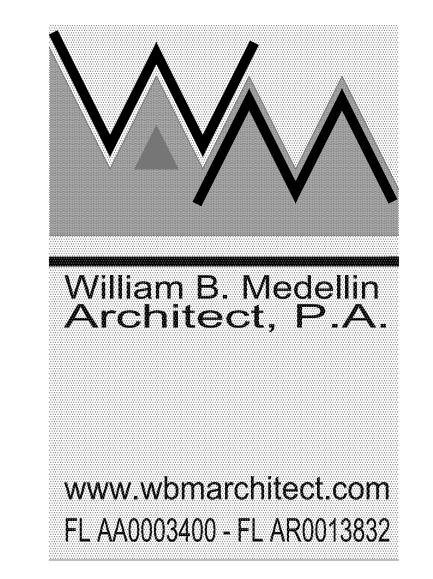



STRUCTURAL ENGINEER INGELMO ASSOCIATES P.A. 250 Catalonia Avenue,, Suite 301 Coral Gables, FI 33134 305-461-6009

MEP ENGINEER

MAQUEIRA ENGINEERING CONSULTANTS, INC. 7220 S.W. 39th Terrace Miami,, FL 33155 305-444-8210



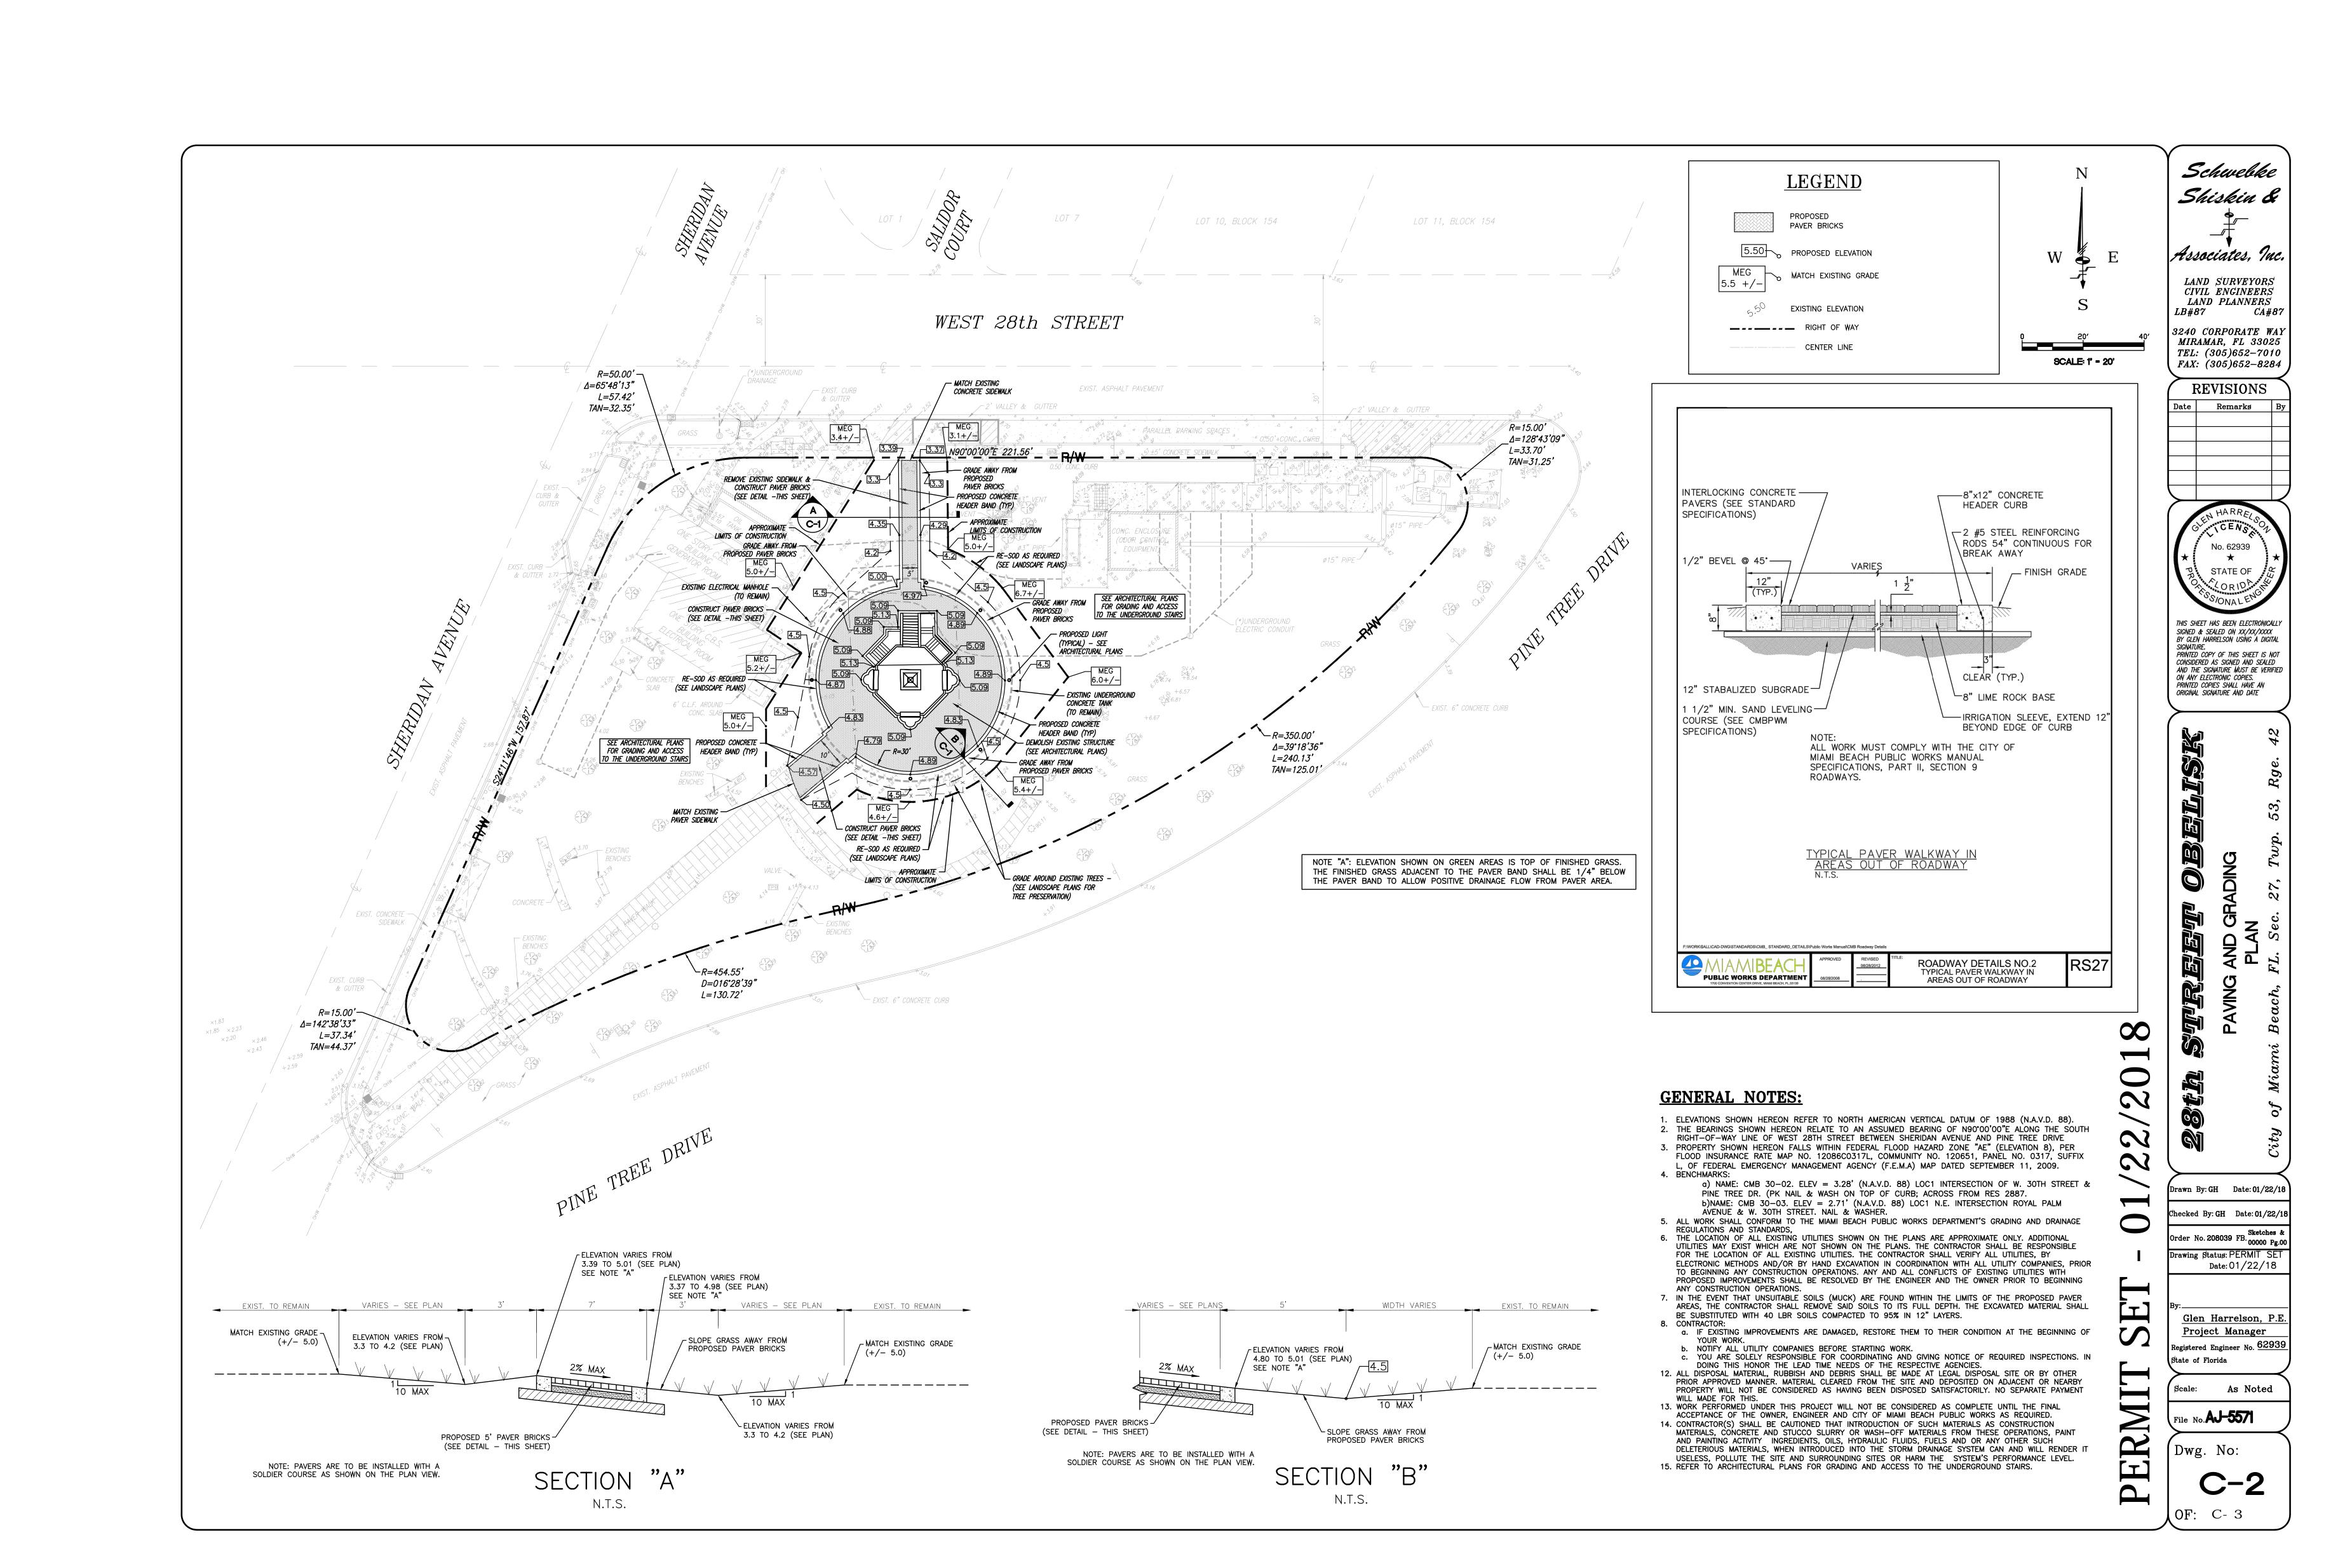

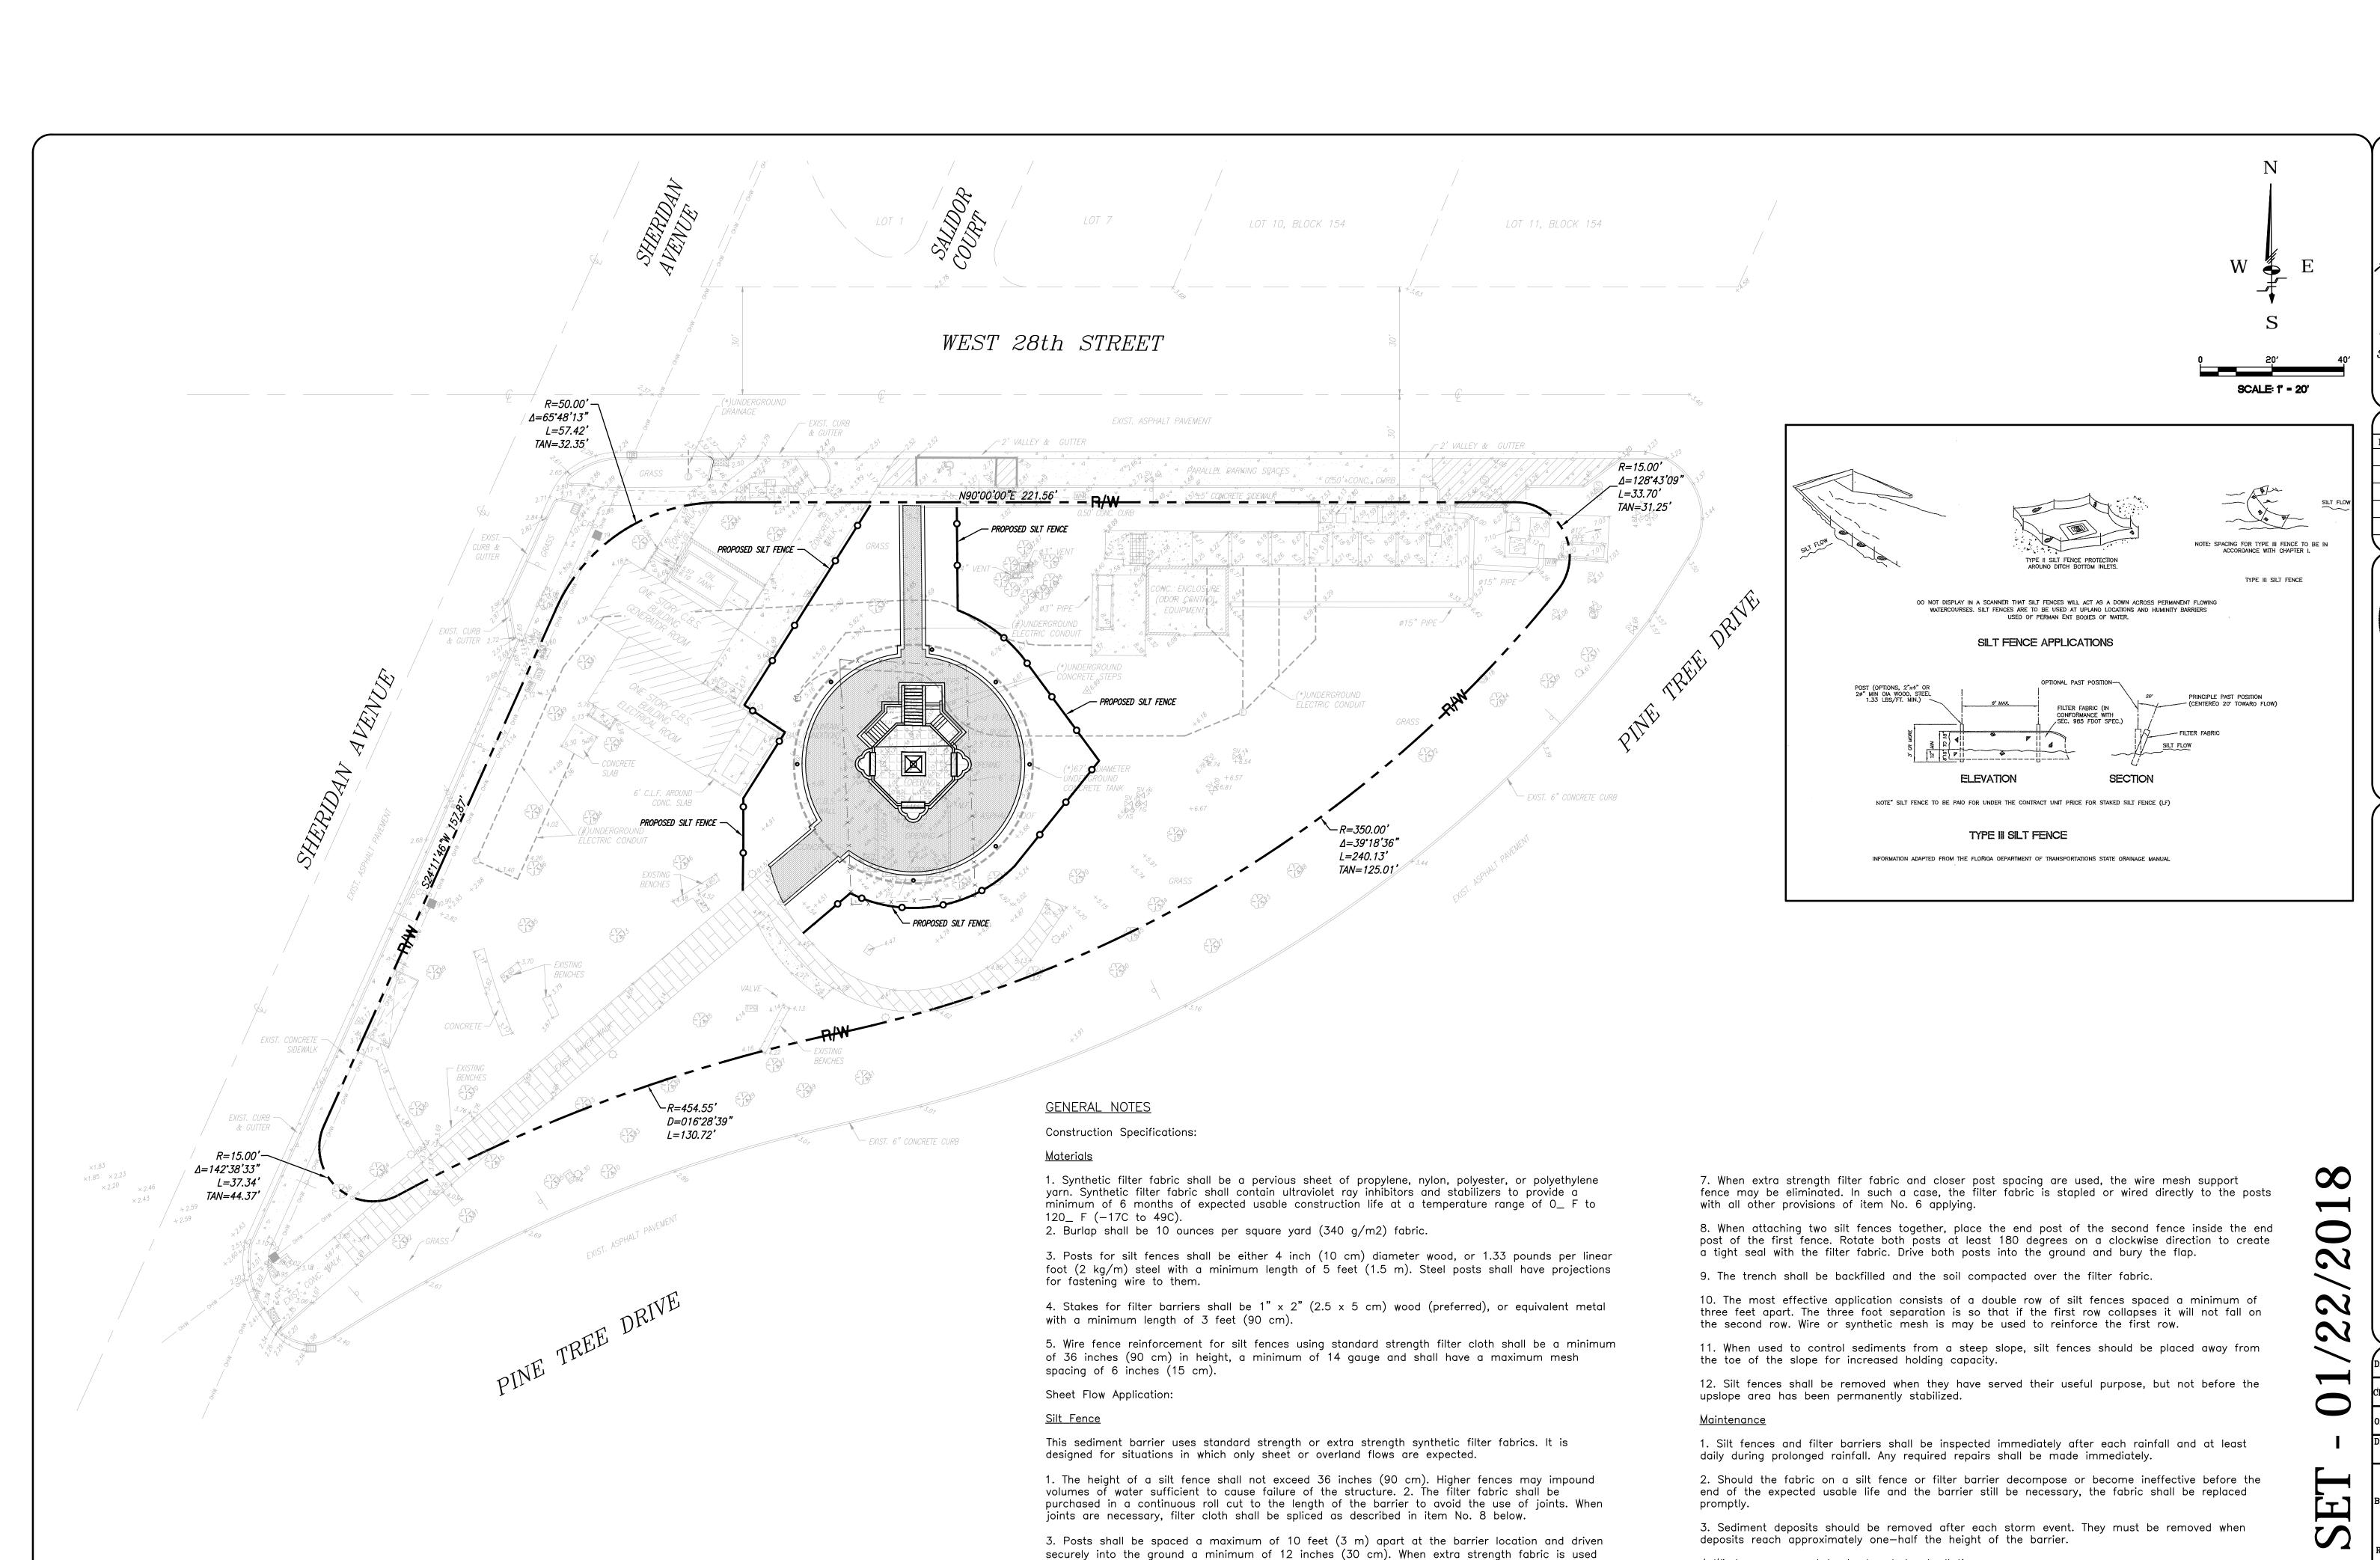

without the wire support fence, post spacing shall not exceed 6 feet (1.8 m).

along the line of posts and upslope from the barrier.

and shall not extend more than 36 inches

(90 cm) above the original ground surface.

inches (90 cm) above the original ground surface.

4. A trench shall be excavated approximately 4 inches (10 cm) wide and 4 inches (10 cm) deep

securely to the upslope side of the posts using heavy duty wire staples at least 1 inch (25 mm) long, tie wires, or hog rings. The wire shall extend into the trench a minimum of 2 inches (5 cm)

5. When standard strength filter fabric is used, a wire mesh support fence shall be fastened

6. The standard strength filter fabric shall be stapled or wired to the fence, and 8 inches (20 cm) of the fabric shall be extended into the trench. The fabric shall not extend more than 36

LAND SURVEYORS CIVIL ENGINEERS LAND PLANNERS LB#87 CA#87

3240 CORPORATE WAY MIRAMAR, FL 33025 TEL: (305)652-7010 FAX: (305)652-8284

REVISIONS

No. 62939

THIS SHEET HAS BEEN ELECTRONICALLY SIGNED & SEALED ON XX/XX/XXXX BY GLEN HARRELSON USING A DIGITAL SIGNATURE. PRINTED COPY OF THIS SHEET IS NOT CONSIDERED AS SIGNED AND SEALED
AND THE SIGNED MUST BE VERIFIED ON ANY ELECTRONIC COPIES. PRINTED COPIES SHALL HAVE AN ORIGINAL SIGNATURE AND DATE

rawn By: GH Date: 01/22/18

Drawing Status: PERMIT SET

Date: 01/22/18

Glen Harrelson, P.E Project Manager Registered Engineer No. 62939 State of Florida

As Noted Scale:

4 Wind screens must be kept orderly at all times

6. Protect all existing trees during construction

5. Construction entrances must be kept in working condition

7. Maintain all BMP's at existing inlets until the completion of construction.

File No.**AJ-5571**

Dwg. No:

PERMI

GENERAL NOTES

COPIES TO THE OWNER.

THE CITY OF MIAMI BEACH TECHNICAL SPECIFICATIONS DIVISION—1 GENERAL REQUIREMENTS IS HEREBY MADE A PART OF THESE DOCUMENTS TO THE SAME EXTENT AS IF BOUND IN THEIR ENTIRETY HEREIN.

THE ARCHITECT SHALL NOT BE RESPONSIBLE FOR CONTRACTOR'S MEANS, METHODS, OR HAVE CONTROL OR CHARGE OVER THE ACTS AND OMISSIONS OF THE CONTRACTOR, SUBCONTRACTORS, OR ANY OF THE AGENTS OR EMPLOYEES,, OR ANY OTHER PERSONS PERFORMING ANY OF THE WORK.

THE CONTENTS OF THESE GENERAL NOTES SHALL NOT DETRACT ANY REQUIREMENTS FROM THE DRAWINGS AND SPECIFICATIONS.

THE STRUCTURAL DRAWINGS ARE SUPPLEMENTARY TO THE ARCHITECTURAL DRAWINGS. SHOULD THERE BE A DISCREPANCY BETWEEN THE ARCHITECTURAL AND ENGINEERING DRAWINGS, SUCH A DISCREPANCY IS TO BE BROUGHT TO THE ATTENTION OF THE ARCHITECT PRIOR TO INSTALLATION OF SAID WORK. ANY WORK INSTALLED IN CONFLICT WITH THE ARCHITECTURAL OR ENGINEERING DRAWINGS SHALL BE CORRCTED BY THE CONTRACTOR AT HIS SOLE EXPENSE.

THE CONTRACTOR SHALL BE RESPONSIBLE FOR VERIFICATION AND COORDINATION WITH OTHER CONTRACTORS AND THEIR WORK TO ENSURE COMPLIANCE WITH THE CONTACT DOCUMENTS. CONTRACTOR SHALL VERIFY SIZES AND LOCATIONS OF THE EXISTING STRUCTURE AND ALL OBSTRUCTIONS, UTILITY LINES, POLES, STREET LIGHTS, SIGNS, BRANCHES AND TREES THAT NEED TO BE TEMPORARILY REMOVED TO FACILITATE RELOCATION OF THE STRUCTURE. THE CONTRACTOR SHALL COORDINATE TEMPORARY RELOCATION OF ALL UTILITIES WITH THE UTILITY SUPPLIER AND ARRANGE FOR THEIR REINSTALLATION IMMEDIATELY AFTER

THE CONTRACTOR SHALL VERIFY ALL DIMENSIONS BY TAKING FIELD MEASUREMENTS AT THE BUILDING SITE AND SHALL BE RESPONSIBLE FOR THEIR CORRECTNESS ANY DISCREPANCIES SHALL BE REFERRED TO THE ARCHITECT FOR ADJUSTEMENT PRIOR TO ANY WORK BEING PERFORMED.

DRAWINGS ARE NOT TO BE SCALED. DIMENSIONS TO BE FOLLOWED.

ANY CHANGES, REVISIONS, ALTERATIONS, MODIFICATIONS, DEVIATIONS, ETC. THAT ARE REQUIRED ON THESE PLANS SHALL BE REQUESTED IN WRITING BY THE CONTRACTOR OR OWNER. ANY MODIFICATIONS NOT MADE BY WILLIAM B. MEDELLIN ARCHITECT P[.A. WILL RELEASE WILLIAM B. MEDELLIN ARCHITECT P.A.FROM ANY AND ALL CLAIMS AGAINST WILLIAM B. MEDELLIN ARCHITECT P.A. ALL CODES HAVING JURISDICTION SHALL BE OBSERVED STRICTLY IN THE CONSTRUCTION OF THE PROJECT, INCLUDING ALL APPLICABLE STATE, COUNTY, CITY, ZONING, ELECTRICAL, MECHANICAL, PLUMBING, LIFE SAFETY AND FIRE CODES. CONTRACTOR SHALL VERIFY ALL CODE REQUIREMENTS AND NOTIFY THE ARCHITECT IMMEDIATELY IN WRITING OF ANY CONFLICTS AS THEY EXIST.

CONSTRUCTION SHALL FOLLOW "FLORIDA BUILDING CODE" 2014 EDITION AS ADOPTED BY THE CITY OF MIAMI — DADE COUNTY, FLORIDA.

CONTRACTOR SHALL BE RESPONSIBLE FOR OBTAINING AND PAYING THE COSTS OF ALL REQUIRED BUILDING PERMITS, IMPACT FEES, AND TRADE PERMITS THE CONTRACTOR SHALL OBTAIN ALL REQUIRED INSURANCE CERTIFICATES FROM HIS SUBCONTRACTORS, MAINTAIN THEM UP TO DATE, AND DELIVER

EXCEPT FOR LONGER PERIODS OF GUARANTEE AS MAY BE SPECIFIED, THE CONTRACTOR SHALL GUARANTEE ALL WORKMANSHIP AND MATERIALS COVERED BY THIS CONTRCAT FOR A PERIOD OF (1) ONE YEAR FROM THE DATE OF FINAL ACCEPTANCE OF THE WORK.

IT IS THE INTENT AND PURPOSE OF THESE PLANS AND SPECIFICATIONS TO BE A COMPLETE AND TOTAL PROJECT OTHER THAN ITEMS MARKED N.I.C. (NOT IN CONTRACT)

THE CONTRACTOR SHALL MAINTAIN THE WORK SITE CLEAN AND FREE OF ALL TRASH, DEBRIS AND SHALL PROTECT ALL ADJACENT WORK FROM DAMAGE.

SITE INVESTIGATION — IT SHALL BE THE RESPONSABILITY OF THE BIDDERS TO VISIT THE SITE AND ACQUANIT THEMSELVES WITH ALL INFORMATION REGARDING THE BUILDING AND ITS EXISTING CONDITION.

EXCEPT FOR LONGER PERIODS OF EXPERIENCE AS MAY BE SPECIFIED, THE HISTORIC RESTORATION CONTRACTOR AND SUB—CONTRACTORS SHALL DEMONSTRATE PROOF OF EXTENSIVE EXPERIENCE IN HISTORIC RESTORATION AND REHABILITATION PROJECTS. SUBMIT AT LEAST FIVE (5) HISTORIC RESTORATION PROJECT REFERENCES FOR REVIEW.

SEE PROJECT SPECIFICATIONS SECTION 01100 — GENERAL REQUIREMENTS FOR ADDITIONAL PROJECT CONDITIONS AND REQUIREMENTS. **DEMOLITION NOTES**

ALL WORK SHALL BE PERFORMED IN ACCORDANCE WITH ALL APPLICABLE FEDERAL, STATE, LOCAL CODES, ORDINANCES AND OSHA REGULATIONS.

CONTRACTOR SHALL OBTAIN AND PAY ALL FEES FOR PERMITS AND INSPECTIONS AS REQUIRED BY CODE, APPLICABLE LAWS OR GOVERNING AGENCIES IN CONNECTION WITH DEMOLITION WORK, REMOVAL AND DISPOSAL OF DEBRIS,

ASBESTOS AND LEAD—BASED PAINT ABATEMENT.

PROPER DISPOSAL OF ALL DEMOLISHED WASTE MATERIALS SHALL BE BY THE GENERAL CONTRACTOR. ALL INDIVIDUAL SUB—CONTRACTORS SHALL BE RESPONSIBLE FOR PROPER DISPOSAL OF WASTE MATERIALS DUE TO THEIR RESPECTIVE ACTIVITIES.

THE GENERAL CONTRACTOR SHALL VERIFY EXISTING CONDITIONS PRIOR TO DEMOLITION AND CONSTRUCTION.

DEMOLITION OF ITEMS TO BE REMOVED OR RELOCATED, SHALL BE DONE ON A SAFE, ORDERLY MANNER WITHOUT DAMAGE TO OTHER PARTS OF THE PREMISES.

MATERIALS AND ITEMS TO BE DEMOLISHED AND NOT DESIGNATED TO BECOME THE PROPERTY OF THE OWNER, SHALL BECOME PROPERTY OF THE CONTRACTOR AND SHALL BE REMOVED FROM THE SITE AT CONTRACTOR'S EXPENSE.

DEMOLISH, REMOVE AND/OR RELOCATE ALL EXISTING WORK AS SPECIFIED OR DIRECTED, AND AS REQUIRED BY THE CONDITIONS OF THE JOB, PLANS, AND SPECIFICATIONS, INCLUDING, BUT NOT LIMITED TO THE FOLLOWING:

ONE STORY EASTERN CONCRETE STRUCTURE ADDITION AND ALL EXISTING ELECTRICAL AND PLUMBING SYSTEMS.

STORE IN A SAFE AREA ALL HISTORIC MATERIAL DESIGNATED TO BE REMOVED. ARCHITECT, MUSEUM'S CONSERVATOR AND STRUCTURAL ENGINEER WILL DETERMINE WHICH HISTORIC MATERIAL TO BE RE—USED.

SEE PROJECT SPECIFICATIONS SECTION 02410 — DEMOLITION, FOR ADDITIONAL PROJECT DEMOLITION CONDITIONS AND REQUIREMENTS.

SHOP DRAWINGS AND SUBMITTAL (NOT LIMITED)

NATURAL STONE , MARBLE - MATERIALS AND CLEANING STONE RESTORATION - MATERIALS , REPAIR, INSTALLATION AND CLEANING ARCHITECTURAL WOODWORK - MATERIALS , REPAIR AND INSTALLATION ROOFING AND FLASHING SYSTEMS PORTLAND CEMENT/STUCCO - MATERIALS , REPAIR AND INSTALLATION PAINT - MATERIALS AND APPLICATION MATERIALS AND FIXTURES - ELECTRICAL DOORS, FRAMES, DOOR TYPES SPECIFICATIONS AND INSTALLATION HARDWARE SCHÉDULE WINDOWS AND GLAZING, DETAILS AND SAMPLES HURRICANE STORM PANELS MATERIALS AND FIXTURES - HVAC, ELECTRICAL AND PLUMBING TERRACE FLASHING AND WATERPROOFING SYSTEM METAL RAIILING CONCRETE WATERPROOFING QUARRY AND CERAMIC TILE WATER FOUNTAIN

MOLDING AND ORNAMENTAL TRIM

SUBMIT SAMPLES AND COLOR CHARTS FOR FINISHES

SUBMIT 4 SETS MINIMUM FOR ARCHITECT'S APPROVAL
ALLOW TWO WEEKS TIME FOR SHOP REVIEW PROCESSING
SHOP DRAWINGS SHALL BE REVIEWED BY GENERAL CONTATCOR
AND ARCHITECT.
SHOP DRAWINGS SUBMITTAL REJECTED SHALL BE RESUBMITTED

DIVISION 1 - GENERAL REQUIREMENTS

SEE PROJECT SPECIFICATIONS SECTION 01100 — GENERAL REQUIREMENTS

SEE PROJECT SPECIFICATIONS SECTION 02410 - DEMOLITION

DIVISION 2 - SITE WORK

DIVISION 3 - CONCRETE

SEE STRUCTURAL PLANS

DIVISION 4 - MASONRY

SEE PROJECT SPECIFICATIONS SECTION 04720 — REMOVING AND REPLACING CAST STONE ARCHITECTURAL FEATURES.

SEE PROJECT SPECIFICATIONS SECTION 04900 — CLEANING METHODS FOR REMAINING MASONRY SURFACES.

SEE PROJECT SPECIFICATIONS SECTION 04902 — STONE RESTORATION.

SEE STRUCTURAL DRAWINGS

DIVISION 5 - METALS

SEE PROJECT SPECIFICATIONS SECTION 05700 - REPAIRING DAMAGED OR MISSING ORNAMENTAL METAL.

SEE PROJECT SPECIFICATIONS SECTION 09910 - EXTERIOR - INTERIOR PAINT.

SEE STRUCTURAL PLANS FOR ADDITIONAL INFORMATION.

COPPER/ BRASS CLEANING:

CLEANING OF LACQUERED AND UNFINISHED BRASS.

MATERIALS:

DO NOT MIX AMMONIA WITH CHLORIDE BLEACHES , A POISONOUS GAS WILL RESULT.
DO NOT USE BLEACH ON BIRD DROPPINGS.

2. VINEGAR

3. BAKING SODA.

4. MILD SOAP

5. CLAN POTABLE WATER.
6. CLEAN, SOFT CLOTHS.

EXECUTION:

CLEANING MUST BE PERFORMED BY CONSERVATOR WITH AT LEAST FIVE YEARS EXPERIENCE IN THE RESTORATION OF HISTORIC METALS.

BEFORE THE CLEANING PROCESS, EXAMINE THE SURFACES TO DETERMINE THE EXTENT OF WORK REQUIRED. LOOK FOR BROKEN, CRACKED, MISSING, DISTORTED OR LOOSE PARTS, COATING FAILURES SUCH AS CHIPS, LOSSES, PEELING, CRACKS, BUBBLING AND WEAR. LOOK FOR CORROSION CAUSED BY MOISTURE, SEA WATER AND SEA AIR, DEICING SALTS, ACIDS, SOILS, GYPSUM PLASTERS, MAGNESIUM OXYCHLORIDE CEMENTS, ASHES, CLINKERS AND SULPHUR COMPONENTS.

BEFORE CLEANING DETERMINE IF BRASS SURFACE IS SOLID OR PLATED.

WHEN CLEANING RETAIN THE EXISTING BRASS PATINA.

REMOVE LIGHT RUST BY HAND SCRAPPING CHIPPING AND WIRE BRUSH.

REMOVE LIGHT RUST BY HAND SCRAPPING CHIPPING AND WIRE BRUSH.

PERFORM CLEANING METHOD INDICATED IN A MANNER WHICH RESULTS IN UNIFORM COVERAGE OF ALL SURFACES AND WHICH PRODUCES AN EVEN EFFECT WITHOUT STREAKING OR DAMAGE TO ADJACENT SURFACES.

FOR UNLACQUERED SOLID BRASS:

APPLY BRASS CLEANER USING A CLEAN SOFT CLOTH. APPLY CLEANER TO A SMALL AREA AT A TIME. BUFF ALONG THE GRAIN OF METAL USING A CLEAN SIFT CLOTH.
 QUICKLY REMOVE THE CLEANER BY BUFFING THE AREA WITH A CLEAN SOFT CLOTH.
 USE A POINTED ORANGEWOOD STICK TO REMOVE EXCESSIVE CLEANER FORM CREVICES AND CORNERS.

LACOHERED SOLID BRASS

FOR LACQUERED SOLID BRASS:

1. CLEAN USING ONLY A MILD DETERGENT AND WATER. DO NOT USE AMMONIA

CLEANER.

2. RINSE THOROUGHLY WITH A CLEAN SOFT CLOTH.

PUMP TURBINES - ELECTRICAL EQUIPMENT - PIPING AND CONDUITS

CLEANING:

1. HAND SCRAPPING AND WIRE BRUSHING OF LOOSE DETERIORATED PAINT AND LIGHT RUST.

2. LOW PRESSURE SANDBLASTING OF EXCESSIVE PAINT BUILT—UP AND SUBSTANTIAL

CORROSION. AGGREGATES TO BE IRON SLAG OR SAND. DO NOT USE COPPER SLAG, HARD SHARP AGGREGATES OR HIGH PRESSURE OVER 100 P.S.I.

3. PROTECT ALL ADJACENT MATERIALS TO PREVENT DAMAGE.

4. APPLY FINISH AS PER PROJECT SPECIFICATIONS SECTION 09910 EXTERIOR —

CLEANING AND FINISHING MUST BE PERFORMED BY CONSERVATOR WITH AT LEAST FIVE YEARS EXPERIENCE IN THE RESTORATION OF HISTORIC METALS.

BEFORE THE CLEANING PROCESS, EXAMINE THE SURFACES TO DETERMINE THE EXTENT OF WORK REQUIRED. LOOK FOR BROKEN, CRACKED, MISSING, DISTORTED OR LOOSE PARTS, COATING FAILURES SUCH AS CHIPS, LOSSES, PEELING, CRACKS, BUBBLING AND WEAR. LOOK FOR CORROSION CAUSED BY MOISTURE, SEA WATER AND SEA AIR, DEICING SALTS, ACIDS, SOILS, GYPSUM PLASTERS, MAGNESIUM OXYCHLORIDE CEMENTS, ASHES, CLINKERS AND SULPHUR COMPONENTS.

CLEAN AND RE-INSTALL ANY LOOSE EQUIPMENT, COMPONENTS, PARTS, TO THEIR

ORIGINAL LOCATION.

DIVISION 6 - WOODWOOD TREATMENT - STABILIZATION - RESTORATION

SEE PROJECT SPECIFICATIONS SECTION 06401 - EXTERIOR ARCHITECTURAL

SEE STRUCTURAL DRAWINGS FOR ADDITIONAL SPECIFICATIONS **DIVISION 7 - MOISTURE PROTECTION**

SEE STRUCTURAL DRAWINGS FOR ADDITIONAL SPECIFICATIONS

SEE PROJECT SPECIFICATIONS SECTION 07140 FLUID APPLIED WATERPROOFING — FOUNTAINS
SEE PROJECT SPECIFICATIONS SECTION 07141 ELASTOMERIC WATERPROOFING — UNDER TILE
SEE PROJECT SPECIFICATIONS SECTION 07143 WATERPROOFING SYSTEM

DIVISION 8 - DOORS, WINDOWS AND GLASS

NEW WINDOWS/LOUVERS

ALL GLASS SHALL BE TEMPERED. ALL WINDOWS AND DOORS SHALL BE CAULKED AND WEATHER STRIPPED. WINDOW UNITS SHALL DISPLAY LABELS SHOWING COMPLIANCE WITH FLORIDA STATE MODEL ENERGY CODE SECTION 502.4. WINDOW AND DOOR MANUFACTURER SHALL COORDINATE WITH THE CONTRACTOR AND VERIFY OPENING SIZES PRIOR TO FABRICATION. ALL FIXED GLASS, FRAMES, DOORS, SHALL BE INSTALLED TO WITHSTAND WIND LOADS AS REQUIRED BY BUILDING CODE. WINDOWS AND LOUVERS TO HAVE CURRENT DADE COUNTY PRODUCT APPROVAL, CERTIFICATION TO BE PROVIDED TO OWNER.

ALL VENTING WINDOWS/LOUVERS ARE TO BE SUPPLIED WITH SCREENS FROM THE FACTORY.

WOOD WINDOWS/LOUVERS ARE TO BE SUPPLIED WITH FACTORY PRIMED FINISH.

WOOD WINDOW REPAIR/RESTORATION/UGPAGRDE

SEE PROJECT SPECIFICATIONS SECTION 06401 — EXTERIOR ARCHITECTURAL WOODWORK

SEE PROJECT SPECIFICATIONS SECTION 08610 — REHABILITATING WOOD WINDOWS

SEE PROJECT SPECIFICATIONS SECTION 08800 — REPLACING BROKEN GLASS IN WOOD WINDOWS

SEE PROJECT SPECIFICATIONS SECTION 09911 — EXTERIOR PAINTS — WOOD

FINISH HARDWARE

SEE PROJECT SPECIFICATIONS SECTION 08700 — CLEANING DOOR HARDWARE.
SEE PROJECT SPECIFICATIONS SECTION 08710 — REPAIRING DOOR FINISH HARDWARE.

PROVIDE ALLOWANCE FOR MATERIAL AND INSTALLATION OF NEW HARDWARE AT EXISTING WOOD DOOR.

DURING SELECTIVE THE DEMOLITION PHASE, ASSESSMENT OF THE EXISTING CONDITIONS AND DETERMINATION OF THE APPROPRIATE NEW HARDWARE WILL BE SPECIFIED.

DIVISION - 9 FINISHES

SEE PROJECT SPECIFICATIONS SECTION 09220 - PORTLAND CEMENT PLASTER/STUCCO.

CERAMIC TILE:

SEE PROJECT SPECIFICATIONS SECTION 09310 - REPLACING DAMAGED OR MISSING CERAMIC TILE.

SEE PROJECT SPECIFICATIONS SECTION 09311 - REGROUTING CERAMIC TILE.

SEE PROJECT SPECIFICATIONS SECTION 09312 - REMOVING RUST STAINS FROM CERAMIC TILE.

QUARRY TILE:
SEE PROJECT SPECIFICATIONS SECTION 09330 — QUARRY TILE.

SEE PROJECT SPECIFICATIONS SECTION 09315 - REPAIRING BROKEN TILES.

SEE PROJECT SPECIFICATIONS SECTION 09315 - REPAIRING BROKEN TILES.

PAINTING:

NOT APPLICABLE

SEE PROJECT SPECIFICATIONS SECTION 09910 - EXTERIOR PAINTS.
SEE PROJECT SPECIFICATIONS SECTION 09911 - EXTERIOR PAINTS, WOOD.

DIVISION - 10 SPECIALTIES

DIVISION - 11 EQUIPMENT

NOT APPLICABLE

DIVISION - 12 FURNISHINGS

NOT APPLICABLE

DIVISION - 13 SPECIAL CONSTRUCTION

NOT APPLICABLE

DIVISION - 14 CONVEYING SYSTEM NOT APPLICABLE

DIVISION - 15 MECHANICAL

SEE MECHANICAL AND PLUMBING DRAWINGS

LIGHT FIXTURES AND EQUIPMENT SEE ELECTRICAL DRAWINGS

ALTERNATES:

ALTERNATE #1:

NEW EAST STEPS — SEE ARCHITECTURAL, STRUCTURAL AND PLUMBING DRAWINGS. ALTERNATE #2:
NEW EAST STEPS — SEE ARCHITECTURAL, STRUCTURAL AND PLUMBING DRAWINGS.

PROJECT LOCATION

28th STREET OBELISK AND PUMP ROOM. 300 WEST 28th STREET

PROJECT DATA

MIAMI BEACH, FLORIDA 33139

SCOPE OF WORK:

DEMOLITION OF EXISTING ONE STORY, REINFORCED CONCRETE STRUCTURE.

SELECTIVE DEMOLITION OF TERRACE MASONRY AND METAL RAILING.

RESTORATION AND RE—CONFIGURATION OF EXISTING HISTORIC STAIRS RAILING.

INSTALLATION OF NEW METAL RAILING AT TERRACE.

?????? AND RESTORATION OF CONCRETE NORTH AND SOUTH STEPS.

RESTORATION OF EXISTING WOOD DOOR AND WINDOWS.

STRUCTURAL REPAIRS AND RESTORATION OF FINISHES.

RESTORATION OF EXISTING WATER FOUNTAIN AND INSTALLATION OF TWO NEW WATER FOUNTAINS TO MATCH EXISTING.

NEW PLUMBING SYSTEM TO SERVICE WATER FOUNTAINS.

NEW ELECTRICAL SYSTEM AND EXTERIOR/INTERIOR LIGHTING.

NEW MECHANICAL VENTILATION SYSTEM.

APPLICABLE CODES AND STANDARDS

FLORIDA BUILDING CODE 2014 EDITION.

FLORIDA BUILDING CODE EXISTING 2014 EDITION.


FLORIDA FIRE PREVENTION CODE / NFPA 101 LIFE SAFETY CODE 2014 EDITION.

FLORIDA ACCESSIBILITY CODE FOR BUILDING CONSTRUCTION 2012 EDITION.

NFPA 241 STANDARD FOR SAFEGUARDING CONSTRUCTION, ALTERATION AND DEMOLITION OPERATIONS 2013 EDITION.

NFPA 70 NATIONAL ELECTRIC CODE 2017.

THE SECRETARY OF THE INTERIOR'S STANDARDS FOR THE TREATMENT OF HISTORIC PROPERTIES — PRESERVATION, REHABILITATION, RESTORATION AND RECONSTRUCTION.

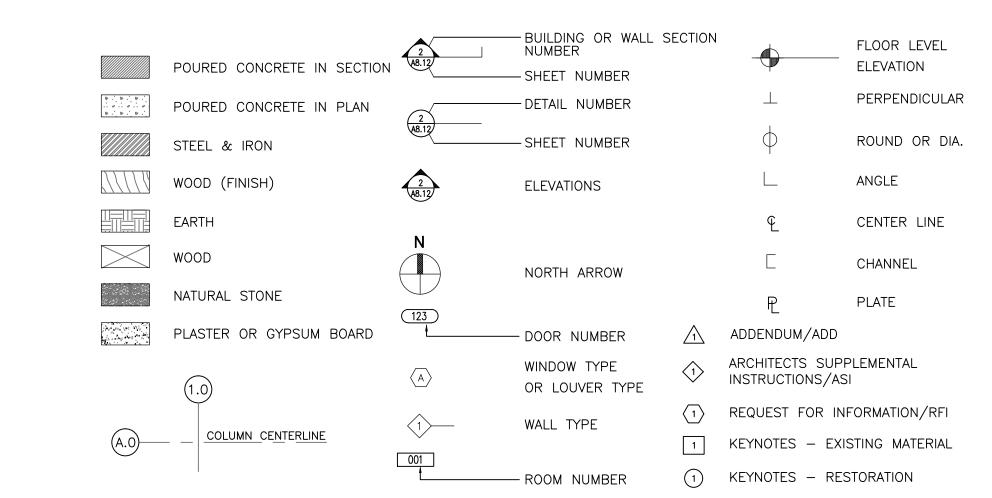

PROJECT INFORMATION

3 STANDARD SYMBOLS


AFF Above Finished Floor ADJ Adiacent Down A/C Air Conditioning ALT Alternate DWG Drawing AL Aluminum Elevation ARCH Architect (ural) BFE Base Flood Elevation EXIST Existing BIT Bituminous EXP Exposed BLK Block EXT Exterior BD Board FIN Finish (ed) BLDG Building FFE Finished Floor Elevation BTM Bottom FLG Flashing CPT Carpet (ed) FLR Floor (ing) CLG Ceiling COL Column CONC Concrete CMU Concrete Masonry Unit CONT Continuous or Continue DTL Detail DIAM Diameter

FTG Footing GA Gage, Gauge GAL Galvanized General Contract (or HDW Hardware HM Hollow Metal HORI Horizontal High Point Height HWH Hot Water Heater Inside Diameter INSUL Isulated Interior Joint Low Point Level MIL Metal MIN Minimum MISC Miscellaneous MULL Mullion

RAD Radius REQ Required NGVD National Geodedic Vertical Datum RFD Regulatory Flood Datum NIC Not In Contract Room NSF Net Square Footage Solid Core NTS Not To Scale Stainless Steel OC On Center (s) Similar OPNG Opening Steel ORCH Orchestra SYS System OD Outside Diameter THK Thick (ness) Paint (ed) T&G Tongue And Groove PVMT Pavement TSL Top Of Slab Plate Typical PWD Plywood VCT Vinyl Composition Tile Pounds Per Square Inch VERT Vertical Precast Concrte VIF Verify In Field PCP Precast Panel VB Vinyl Base VT Vinyl Tile WC Water Closet WIP Work In Progress W/I Within WWF Welded Wire Fabric WWM Welded Wire Mesh WD Wood

4 Δ**R**

ABBREVIATIONS

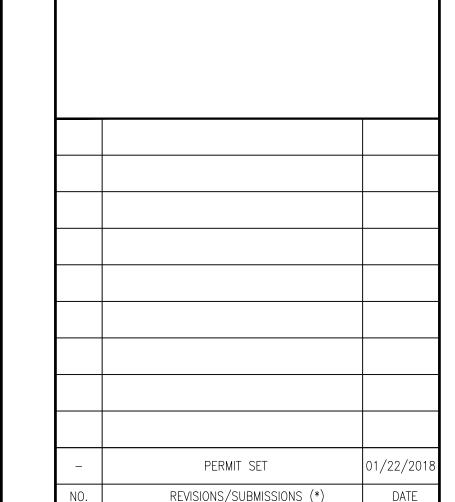

28th STREET OBELISK

AND PUMP STATION

RESTORATION

300 WEST 28th STREET

MIAMI BEACH, FL. 33139

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SHEET TITLE

ISSUE DATE: 01/22/2018

PROJECT NO. 121555

GENERAL NOTES - SPECIFICATIONS
PROJECT INFORMATION


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CHECKED BY WM


DRAWING NO.

DATE: WILLIAM B MEDELLIN ARCHITECT P.A. FL REGISTRATION No. 0003400


GENERAL NOTES - SPECIFICATIONS



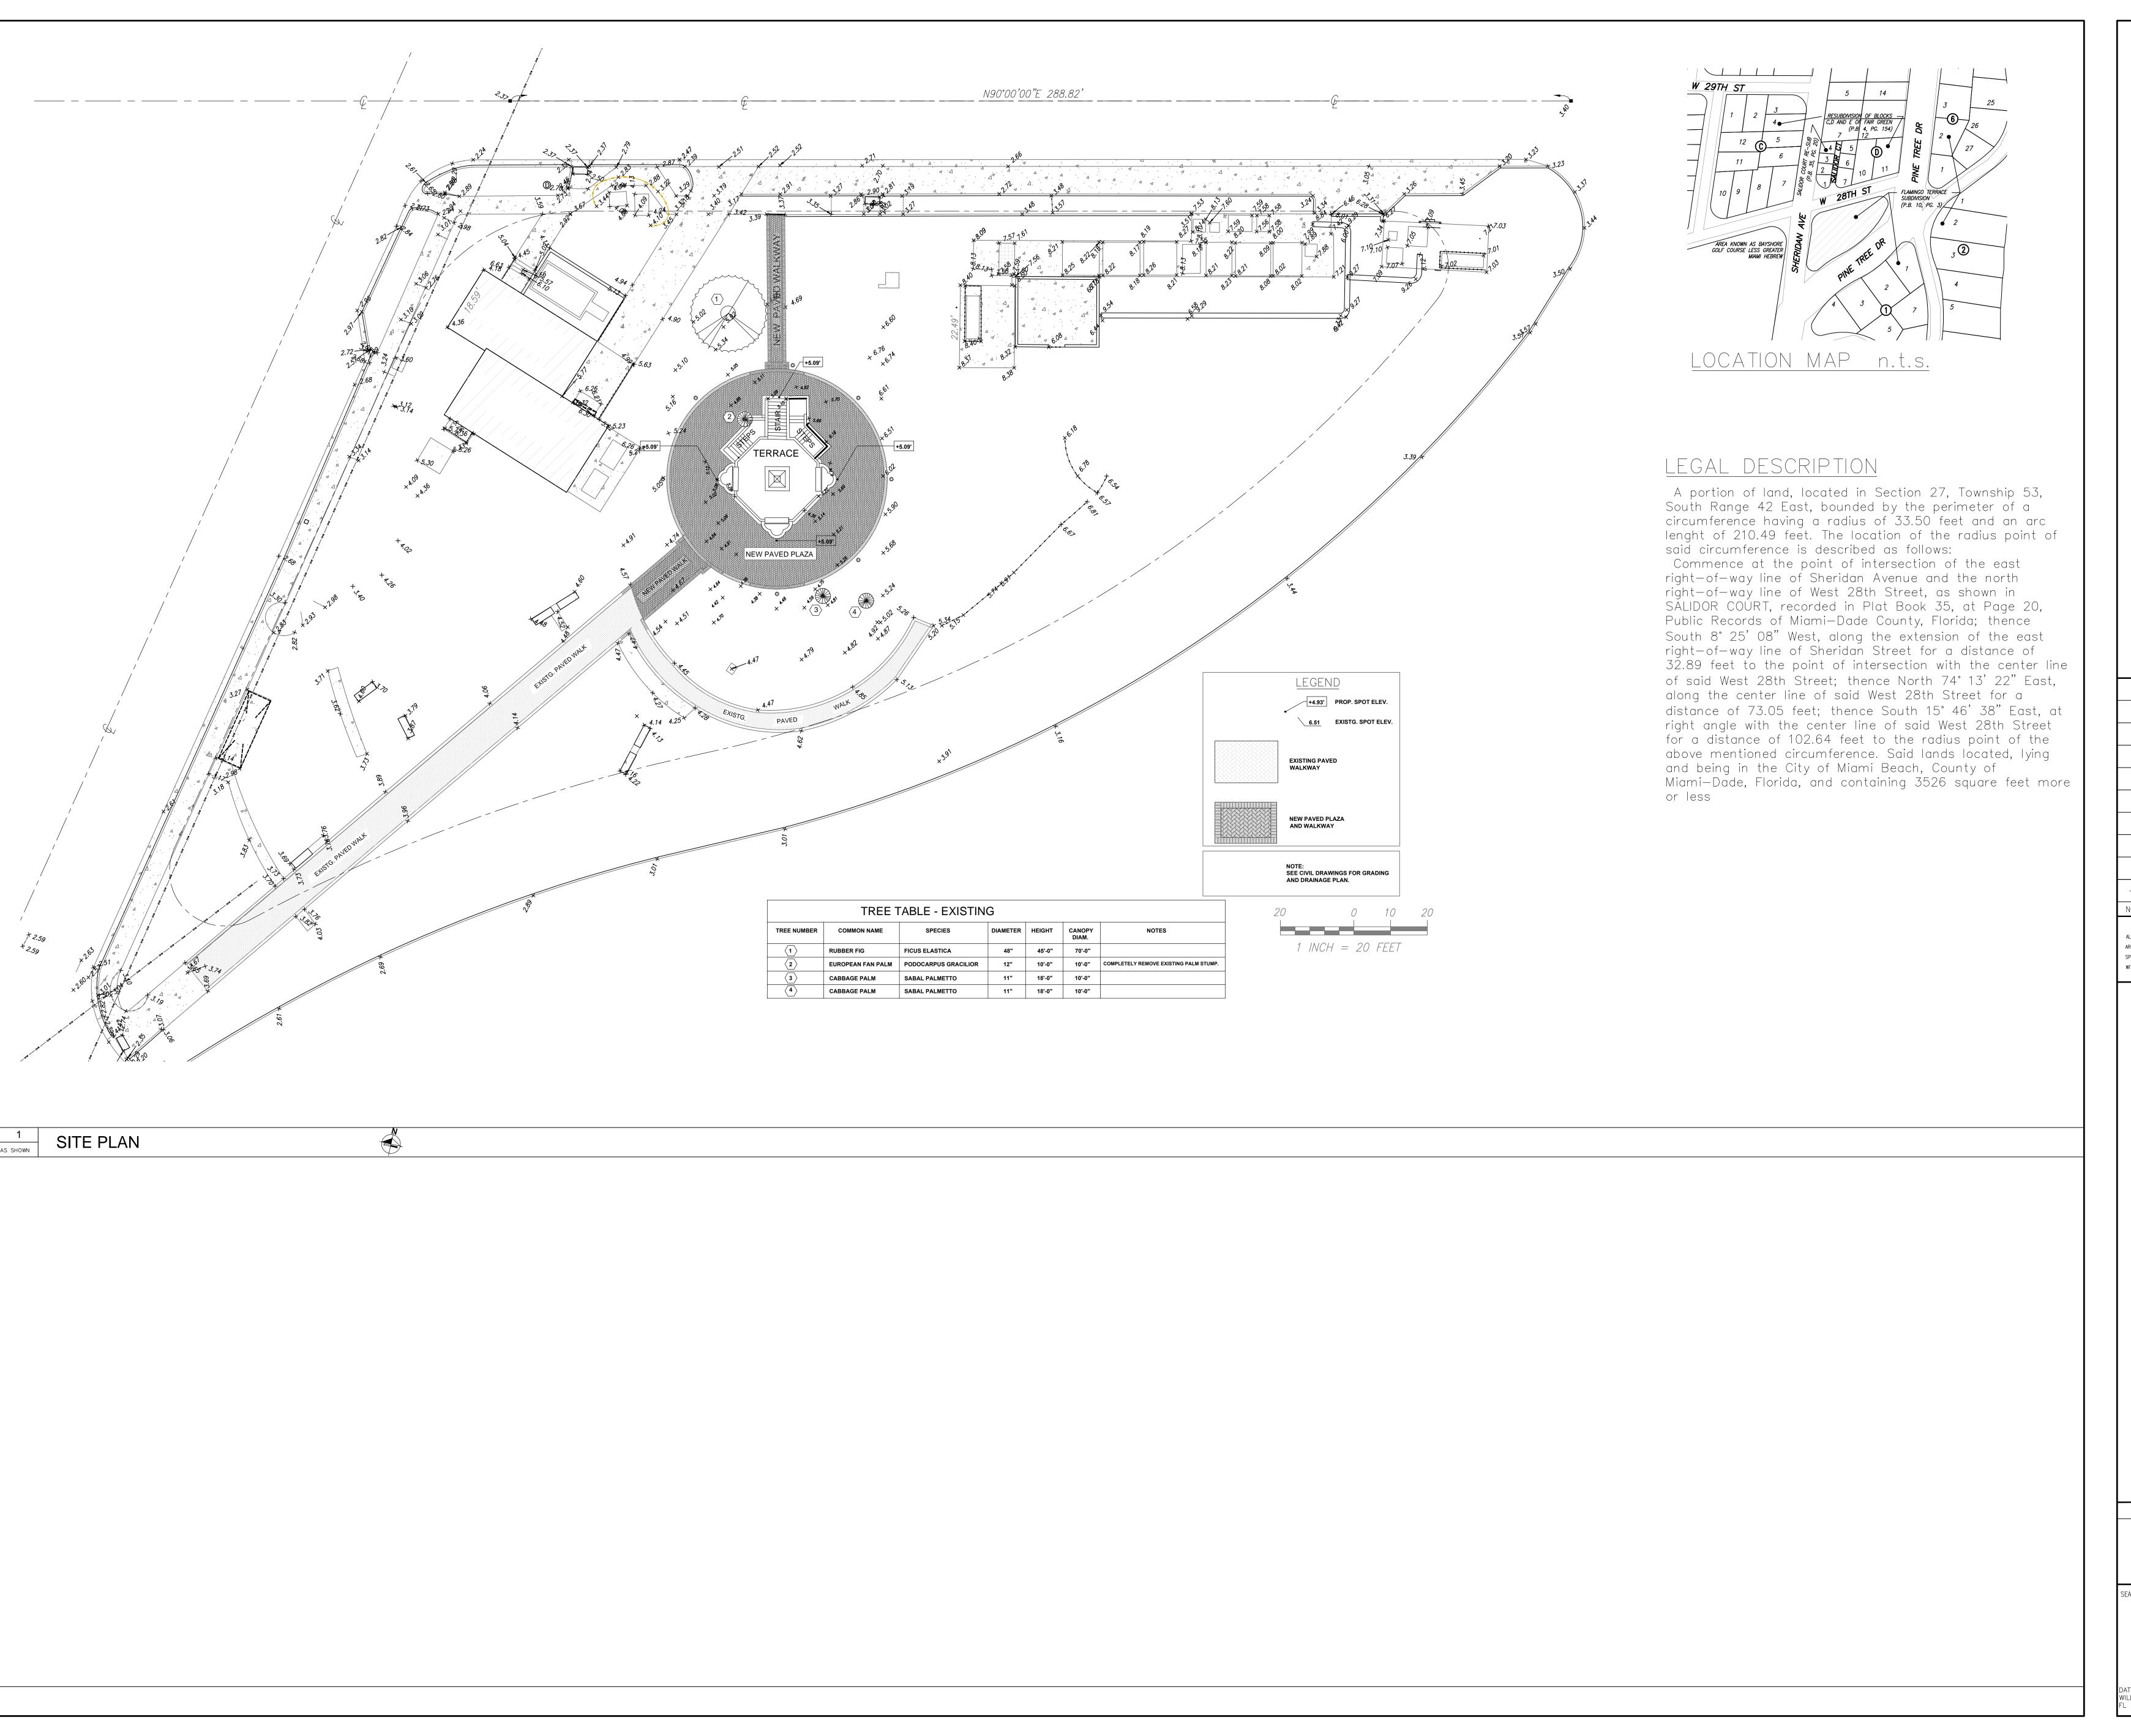

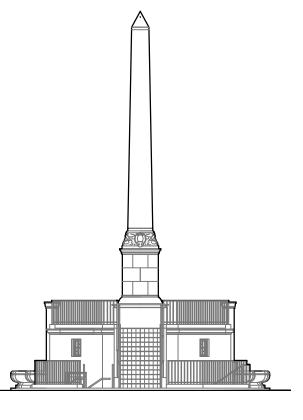

300 WEST 28th STREET MIAMI BEACH, FL. 33139

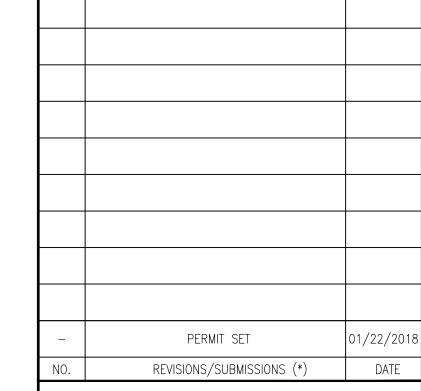

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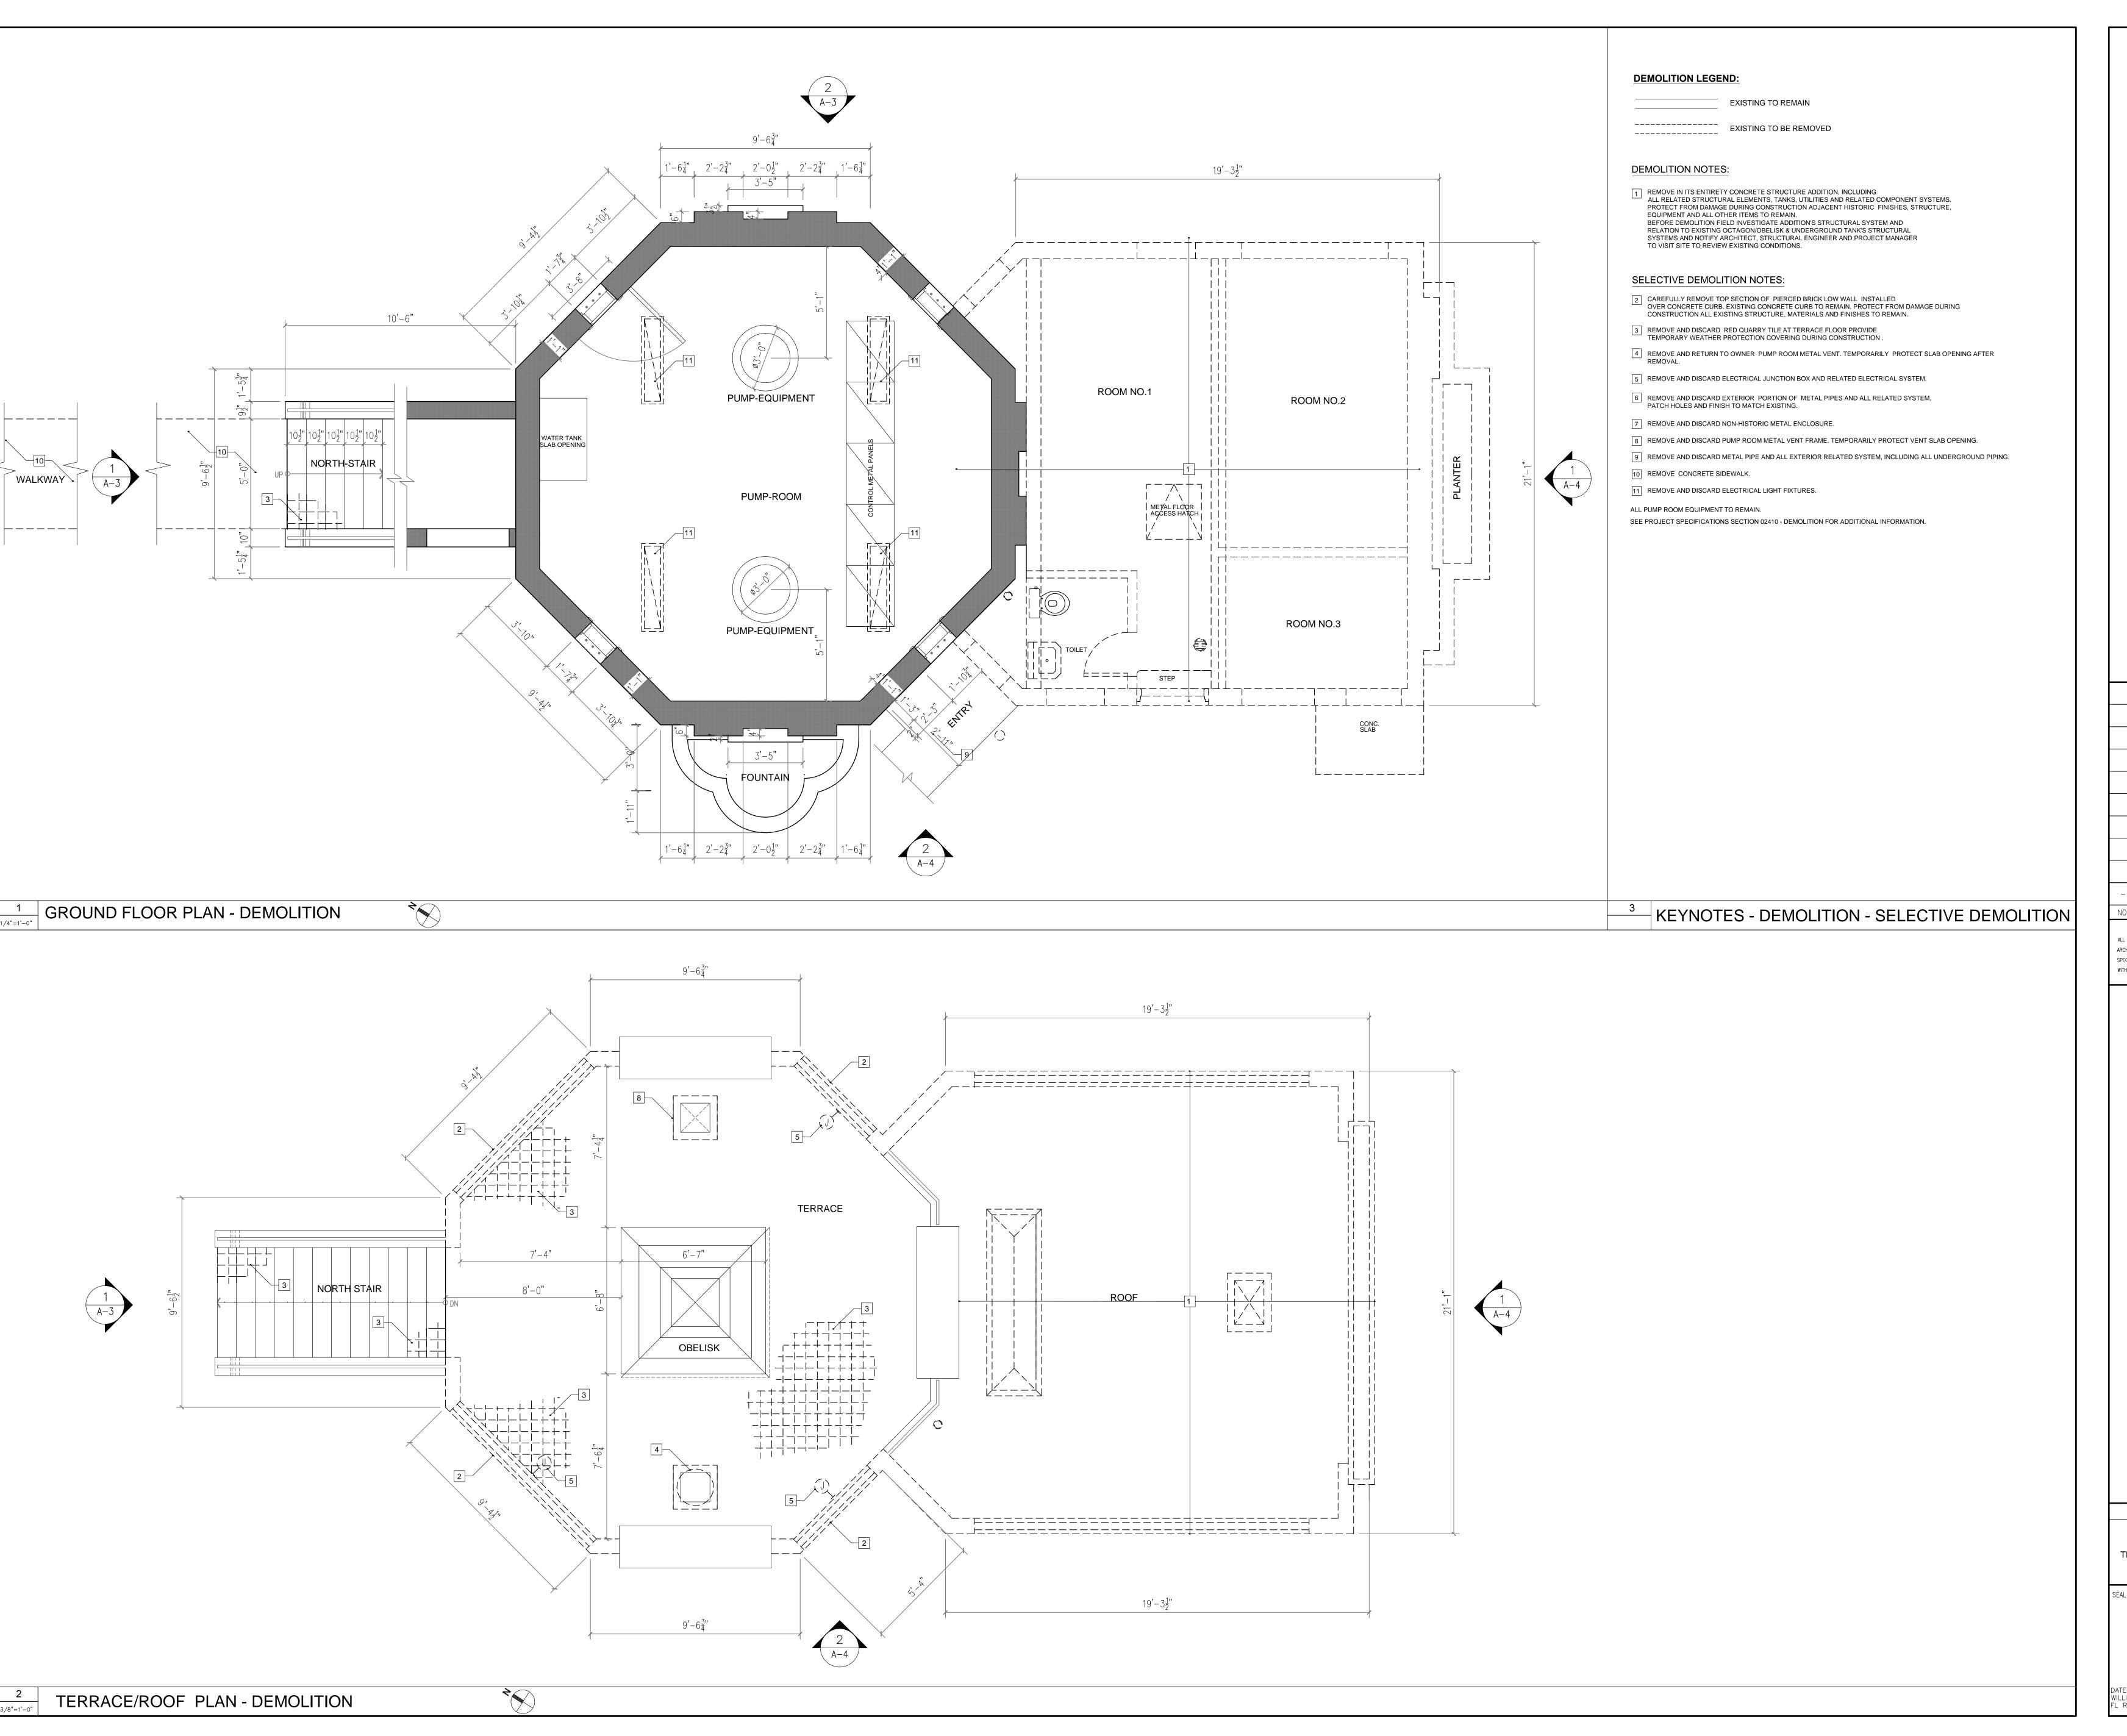
SHEET TITLE

SITE PLAN


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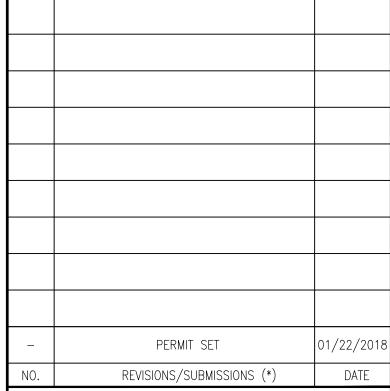
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300 WEST 28th STREET MIAMI BEACH, FL. 33139



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560 N.E. 71 STREET

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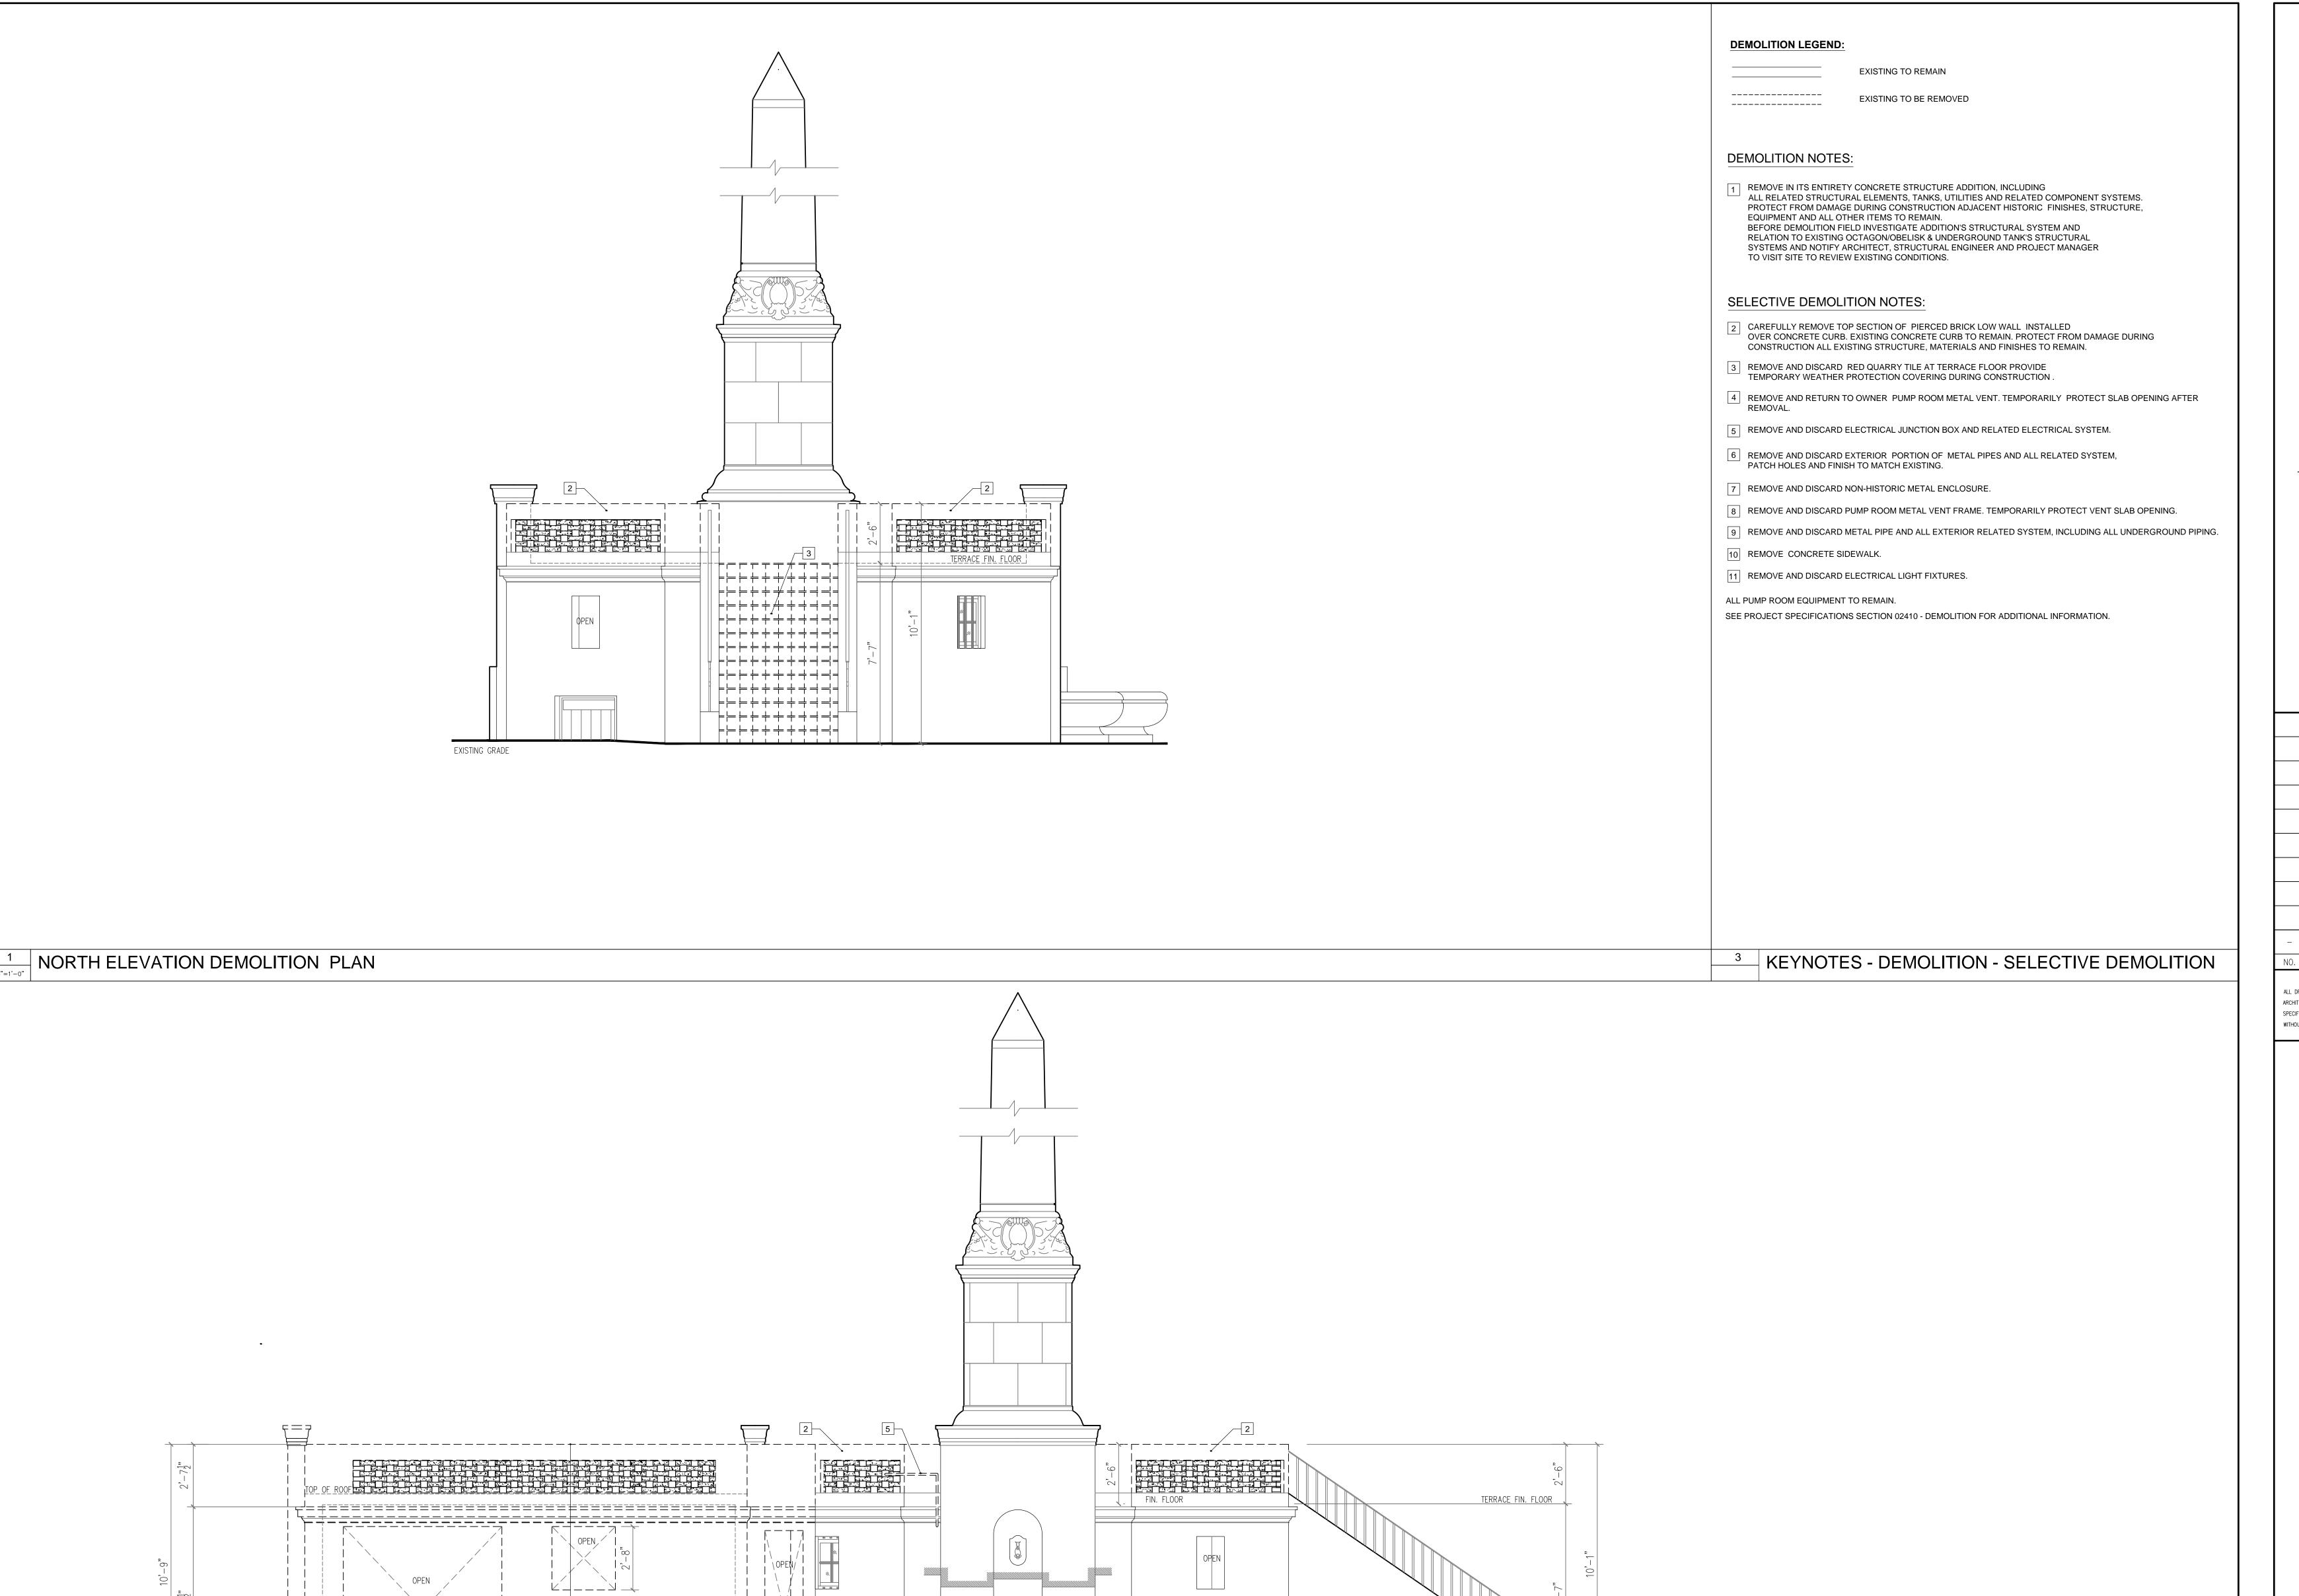
MAQUEIRA ENGINEERING CONSULTANTS
7220 S.W. 39th TERRACE
MIAMI, FL 33155
305-444-8210

SHEET TITLE

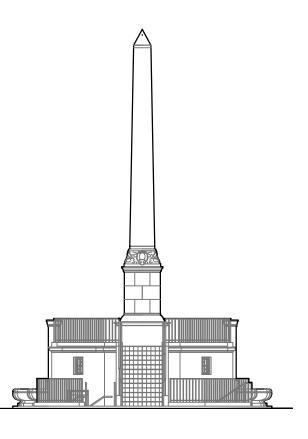GROUND FLOOR PLAN - DEMOLITION
TERRACE FLOOR/ROOF PLAN - DEMOLITION

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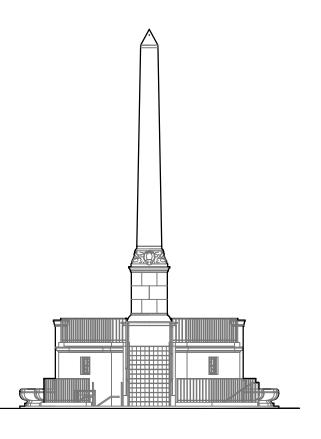
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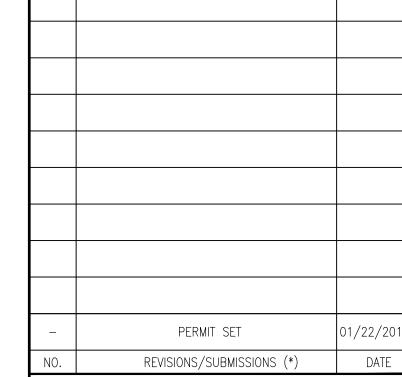
EAST ELEVATION DEMOLITION PLAN





28th STREET OBELISK AND PUMP STATION RESTORATION

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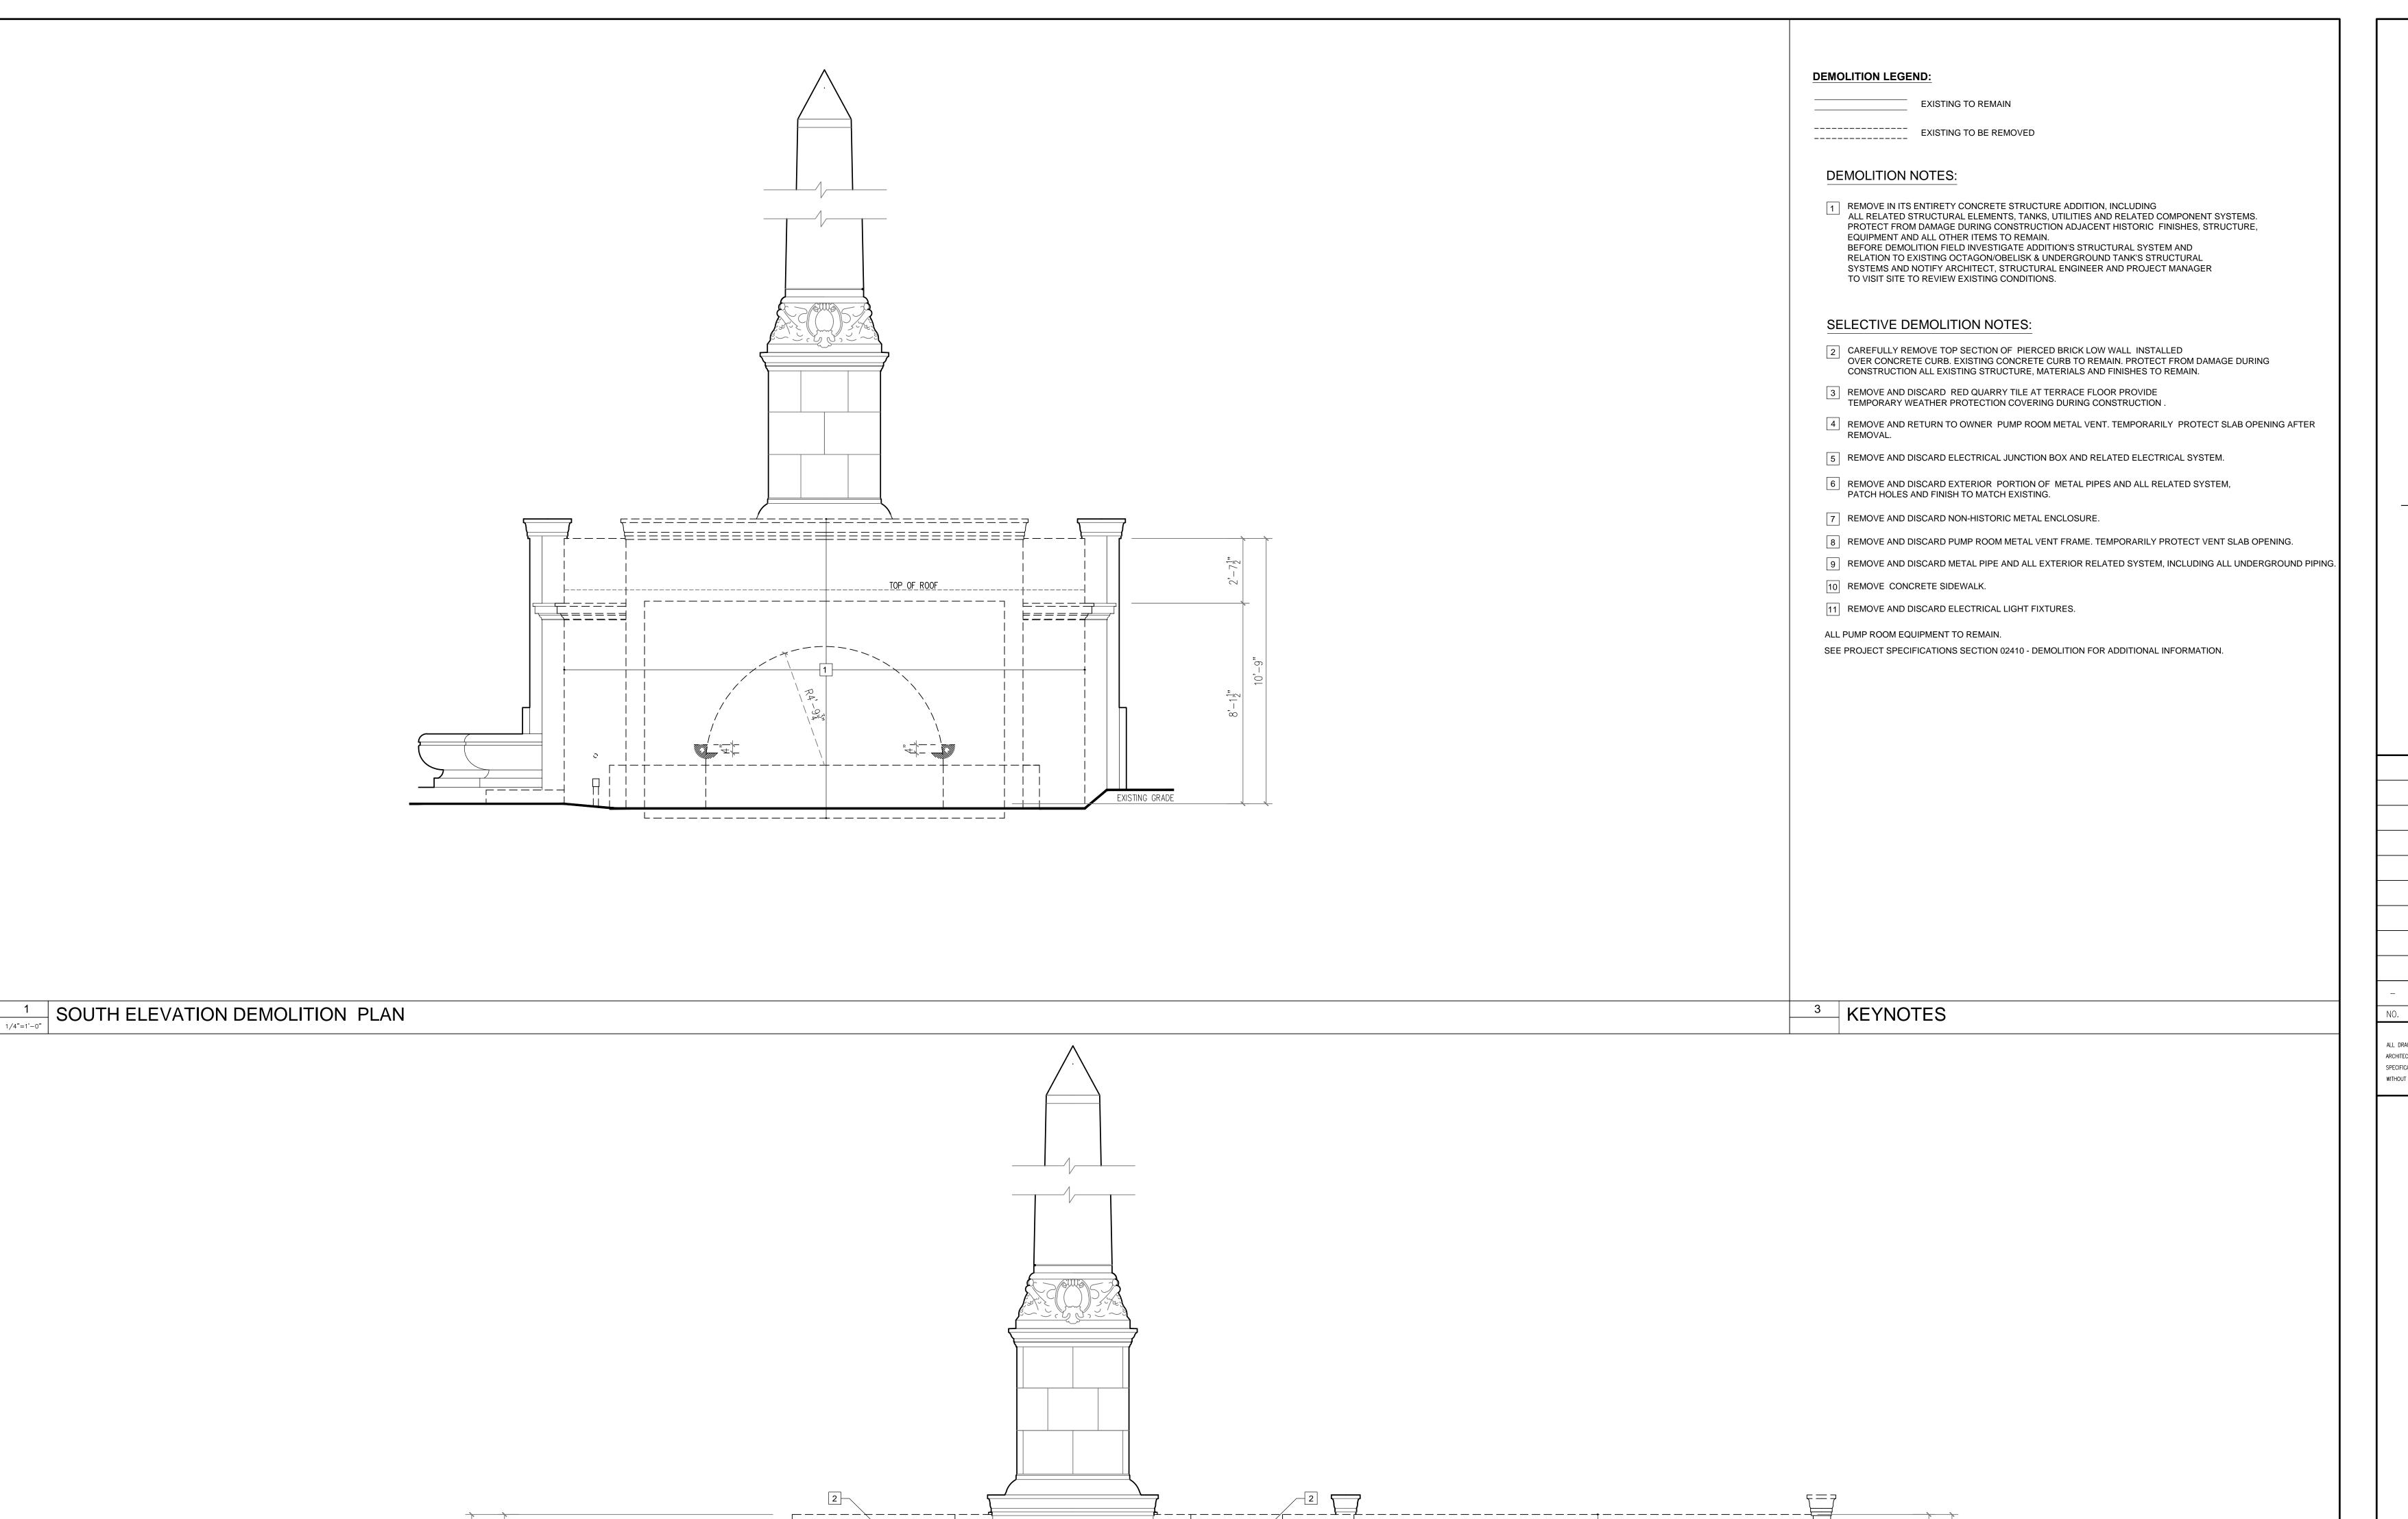
SHEET TITLE

EXTERIOR ELEVATIONS - DEMOLITION

ISSUE DATE: 01/22/2018 PROJECT NO. 121555 DRAWN BY ZA/WM CHECKED BY WM

A-3

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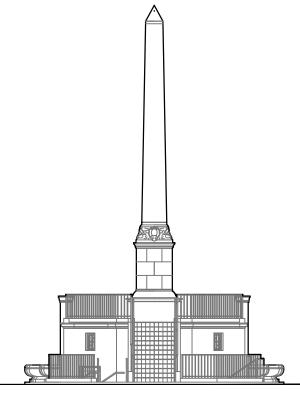
OPEN

TERRACE FIN. FLOOR

OPEN


WEST ELEVATION DEMOLITION PLAN






28th STREET OBELISK AND PUMP STATION RESTORATION

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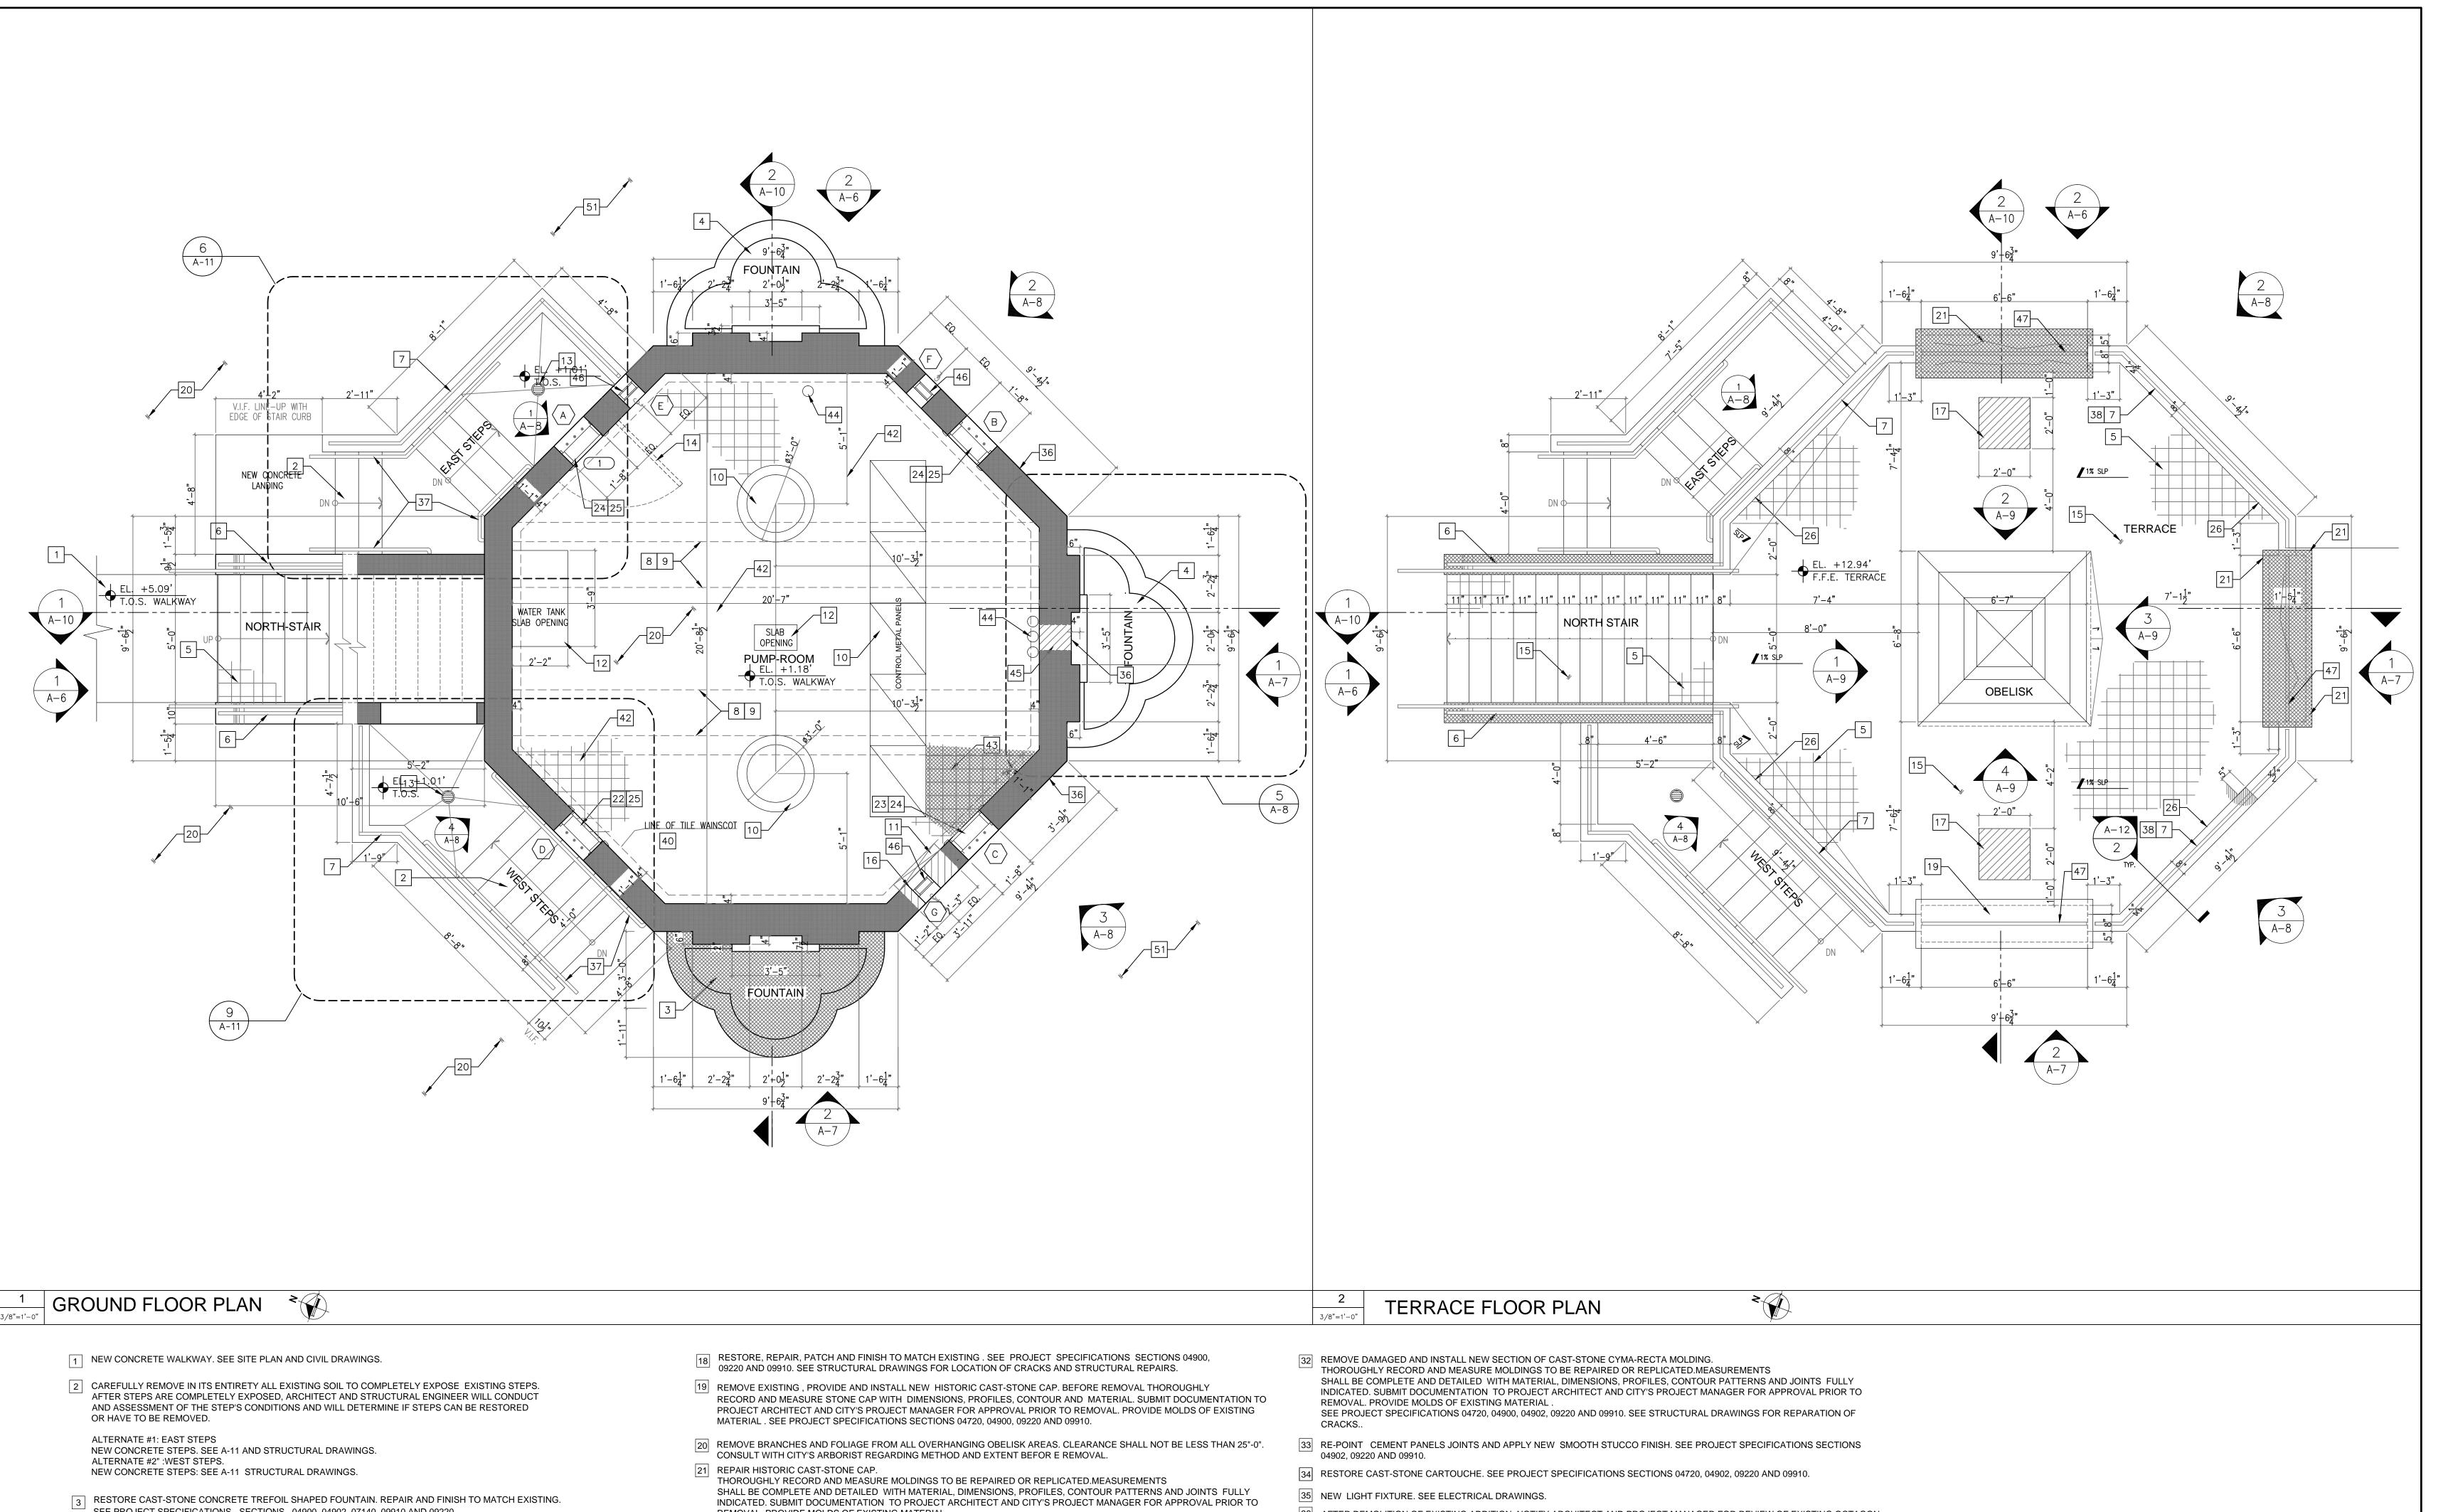
SHEET TITLE

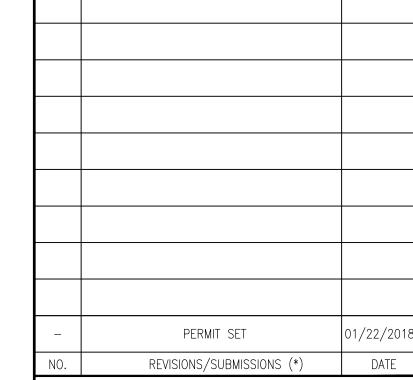EXTERIOR ELEVATIONS - DEMOLITION

ISSUE DATE: 01/22/2018 PROJECT NO. 121555 CHECKED BY WM

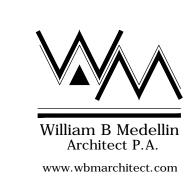A-4

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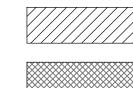
- SEE PROJECT SPECIFICATIONS SECTIONS , 04900, 04902, 07140, 09910 AND 09220. PROVIDE AND INSTALL NEW PLUMBING AND ELECTRICAL SYSTEMS. SEE PLUMBING AND ELECTRICAL DRAWINGS. SEE STRUCTURAL DRAWINGS FOR STRUCTURAL REPAIRS.
- NEW CAST-STONE CONCRETE TREFOIL SHAPED FOUNTAIN TO MATCH SIZE, MATERIAL, SHAPE, TEXTURE AND FINISH OF EXISTING FOUNTAIN LOCATED AT WESTERN SIDE OF OBELISK. PROVIDE AND INSTALL NEW PLUMBING AND ELECTRICAL SYSTEMS. SEE PROJECT SPECIFICATIONS SECTIONS 04720,07140, 09910 AND 09220.
- THOROUGHLY RECORD AND MEASURE EXISTING FOUNTAIN, MEASUREMENTS SHALL BE DETAILED AND COMPLETE WITH ALL DIMENSIONS, MATERIAL, PROFILES, CONTOUR PATTERNS FULLY INDICATED. SUBMIT DOCUMENTATION OF EXISTING MATERIAL TO PROJECT ARCHITECT AND CITY'S PROJECT MANAGER FOR APPROVAL .PROVIDE MOLDS OF EXISTING FOUNTAIN.
- 5 PROVIDE AND INSTALL NEW QUARRY TILE PAVERS. SEE PROJECT SPECIFICATIONS SECTION 07141 AND 09330
- 6 RESTORE , REPAIR, STABILIZE HISTORIC WROUGHT IRON HANDRAIL. ADD NEW WROUGHT IRON TOP RAILING SECTION AS SHOWN ON DRAWINGS. SEE PROJECT SPECIFICATIONS SECTIONS 05700 AND 05700.
- 7 NEW WROUGHT IRON GUARDRAIL. SEE PROJECT SPECIFICATIONS SECTION 05700.
- 8 INSTALL TEMPORARY SHORING TO SUPPORT EXISTING CONCRETE BEAMS AND FLOOR TERRACE SLAB. SEE STRUCTURAL DRAWINGS FOR TEMPORARY SHORING SPECIFICATIONS AND DETAILS.
- 9 REPAIR STRUCTURAL BEAMS. SEE STRUCTURAL DRAWINGS.
- 10 CLEAN AND STABILIZE PUMP ROOM EQUIPMENT. SEE DIVISION 5 METALS DRAWING A-0.
- PROVIDE AND INSTALL 3"X6" CERAMIC TILE WAINSCOT WITH CERAMIC TILE BULLNOSE. SUBMIT SAMPLES FOR APPROVAL PRIOR TO INSTALLATION. SEE PROJECT SPECIFICATIONS SECTION 09310.
- 12 NEW WALL OPENINGS FOR VENTILATION LOUVER. SEE MECHANICAL DRAWINGS.
- 13 NEW FLOOR DRAIN. SEE PLUMBING DRAWINGS.
- 14 RESTORE AND REPAIR HISTORIC WOOD DOOR AND DOOR HARDWARE. SEE DOOR SCHEDULE AND PROJECT SPECIFICATIONS SECTIONS 06401, 08700, AND 08710.
- 15 REPAIR AND WATERPROOF EXISTING CONCRETE SLAB. SEE PROJECT SPECIFICATIONS SECTION 07141 AND STRUCTURAL
- DRAWINGS FOR STRUCTURAL REPAIRS. 16 BLOCK DOOR OPENING. SEE STRUCTURAL DRAWINGS.
- BLOCK CONCRETE SLAB VENT OPENING. SEE STRUCTURAL DRAWINGS.

- REMOVAL. PROVIDE MOLDS OF EXISTING MATERIAL.
- SEE PROJECT SPECIFICATIONS 04720, 04900, 04902, 09220 AND 09910. NEW 18"W X 24" HT. WOOD FRAME WINDOW. SEE WINDOW SCHEDULE.
- COMPLETELY REMOVE EXISTING SECTIONS OF COPPER BARS AND PROVIDE AND INSTALL NEW 1" DIAM. COPPER BARS. PATCH AND FINISH ADJACENT AREAS TO MATCH EXISTING. SUBMIT SAMPLE FOR APPROVAL.
- 24 RESTORE 18"W X 24" HT. HISTORIC WOOD FRAME WINDOW. SEE WINDOW SCHEDULE AND PROJECT SPECIFICATIONS SECTION 06401, 08610, 08710, 08800 AND 09910.
- 25 CLEAN COPPER BARS. SEE DIVISION 5 METALS. DRAWING A-0.
- 26 AFTER REMOVAL OF PIERCED BRICK LOW WALL, REPAIR, PATCH AND FINISH TO MATCH EXISTING CONCRETE CURB TO REMAIN. SEE PROJECT SPECIFICATIONS SECTIONS 04900, 09220 AND 09910.
- PROVIDE AND INSTALL NEW CAST-STONE MOLDING. THOROUGHLY RECORD AND MEASURE MOLDINGS TO BE REPAIRED OR REPLICATED.MEASUREMENTS SHALL BE COMPLETE AND DETAILED WITH MATERIAL, DIMENSIONS, PROFILES, CONTOUR PATTERNS AND JOINTS FULLY INDICATED. SUBMIT DOCUMENTATION TO PROJECT ARCHITECT AND CITY'S PROJECT MANAGER FOR APPROVAL PRIOR TO REMOVAL. PROVIDE MOLDS OF EXISTING MATERIAL. SEE PROJECT SPECIFICATIONS SECTIONS 04720, 09220 AND 09910. SEE STRUCTURAL DRAWINGS FOR REPARATION OF CRACKS.
- CONCRETE PYRAMIDAL APEX. NOTIFY PROJECT ARCHITECT AND PROJECT MANAGER OF ASSESSMENT CONDITIONS. SCOPE OF WORK TO BE DETERMINED FOLLOWING ASSESSMENT OF EXISTING CONDITIONS.
- PROVIDE AND INSTALL MISSING STONE PANELS. MATCH EXISTING IN SIZE, MATERIAL, TEXTURE AND FINISH. SUBMIT SAMPLE FOR APPROVAL BEFORE INSTALLATION. PATCH EXISTING HOLES AT EAST ELEVATION CONCRETE BASE.
- SEE PROJECT SPECIFICATIONS SECTIONS 04720, 04902, 09220 AND 09910. RESTORE CAST-STONE SEA CREATURE ORNAMENT. SEE PROJECT SPECIFICATIONS SECTIONS 04720, 04902, 09220 AND 09910.
- REPLICATE TO MATCH EXISTING NEW CAST-STONE SEA CREATURE ORNAMENT. THOROUGHLY RECORD AND MEASURE EXISTING SEA CREATURE .MEASUREMENTS SHALL BE COMPLETE AND DETAILED WITH MATERIAL, DIMENSIONS AND PROFILES . SUBMIT DOCUMENTATION TO PROJECT ARCHITECT AND CITY'S PROJECT MANAGER FOR 1 APPROVAL. PROVIDE MOLDS OF EXISTING MATERIAL . SEE PROJECT SPECIFICATIONS SECTIONS 04720, 04902, 09220 AND 09910.

- 36 AFTER DEMOLITION OF EXISTING ADDITION, NOTIFY ARCHITECT AND PROJECT MANAGER FOR REVIEW OF EXISTING OCTAGON WALL TO REMAIN. SEE PROJECT SPECIFICATIONS SECTION 02410.
- 37 1½" DIAMETER METAL HANDRAIL. SEE PROJECT SPECIFICATIONS SECTION 05700.
- CAREFULLY REMOVE AND RESTORE HISTORIC WROUGHT IRON PICKETS. USE RESTORED PICKETS TO REPLACE DAMAGED PICKETS AT NORTH STAIR. SEE PROJECT SPECIFICATIONS SECTIONS 05700 AND 05720.
- 39 SEE SHEET A-9 FOR ARCHITECTURAL NOTES. SEE STRUCTURAL DRAWINGS FOR STRUCTURAL REPAIR.
- [40] CLEAN AND REPLACE DAMAGED 3"X6" CERAMIC TILE WAINSCOT AND BULLNOSE. SUBMIT SAMPLES FOR APPROVAL PRIOR TO INSTALLATION. SEE PROJECT SPECIFICATIONS SECTIONS 09310,09311, 09312 AND 09315.
- PROVIDE UNIT PRICE FOR CLEANING AND REPLACEMENT OF TILE.
- REPAIR AND PAINT CEMENT WALL FINISH. SEE PROJECT SPECIFICATIONS SECTIONS 09220 AND 09910.
- 42 CLEAN 6'X6" RED QUARRY TILE PAVERS.
- PROVIDE AND INSTALL NEW 6"X6" RED QUARRY TILE TO MATCH EXISTING. SEE PROJECT SPECIFICATIONS SECTION 09330. ESTIMATED AREA OF NEW REPLACEMENT TILE : 20 SQ. FT. PROVIDE UNIT COST FOR REPLACEMENT TILE.
- DURING THE CONSTRUCTION PHASE, CONDUCT ASSESSMENT CONDITION OF THE BLOCKED VENTILATION FLUE OPENINGS AND 44 FLOOR METAL CONDUITS TO REMAIN. REMOVE WIRING.
 - REMOVE WALL MOUNTED METAL ENCLOSURE AND RELATED SYSTEM. BLOCK CONCRETE OPENING SEE STRUCTURAL DRAWINGS.
 - 46 NEW 10" X 10" EXHAUST METAL LOUVER. SEE WINDOW SCHEDULE AND MECHANICAL PLANS.
 - NEW IRON GUARDRAIL 42" A.F.F. ON TOP OF CAST-STONE CAP. SEE PROJECT SPECIFICATIONS 05720.
 - 48 NEW LIGHT FIXTURE SEE ELECTRICAL DRAWINGS.
 - |49| PATCH HOLE WITH CONCRETE CEMENT, BEFORE INSTALLATION OF STONE PANEL VENEER.
 - PROVIDE AND INSTALL WATER PROOF SYSTEM. SEE PROJECT SPECIFICATIONS SECTION 07142.
 - 51 NEW PAVED PLAZA. SEE SITE PLAN AND CIVIL DRAWINGS.



EXISTING CONCRETE WALL/SLAB/COLUMN



NEW CONCRETE WALL/SLAB/COLUMN

WALL - STONE-- CEMENT -STUCCO- MOLDING REPAIR

WILLIAM B MEDELLIN ARCHITECT P.A. REGISTRATION No. 0003400

28th STREET OBELISK

AND PUMP STATION

RESTORATION

300 WEST 28th STREET MIAMI BEACH, FL. 33139

PERMIT SET

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SHEET TITLE

GROUND FLOOR PLAN

TERRACE FLOOR PLAN

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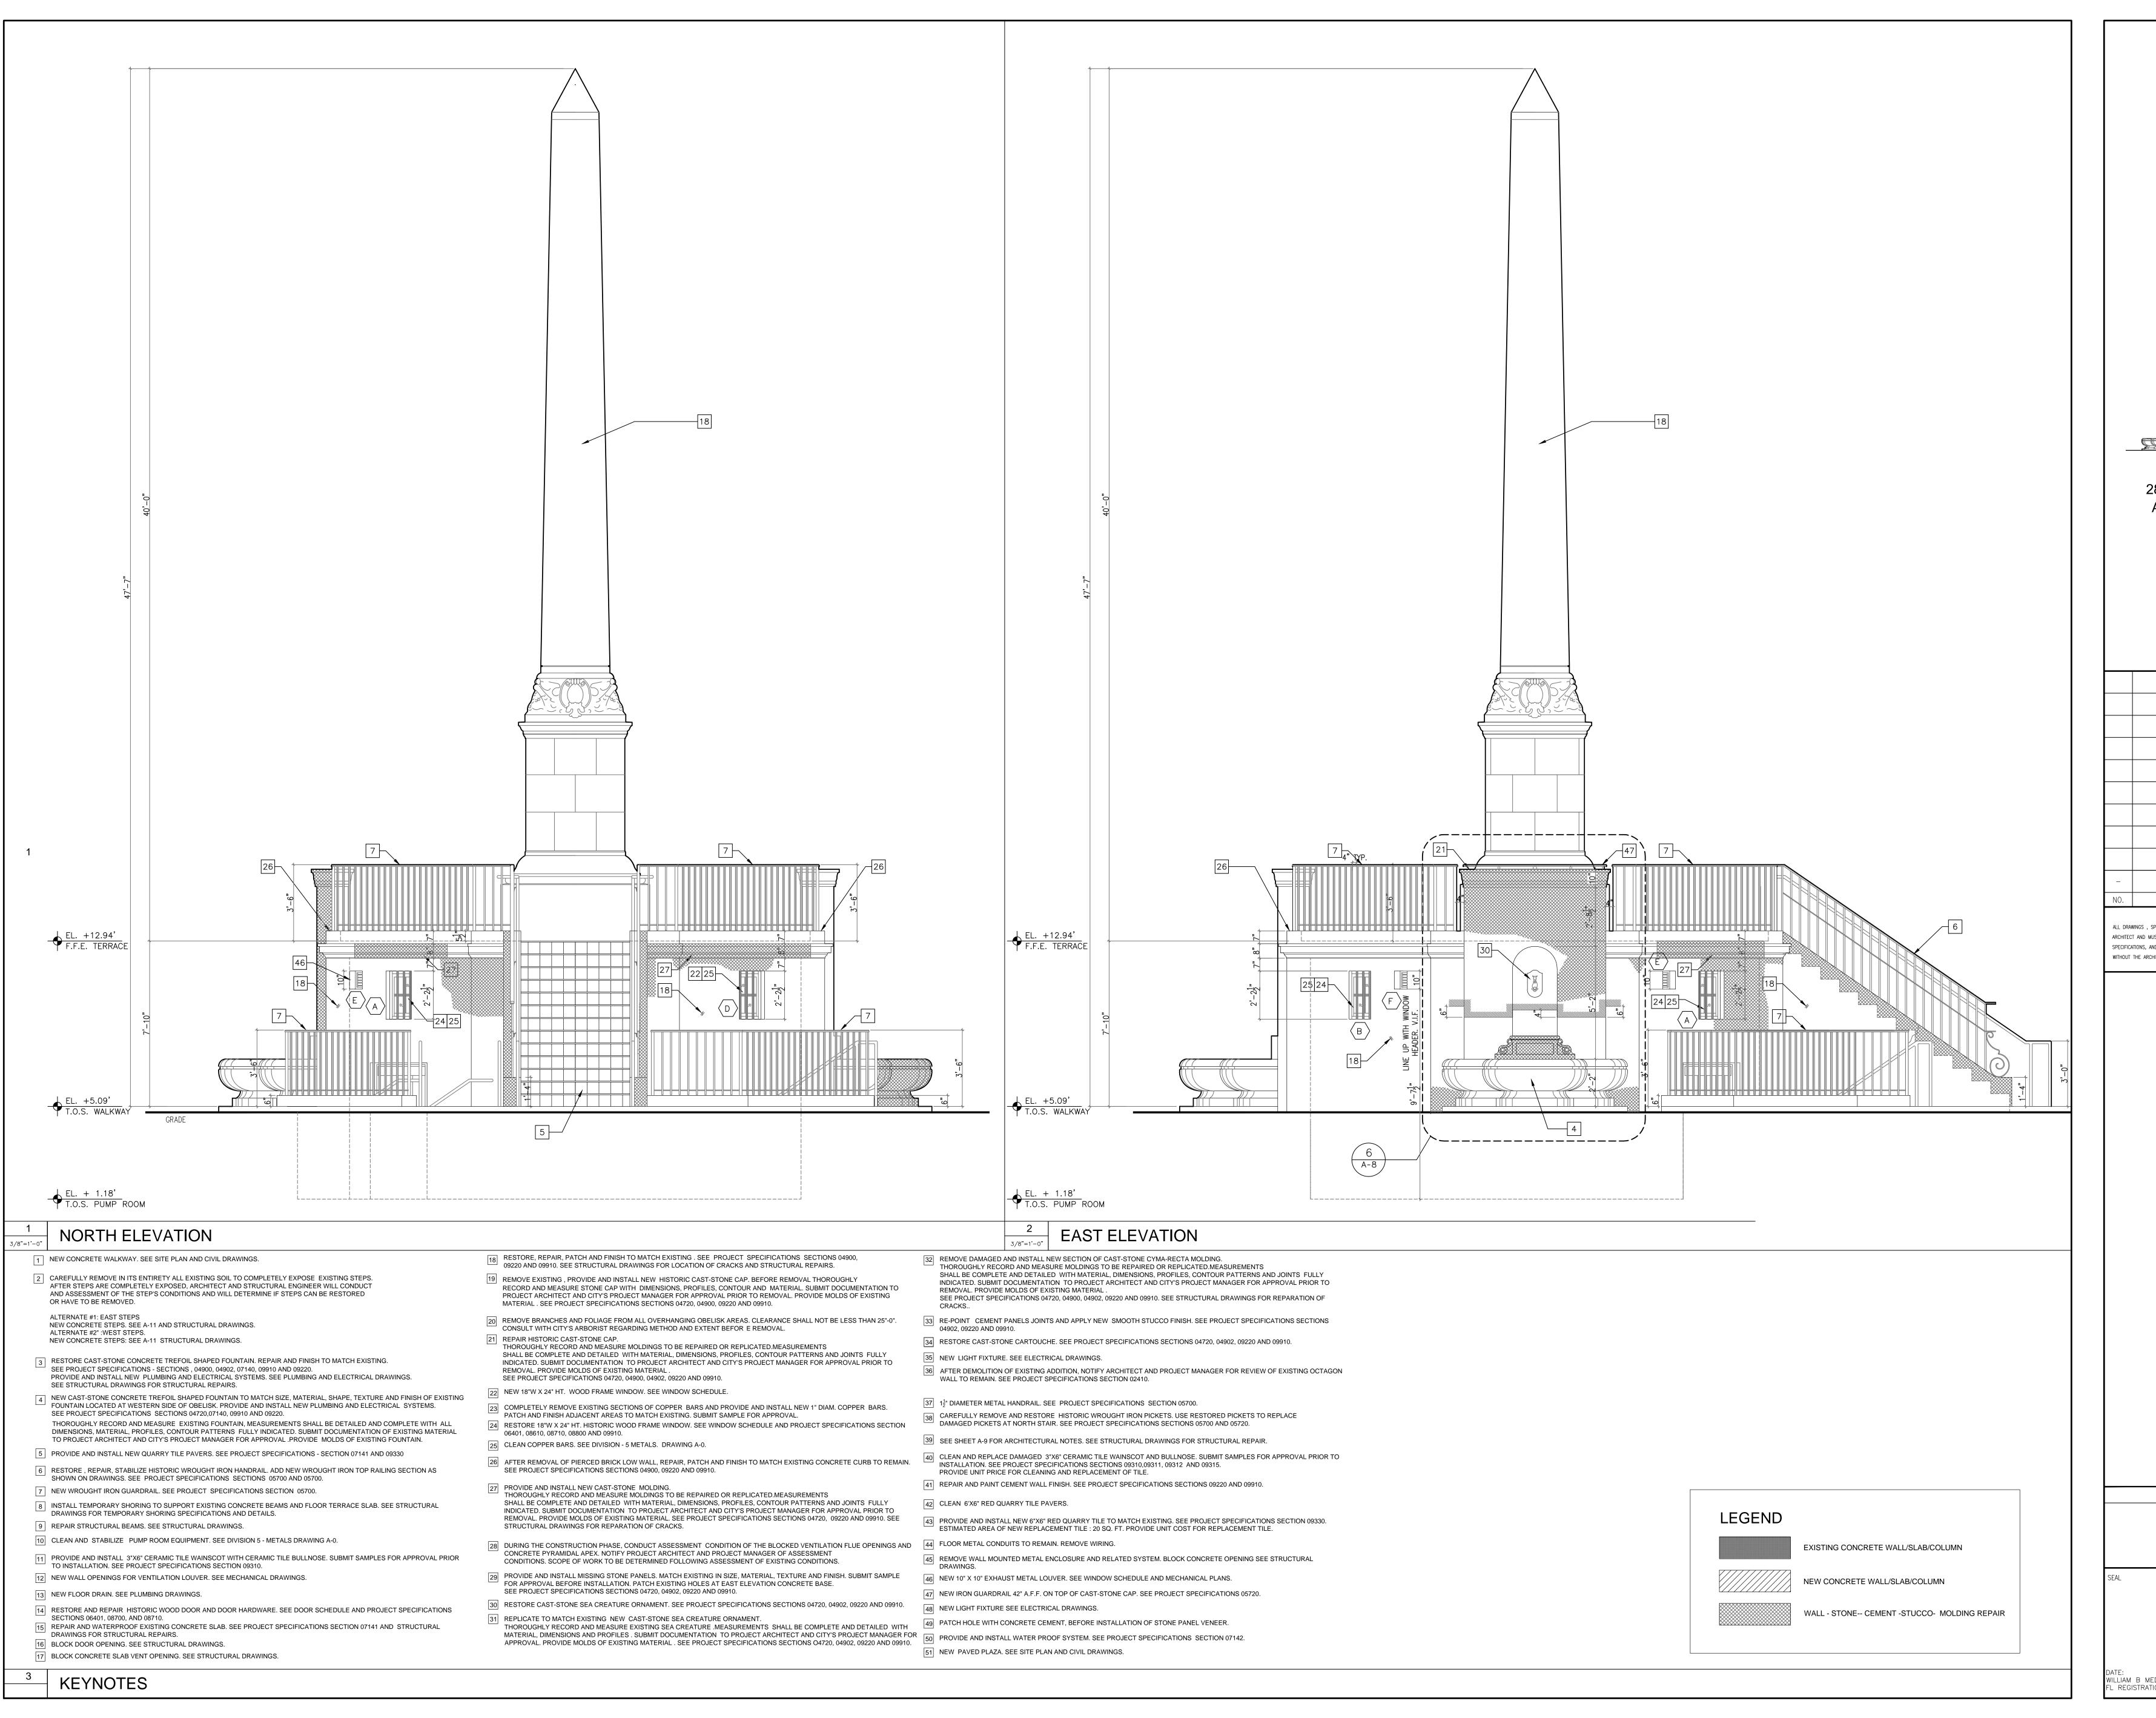
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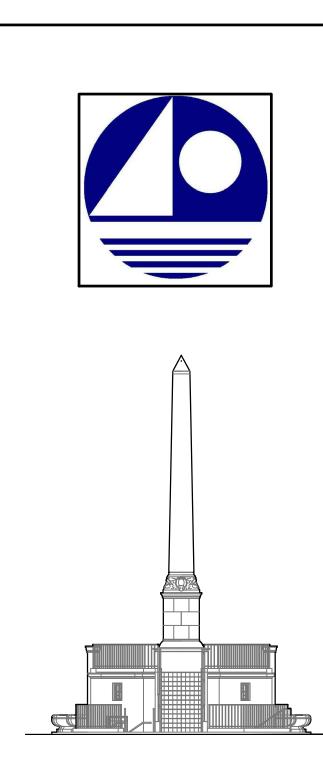
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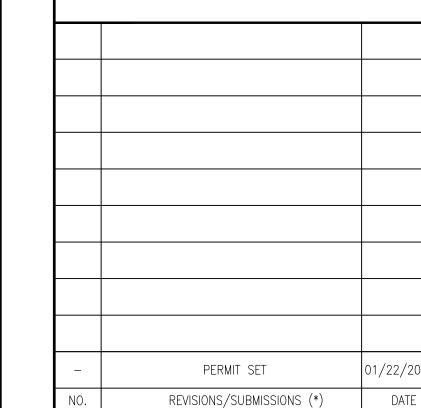
REVISIONS/SUBMISSIONS (*)

KEYNOTES





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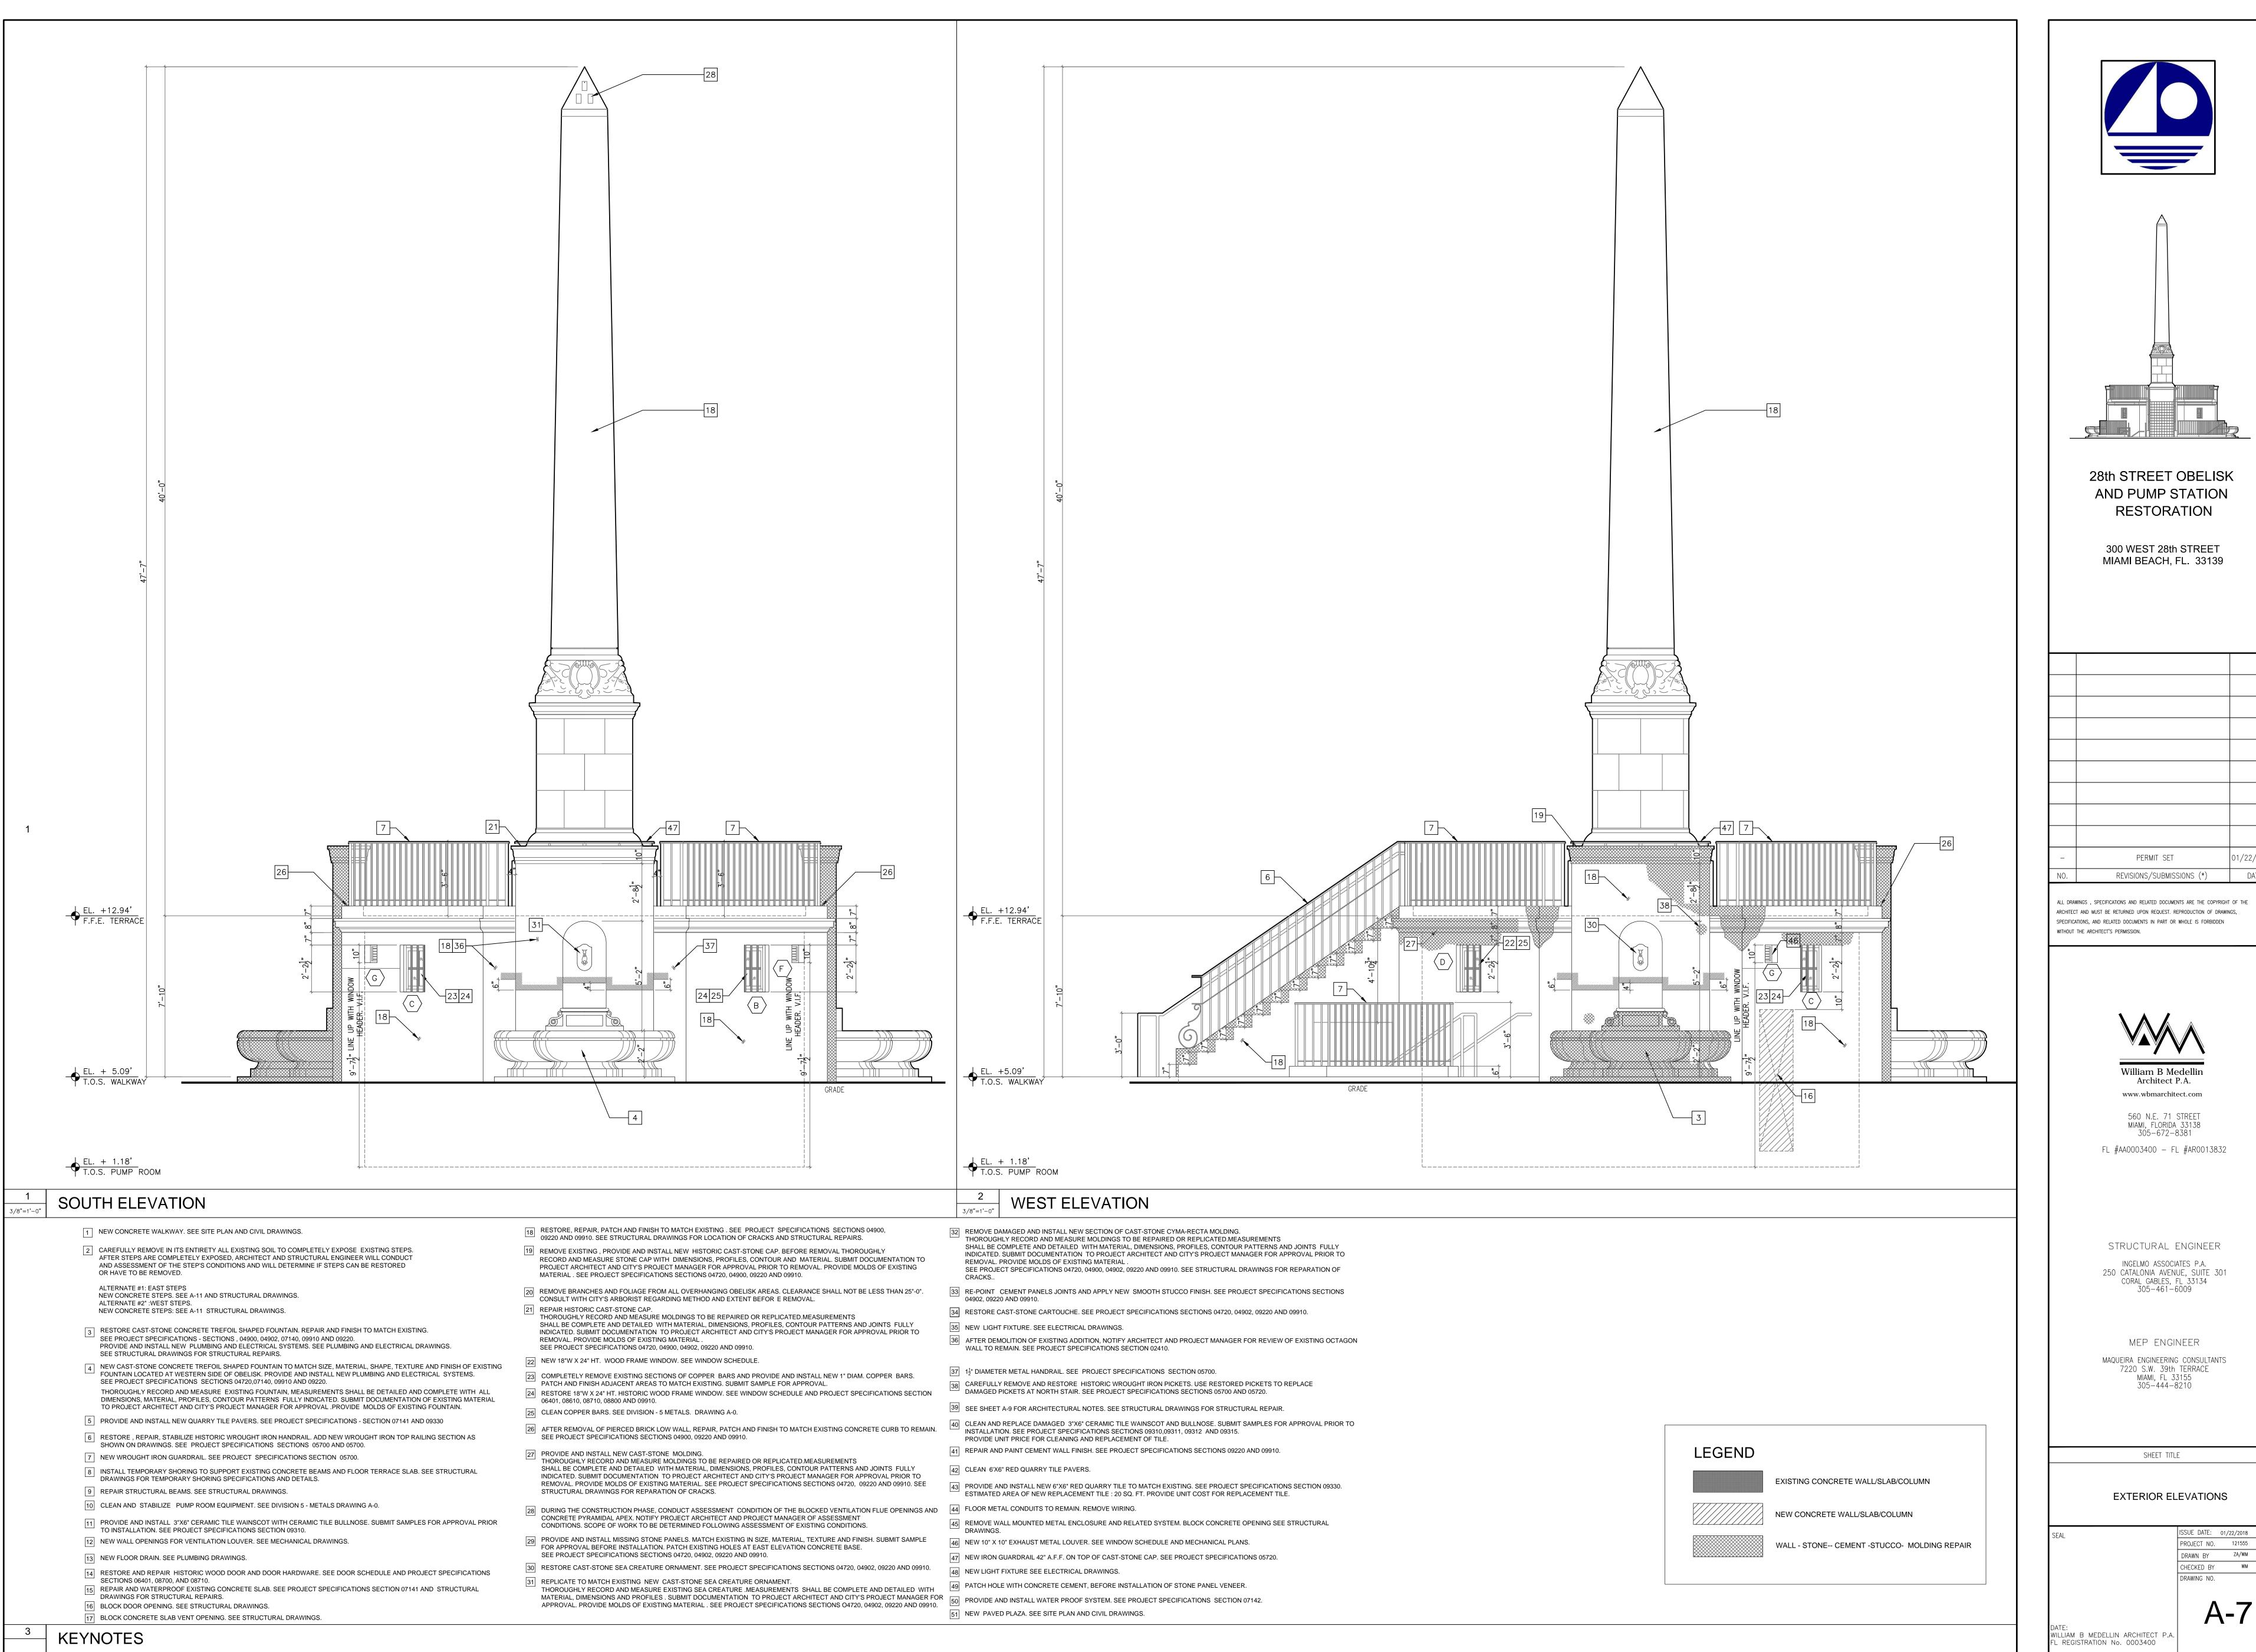
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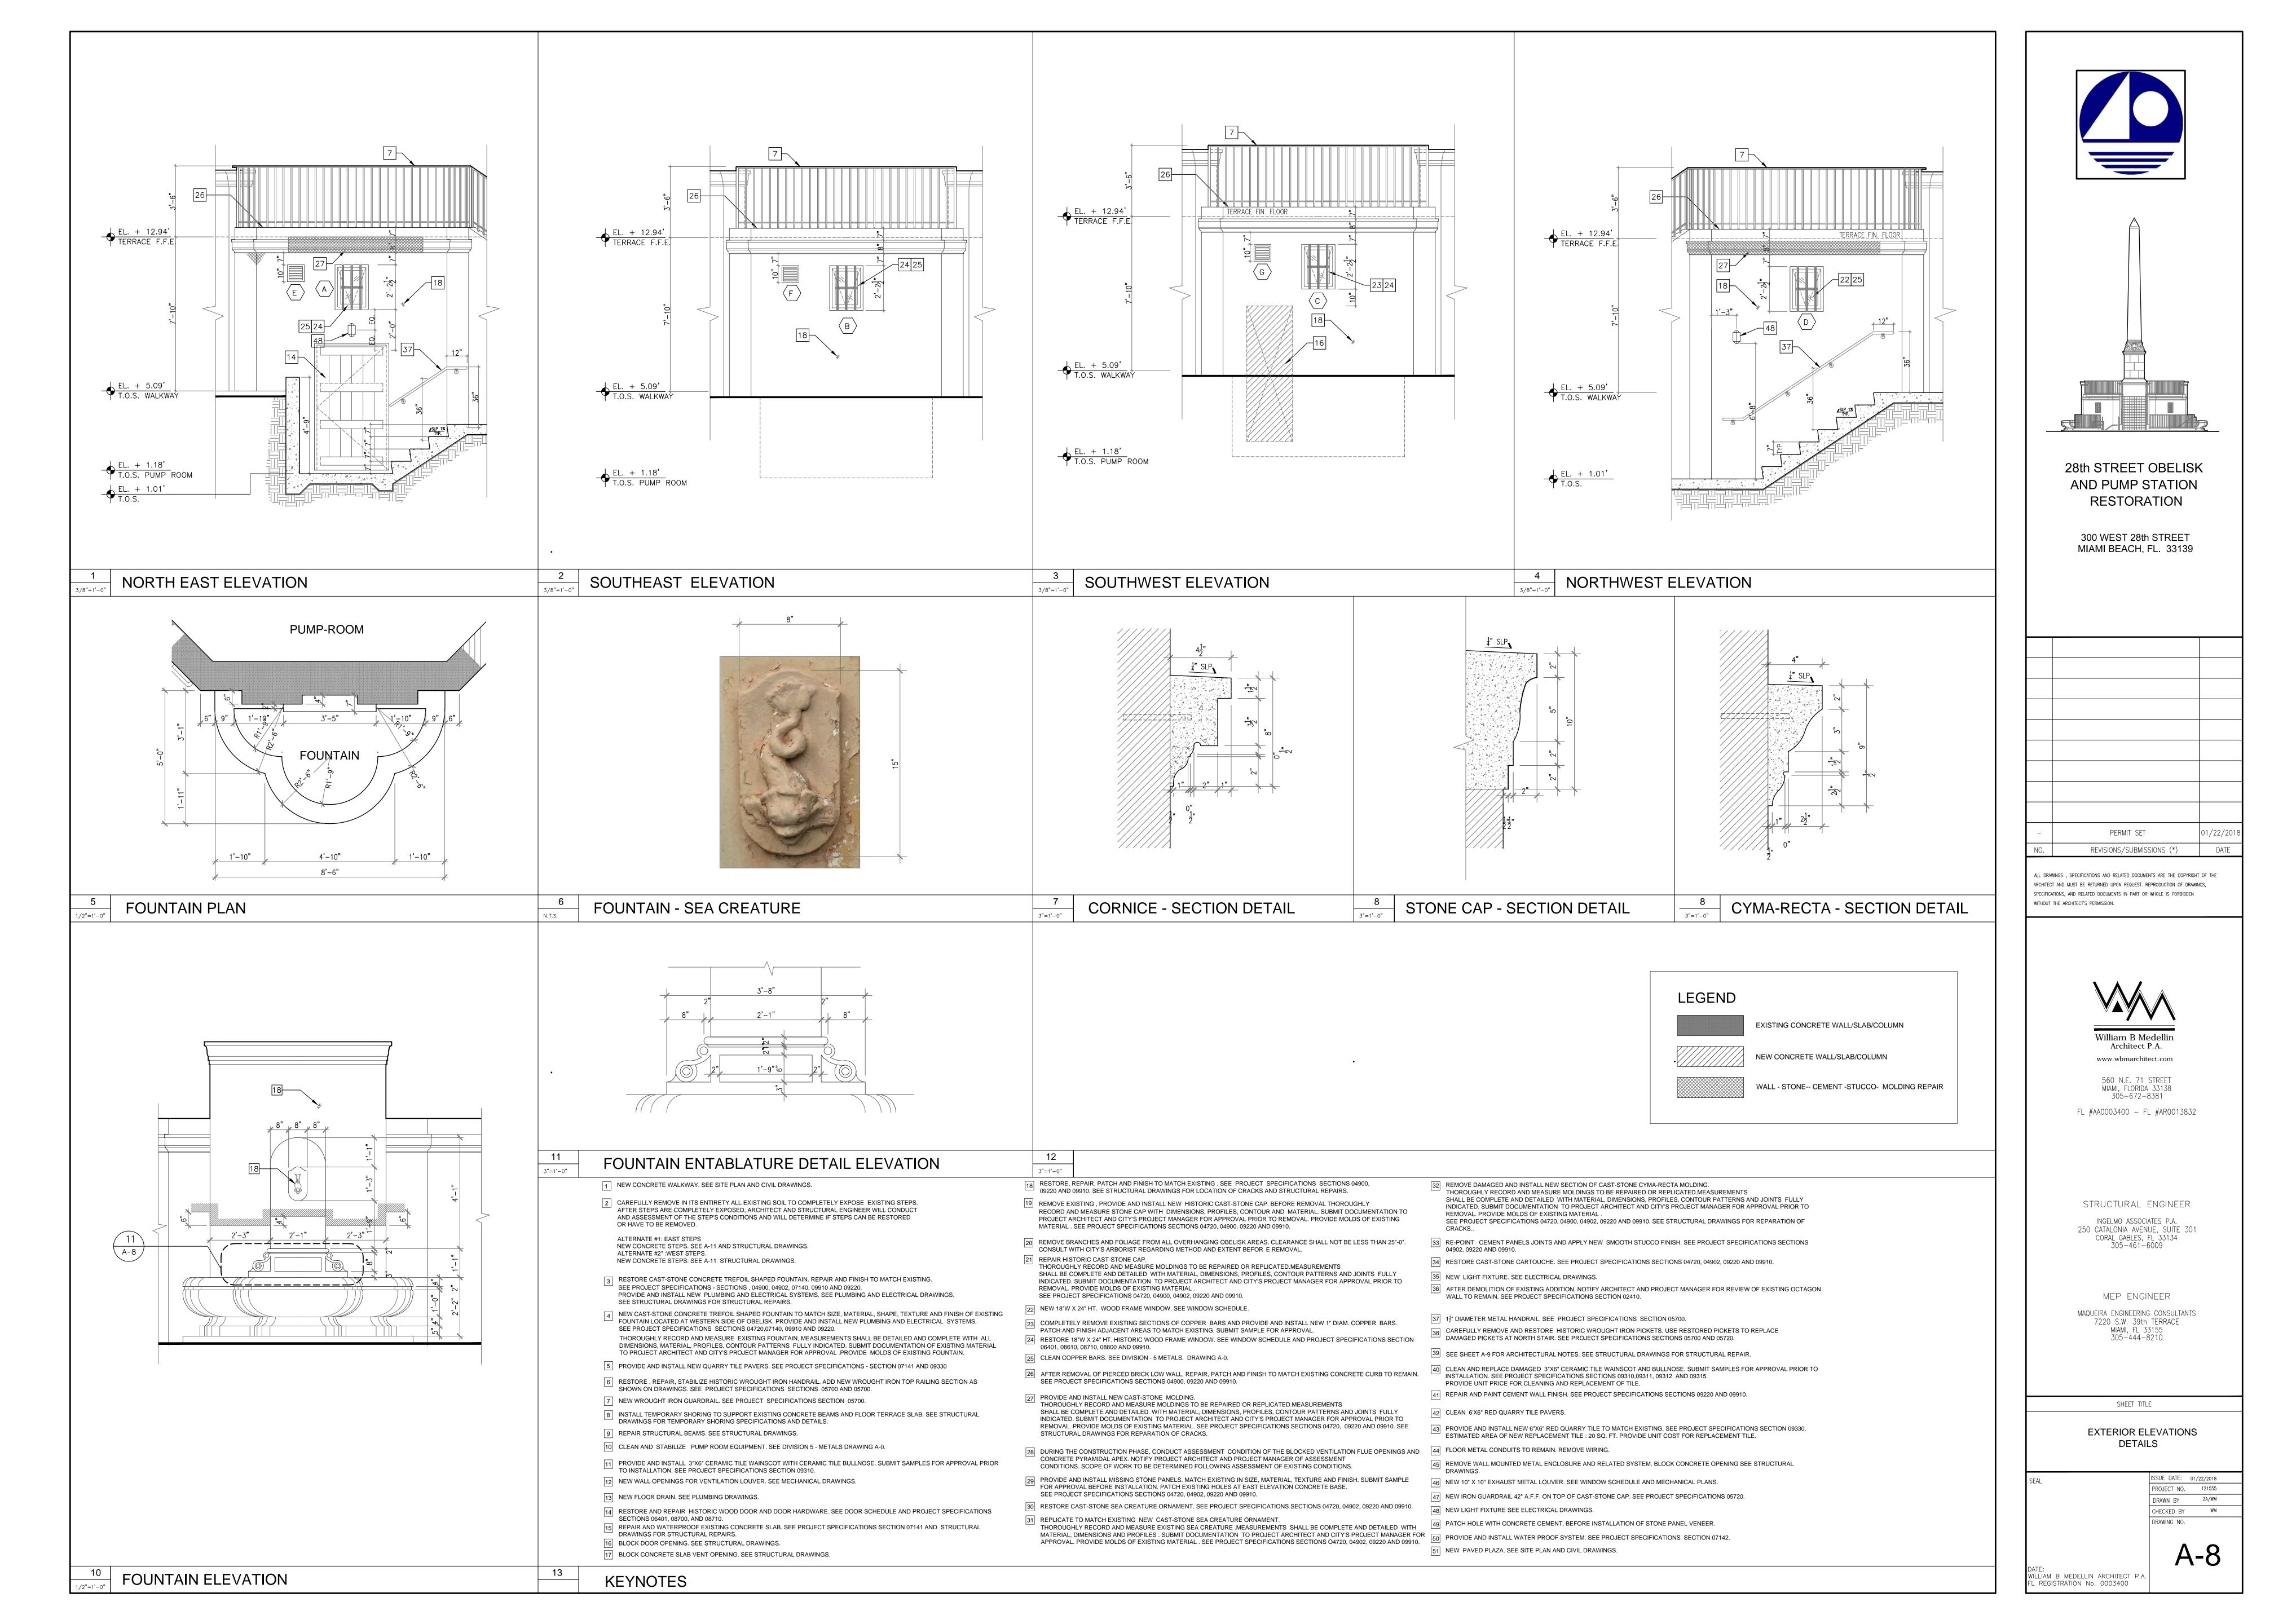
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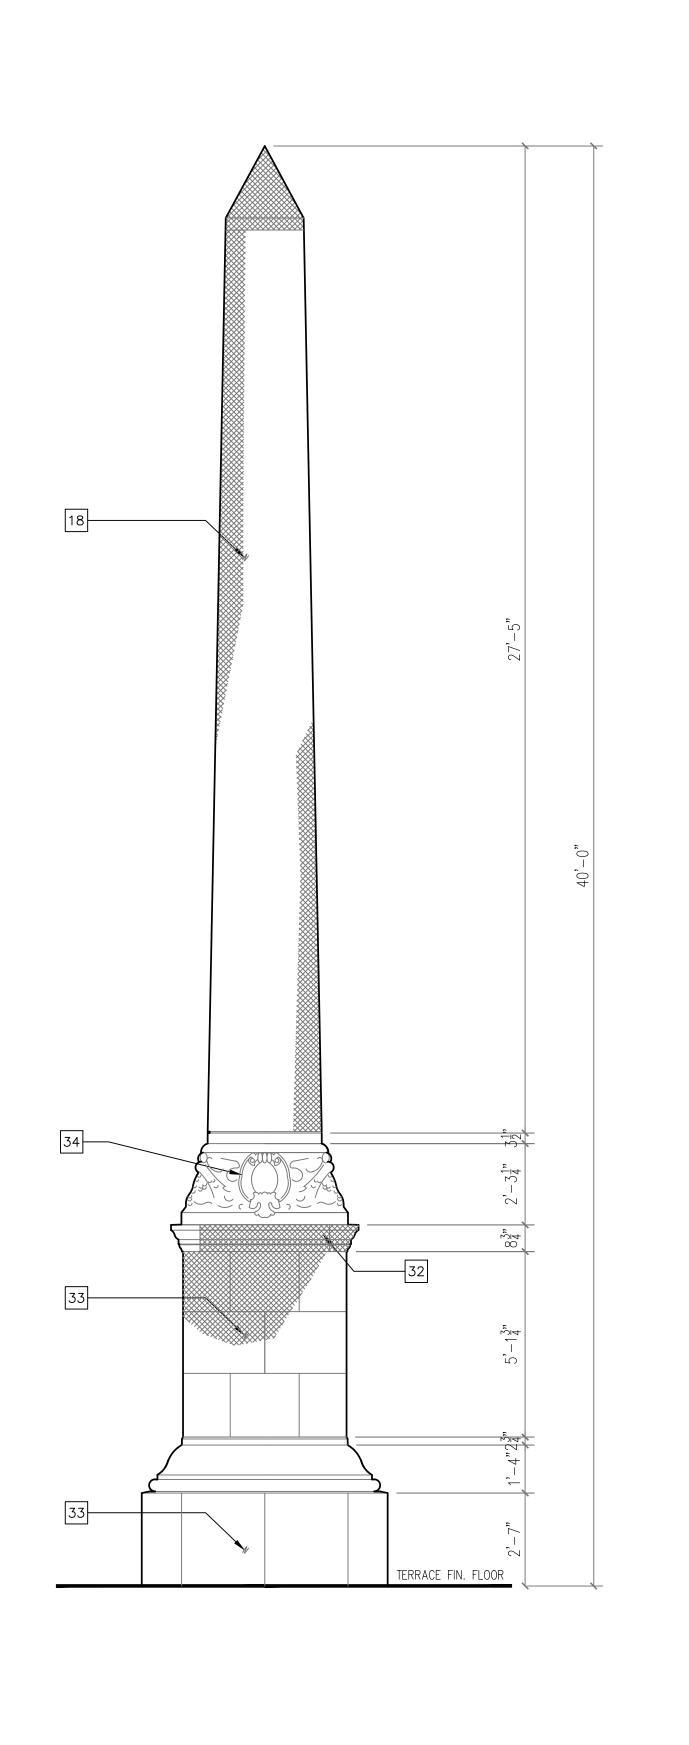
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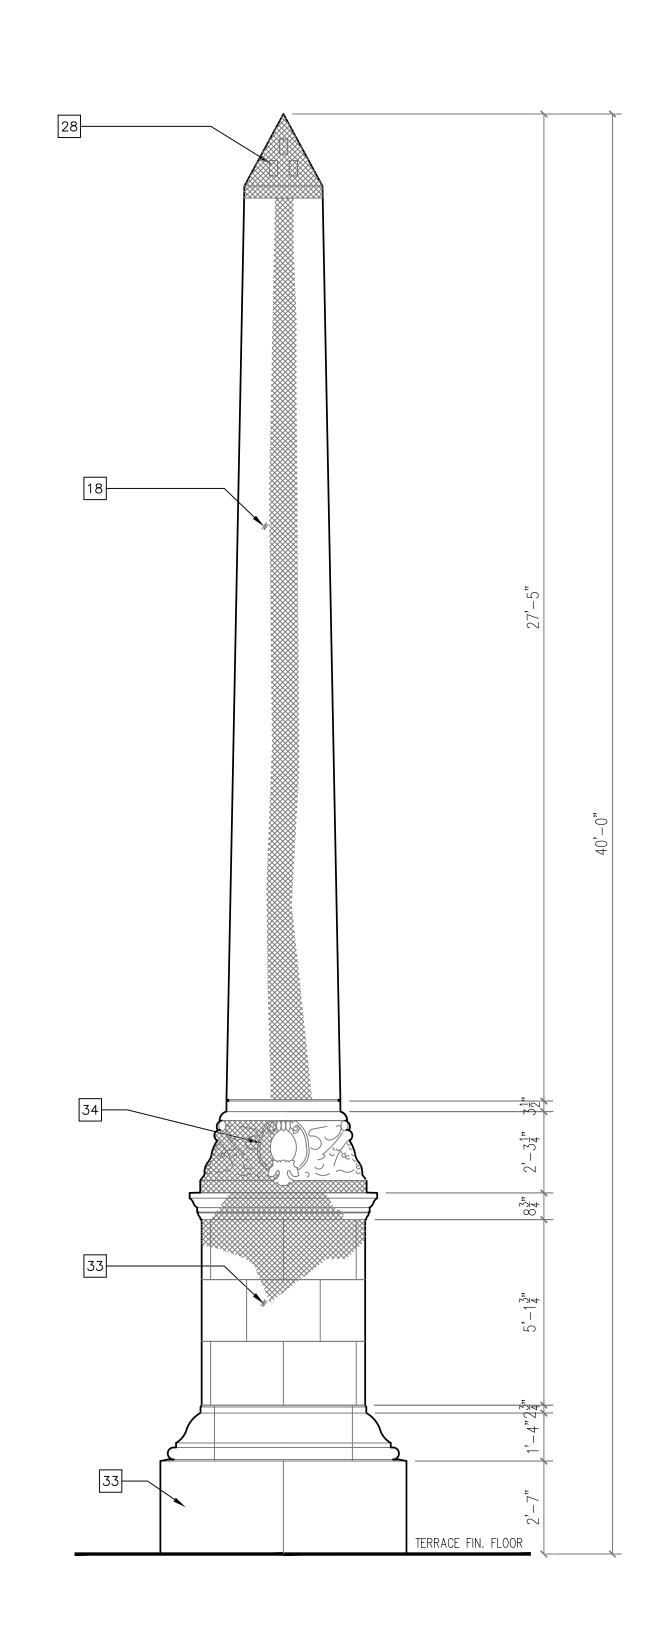
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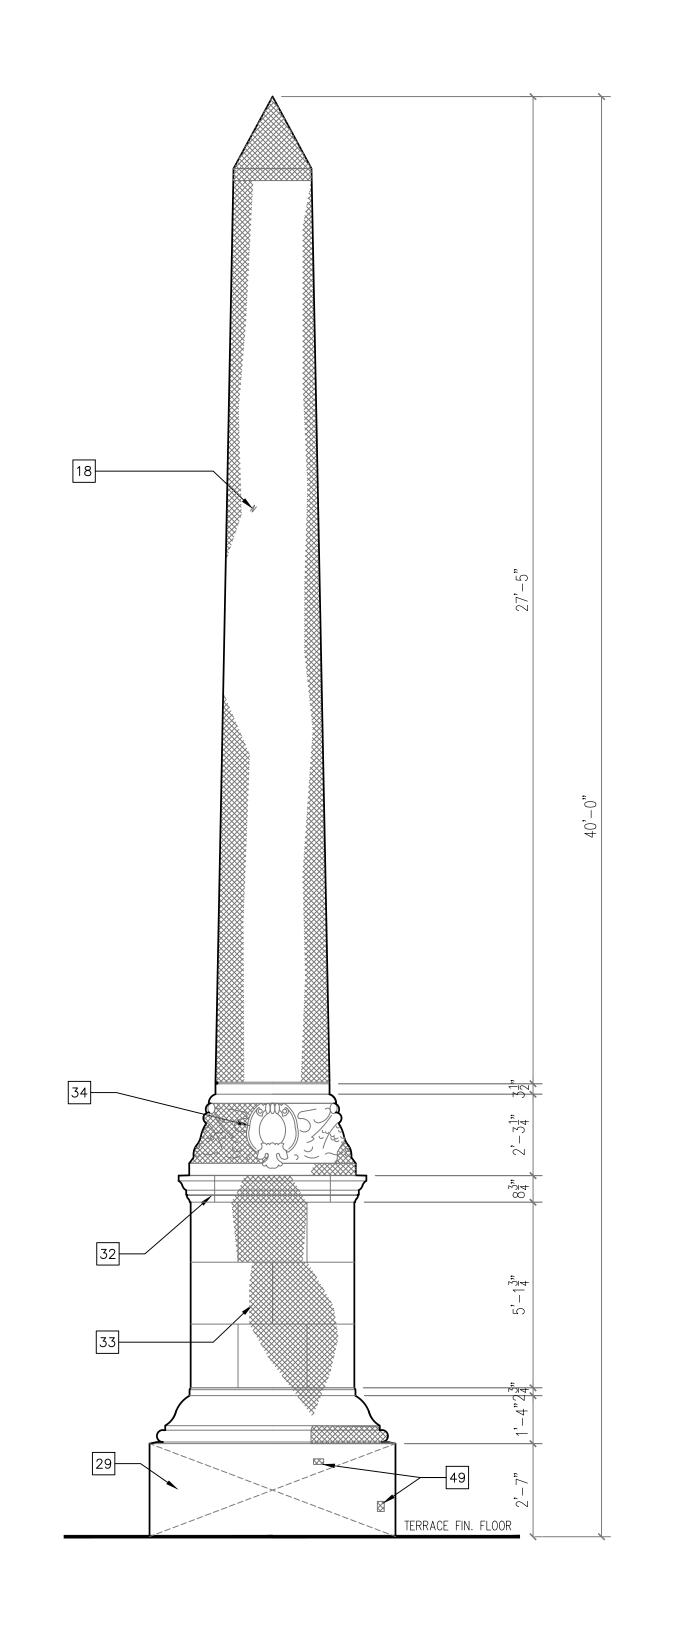



DRAWING NO.









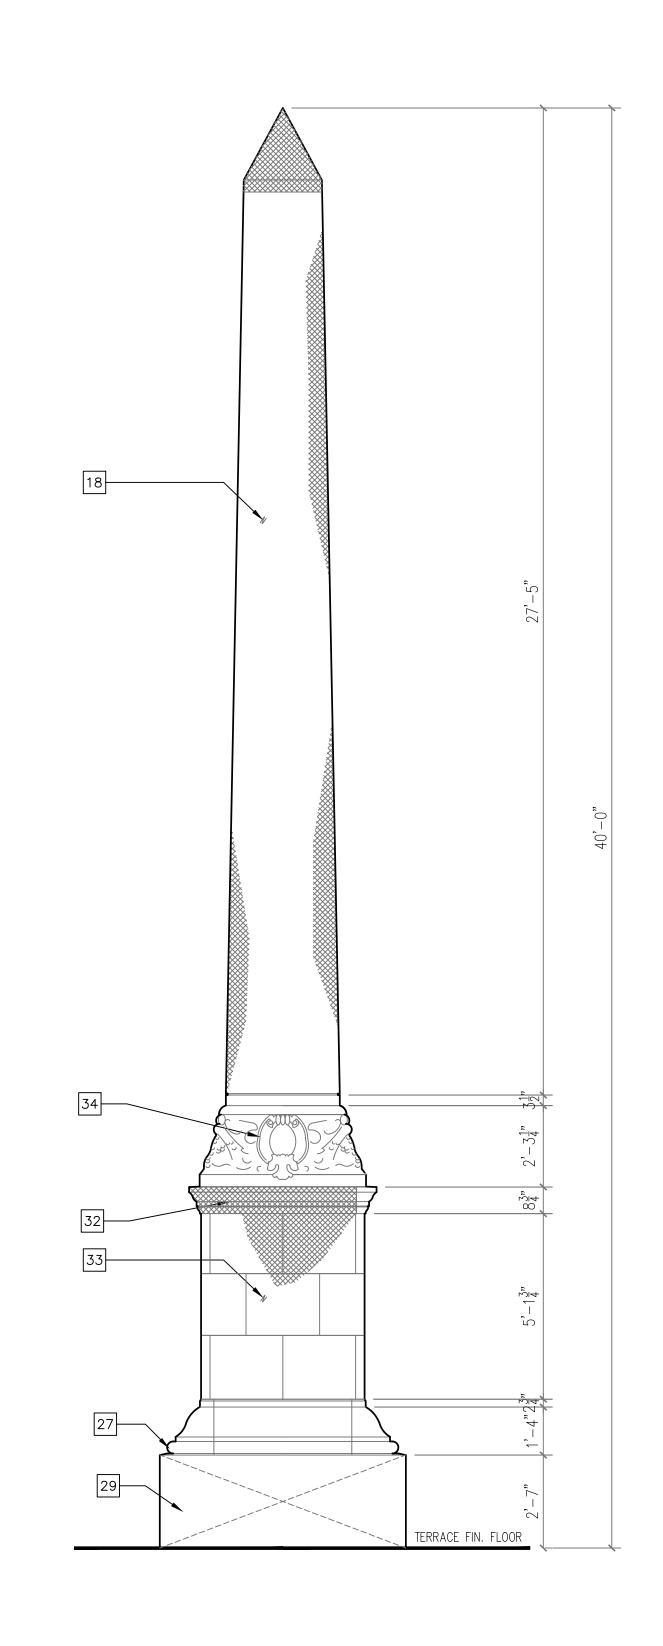



- NEW CONCRETE WALKWAY. SEE SITE PLAN AND CIVIL DRAWINGS.
- CAREFULLY REMOVE IN ITS ENTIRETY ALL EXISTING SOIL TO COMPLETELY EXPOSE EXISTING STEPS. AFTER STEPS ARE COMPLETELY EXPOSED, ARCHITECT AND STRUCTURAL ENGINEER WILL CONDUCT AND ASSESSMENT OF THE STEP'S CONDITIONS AND WILL DETERMINE IF STEPS CAN BE RESTORED OR HAVE TO BE REMOVED.
- NEW CONCRETE STEPS. SEE A-11 AND STRUCTURAL DRAWINGS. ALTERNATE #2" :WEST STEPS.

NEW CONCRETE STEPS: SEE A-11 STRUCTURAL DRAWINGS.

- RESTORE CAST-STONE CONCRETE TREFOIL SHAPED FOUNTAIN. REPAIR AND FINISH TO MATCH EXISTING. SEE PROJECT SPECIFICATIONS - SECTIONS , 04900, 04902, 07140, 09910 AND 09220. PROVIDE AND INSTALL NEW PLUMBING AND ELECTRICAL SYSTEMS. SEE PLUMBING AND ELECTRICAL DRAWINGS.
- SEE STRUCTURAL DRAWINGS FOR STRUCTURAL REPAIRS. NEW CAST-STONE CONCRETE TREFOIL SHAPED FOUNTAIN TO MATCH SIZE, MATERIAL, SHAPE, TEXTURE AND FINISH OF EXISTING FOUNTAIN LOCATED AT WESTERN SIDE OF OBELISK. PROVIDE AND INSTALL NEW PLUMBING AND ELECTRICAL SYSTEMS. SEE PROJECT SPECIFICATIONS SECTIONS 04720,07140, 09910 AND 09220. THOROUGHLY RECORD AND MEASURE EXISTING FOUNTAIN, MEASUREMENTS SHALL BE DETAILED AND COMPLETE WITH ALL DIMENSIONS, MATERIAL, PROFILES, CONTOUR PATTERNS FULLY INDICATED. SUBMIT DOCUMENTATION OF EXISTING MATERIAL
- TO PROJECT ARCHITECT AND CITY'S PROJECT MANAGER FOR APPROVAL .PROVIDE MOLDS OF EXISTING FOUNTAIN. PROVIDE AND INSTALL NEW QUARRY TILE PAVERS. SEE PROJECT SPECIFICATIONS - SECTION 07141 AND 09330
- RESTORE . REPAIR. STABILIZE HISTORIC WROUGHT IRON HANDRAIL. ADD NEW WROUGHT IRON TOP RAILING SECTION AS SHOWN ON DRAWINGS. SEE PROJECT SPECIFICATIONS SECTIONS 05700 AND 05700.
- NEW WROUGHT IRON GUARDRAIL. SEE PROJECT SPECIFICATIONS SECTION 05700.
- INSTALL TEMPORARY SHORING TO SUPPORT EXISTING CONCRETE BEAMS AND FLOOR TERRACE SLAB. SEE STRUCTURAL DRAWINGS FOR TEMPORARY SHORING SPECIFICATIONS AND DETAILS.
- 9 REPAIR STRUCTURAL BEAMS. SEE STRUCTURAL DRAWINGS.
- 10 CLEAN AND STABILIZE PUMP ROOM EQUIPMENT. SEE DIVISION 5 METALS DRAWING A-0.
- PROVIDE AND INSTALL 3"X6" CERAMIC TILE WAINSCOT WITH CERAMIC TILE BULLNOSE. SUBMIT SAMPLES FOR APPROVAL PRIOR TO INSTALLATION. SEE PROJECT SPECIFICATIONS SECTION 09310.
- NEW WALL OPENINGS FOR VENTILATION LOUVER. SEE MECHANICAL DRAWINGS.
- 13 NEW FLOOR DRAIN. SEE PLUMBING DRAWINGS.
- RESTORE AND REPAIR HISTORIC WOOD DOOR AND DOOR HARDWARE. SEE DOOR SCHEDULE AND PROJECT SPECIFICATIONS SECTIONS 06401, 08700, AND 08710.
- REPAIR AND WATERPROOF EXISTING CONCRETE SLAB. SEE PROJECT SPECIFICATIONS SECTION 07141 AND STRUCTURAL DRAWINGS FOR STRUCTURAL REPAIRS.
- 6 BLOCK DOOR OPENING. SEE STRUCTURAL DRAWINGS.
- 7 BLOCK CONCRETE SLAB VENT OPENING. SEE STRUCTURAL DRAWINGS.

EAST ELEVATION

- RESTORE, REPAIR, PATCH AND FINISH TO MATCH EXISTING . SEE PROJECT SPECIFICATIONS SECTIONS 04900, 09220 AND 09910. SEE STRUCTURAL DRAWINGS FOR LOCATION OF CRACKS AND STRUCTURAL REPAIRS.
- 19 REMOVE EXISTING, PROVIDE AND INSTALL NEW HISTORIC CAST-STONE CAP. BEFORE REMOVAL THOROUGHLY RECORD AND MEASURE STONE CAP WITH DIMENSIONS, PROFILES, CONTOUR AND MATERIAL. SUBMIT DOCUMENTATION TO PROJECT ARCHITECT AND CITY'S PROJECT MANAGER FOR APPROVAL PRIOR TO REMOVAL. PROVIDE MOLDS OF EXISTING MATERIAL . SEE PROJECT SPECIFICATIONS SECTIONS 04720, 04900, 09220 AND 09910.
- REMOVE BRANCHES AND FOLIAGE FROM ALL OVERHANGING OBELISK AREAS. CLEARANCE SHALL NOT BE LESS THAN 25"-0". CONSULT WITH CITY'S ARBORIST REGARDING METHOD AND EXTENT BEFOR E REMOVAL.
- REPAIR HISTORIC CAST-STONE CAP. THOROUGHLY RECORD AND MEASURE MOLDINGS TO BE REPAIRED OR REPLICATED.MEASUREMENTS SHALL BE COMPLETE AND DETAILED WITH MATERIAL, DIMENSIONS, PROFILES, CONTOUR PATTERNS AND JOINTS FULLY INDICATED. SUBMIT DOCUMENTATION TO PROJECT ARCHITECT AND CITY'S PROJECT MANAGER FOR APPROVAL PRIOR TO REMOVAL. PROVIDE MOLDS OF EXISTING MATERIAL.
- SEE PROJECT SPECIFICATIONS 04720, 04900, 04902, 09220 AND 09910. 22 NEW 18"W X 24" HT. WOOD FRAME WINDOW. SEE WINDOW SCHEDULE.
- 23 COMPLETELY REMOVE EXISTING SECTIONS OF COPPER BARS AND PROVIDE AND INSTALL NEW 1" DIAM. COPPER BARS. PATCH AND FINISH ADJACENT AREAS TO MATCH EXISTING. SUBMIT SAMPLE FOR APPROVAL.
- 24 RESTORE 18"W X 24" HT. HISTORIC WOOD FRAME WINDOW. SEE WINDOW SCHEDULE AND PROJECT SPECIFICATIONS SECTION 06401, 08610, 08710, 08800 AND 09910.
- 25 CLEAN COPPER BARS. SEE DIVISION 5 METALS. DRAWING A-0.

STRUCTURAL DRAWINGS FOR REPARATION OF CRACKS.

- 26 AFTER REMOVAL OF PIERCED BRICK LOW WALL, REPAIR, PATCH AND FINISH TO MATCH EXISTING CONCRETE CURB TO REMAIN. SEE PROJECT SPECIFICATIONS SECTIONS 04900, 09220 AND 09910.
- 27 PROVIDE AND INSTALL NEW CAST-STONE MOLDING. THOROUGHLY RECORD AND MEASURE MOLDINGS TO BE REPAIRED OR REPLICATED.MEASUREMENTS SHALL BE COMPLETE AND DETAILED WITH MATERIAL, DIMENSIONS, PROFILES, CONTOUR PATTERNS AND JOINTS FULLY INDICATED. SUBMIT DOCUMENTATION TO PROJECT ARCHITECT AND CITY'S PROJECT MANAGER FOR APPROVAL PRIOR TO
- DURING THE CONSTRUCTION PHASE, CONDUCT ASSESSMENT CONDITION OF THE BLOCKED VENTILATION FLUE OPENINGS AND 44 FLOOR METAL CONDUITS TO REMAIN. REMOVE WIRING. CONCRETE PYRAMIDAL APEX. NOTIFY PROJECT ARCHITECT AND PROJECT MANAGER OF ASSESSMENT CONDITIONS. SCOPE OF WORK TO BE DETERMINED FOLLOWING ASSESSMENT OF EXISTING CONDITIONS.

REMOVAL. PROVIDE MOLDS OF EXISTING MATERIAL. SEE PROJECT SPECIFICATIONS SECTIONS 04720, 09220 AND 09910. SEE

- PROVIDE AND INSTALL MISSING STONE PANELS. MATCH EXISTING IN SIZE, MATERIAL, TEXTURE AND FINISH. SUBMIT SAMPLE FOR APPROVAL BEFORE INSTALLATION. PATCH EXISTING HOLES AT EAST ELEVATION CONCRETE BASE. SEE PROJECT SPECIFICATIONS SECTIONS 04720, 04902, 09220 AND 09910.
- 30 RESTORE CAST-STONE SEA CREATURE ORNAMENT. SEE PROJECT SPECIFICATIONS SECTIONS 04720, 04902, 09220 AND 09910.
- 31 REPLICATE TO MATCH EXISTING NEW CAST-STONE SEA CREATURE ORNAMENT. THOROUGHLY RECORD AND MEASURE EXISTING SEA CREATURE .MEASUREMENTS SHALL BE COMPLETE AND DETAILED WITH MATERIAL, DIMENSIONS AND PROFILES . SUBMIT DOCUMENTATION TO PROJECT ARCHITECT AND CITY'S PROJECT MANAGER FOR APPROVAL. PROVIDE MOLDS OF EXISTING MATERIAL . SEE PROJECT SPECIFICATIONS SECTIONS 04720, 04902, 09220 AND 09910.

SOUTH ELEVATION

- 32 REMOVE DAMAGED AND INSTALL NEW SECTION OF CAST-STONE CYMA-RECTA MOLDING. THOROUGHLY RECORD AND MEASURE MOLDINGS TO BE REPAIRED OR REPLICATED.MEASUREMENTS SHALL BE COMPLETE AND DETAILED WITH MATERIAL, DIMENSIONS, PROFILES, CONTOUR PATTERNS AND JOINTS FULLY INDICATED. SUBMIT DOCUMENTATION TO PROJECT ARCHITECT AND CITY'S PROJECT MANAGER FOR APPROVAL PRIOR TO REMOVAL. PROVIDE MOLDS OF EXISTING MATERIAL. SEE PROJECT SPECIFICATIONS 04720, 04900, 04902, 09220 AND 09910. SEE STRUCTURAL DRAWINGS FOR REPARATION OF
- RE-POINT CEMENT PANELS JOINTS AND APPLY NEW SMOOTH STUCCO FINISH. SEE PROJECT SPECIFICATIONS SECTIONS
- RESTORE CAST-STONE CARTOUCHE. SEE PROJECT SPECIFICATIONS SECTIONS 04720, 04902, 09220 AND 09910.
- 35 NEW LIGHT FIXTURE. SEE ELECTRICAL DRAWINGS.
- 36 AFTER DEMOLITION OF EXISTING ADDITION, NOTIFY ARCHITECT AND PROJECT MANAGER FOR REVIEW OF EXISTING OCTAGON WALL TO REMAIN. SEE PROJECT SPECIFICATIONS SECTION 02410.
- $1\frac{1}{2}$ " DIAMETER METAL HANDRAIL. SEE PROJECT SPECIFICATIONS SECTION 05700.
- CAREFULLY REMOVE AND RESTORE HISTORIC WROUGHT IRON PICKETS. USE RESTORED PICKETS TO REPLACE DAMAGED PICKETS AT NORTH STAIR. SEE PROJECT SPECIFICATIONS SECTIONS 05700 AND 05720.
- 39 SEE SHEET A-9 FOR ARCHITECTURAL NOTES. SEE STRUCTURAL DRAWINGS FOR STRUCTURAL REPAIR.
- 40 CLEAN AND REPLACE DAMAGED 3"X6" CERAMIC TILE WAINSCOT AND BULLNOSE. SUBMIT SAMPLES FOR APPROVAL PRIOR TO
- INSTALLATION. SEE PROJECT SPECIFICATIONS SECTIONS 09310,09311, 09312 AND 09315. PROVIDE UNIT PRICE FOR CLEANING AND REPLACEMENT OF TILE.
- 41 REPAIR AND PAINT CEMENT WALL FINISH. SEE PROJECT SPECIFICATIONS SECTIONS 09220 AND 09910.
- 42 CLEAN 6'X6" RED QUARRY TILE PAVERS.
- PROVIDE AND INSTALL NEW 6"X6" RED QUARRY TILE TO MATCH EXISTING. SEE PROJECT SPECIFICATIONS SECTION 09330. ESTIMATED AREA OF NEW REPLACEMENT TILE: 20 SQ. FT. PROVIDE UNIT COST FOR REPLACEMENT TILE.
- REMOVE WALL MOUNTED METAL ENCLOSURE AND RELATED SYSTEM. BLOCK CONCRETE OPENING SEE STRUCTURAL DRAWINGS.
- NEW 10" X 10" EXHAUST METAL LOUVER. SEE WINDOW SCHEDULE AND MECHANICAL PLANS.
- NEW IRON GUARDRAIL 42" A.F.F. ON TOP OF CAST-STONE CAP. SEE PROJECT SPECIFICATIONS 05720.
- 48 NEW LIGHT FIXTURE SEE ELECTRICAL DRAWINGS.
- PATCH HOLE WITH CONCRETE CEMENT, BEFORE INSTALLATION OF STONE PANEL VENEER. provide and install water proof system. See project specifications. Section 07142.
- 51 NEW PAVED PLAZA. SEE SITE PLAN AND CIVIL DRAWINGS.

—⁴ WEST ELEVATION





WEST ELEVATION

NORTH ELEVATION


CYMA - RECTA MOLDING

LEGEND



EXISTING CONCRETE WALL/SLAB/COLUMN

NEW CONCRETE WALL/SLAB/COLUMN

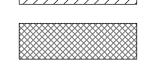



WALL - STONE-- CEMENT -STUCCO- MOLDING REPAIR

CHECKED BY WM DRAWING NO.

28th STREET OBELISK

AND PUMP STATION

RESTORATION

300 WEST 28th STREET MIAMI BEACH, FL. 33139

PERMIT SET

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7220 S.W. 39th TERRACE

MIAMI, FL 33155

305-444-8210

SHEET TITLE

OBELISK ELEVATIONS

ISSUE DATE: 01/22/2018

PROJECT NO. 121555


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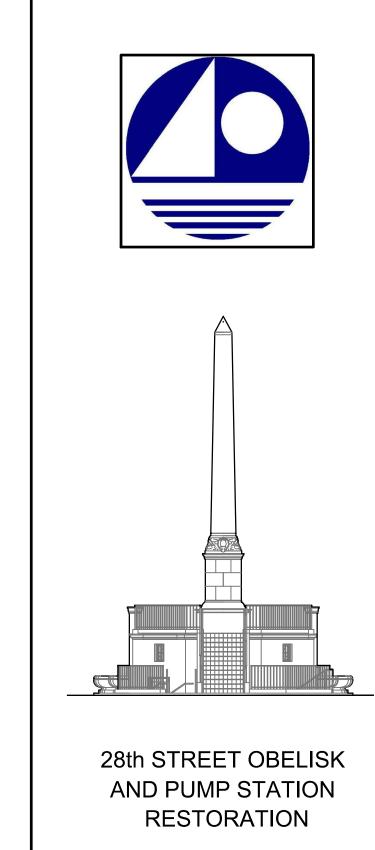
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REVISIONS/SUBMISSIONS (*)


WILLIAM B MEDELLIN ARCHITECT P.A. REGISTRATION No. 0003400

KEYNOTES



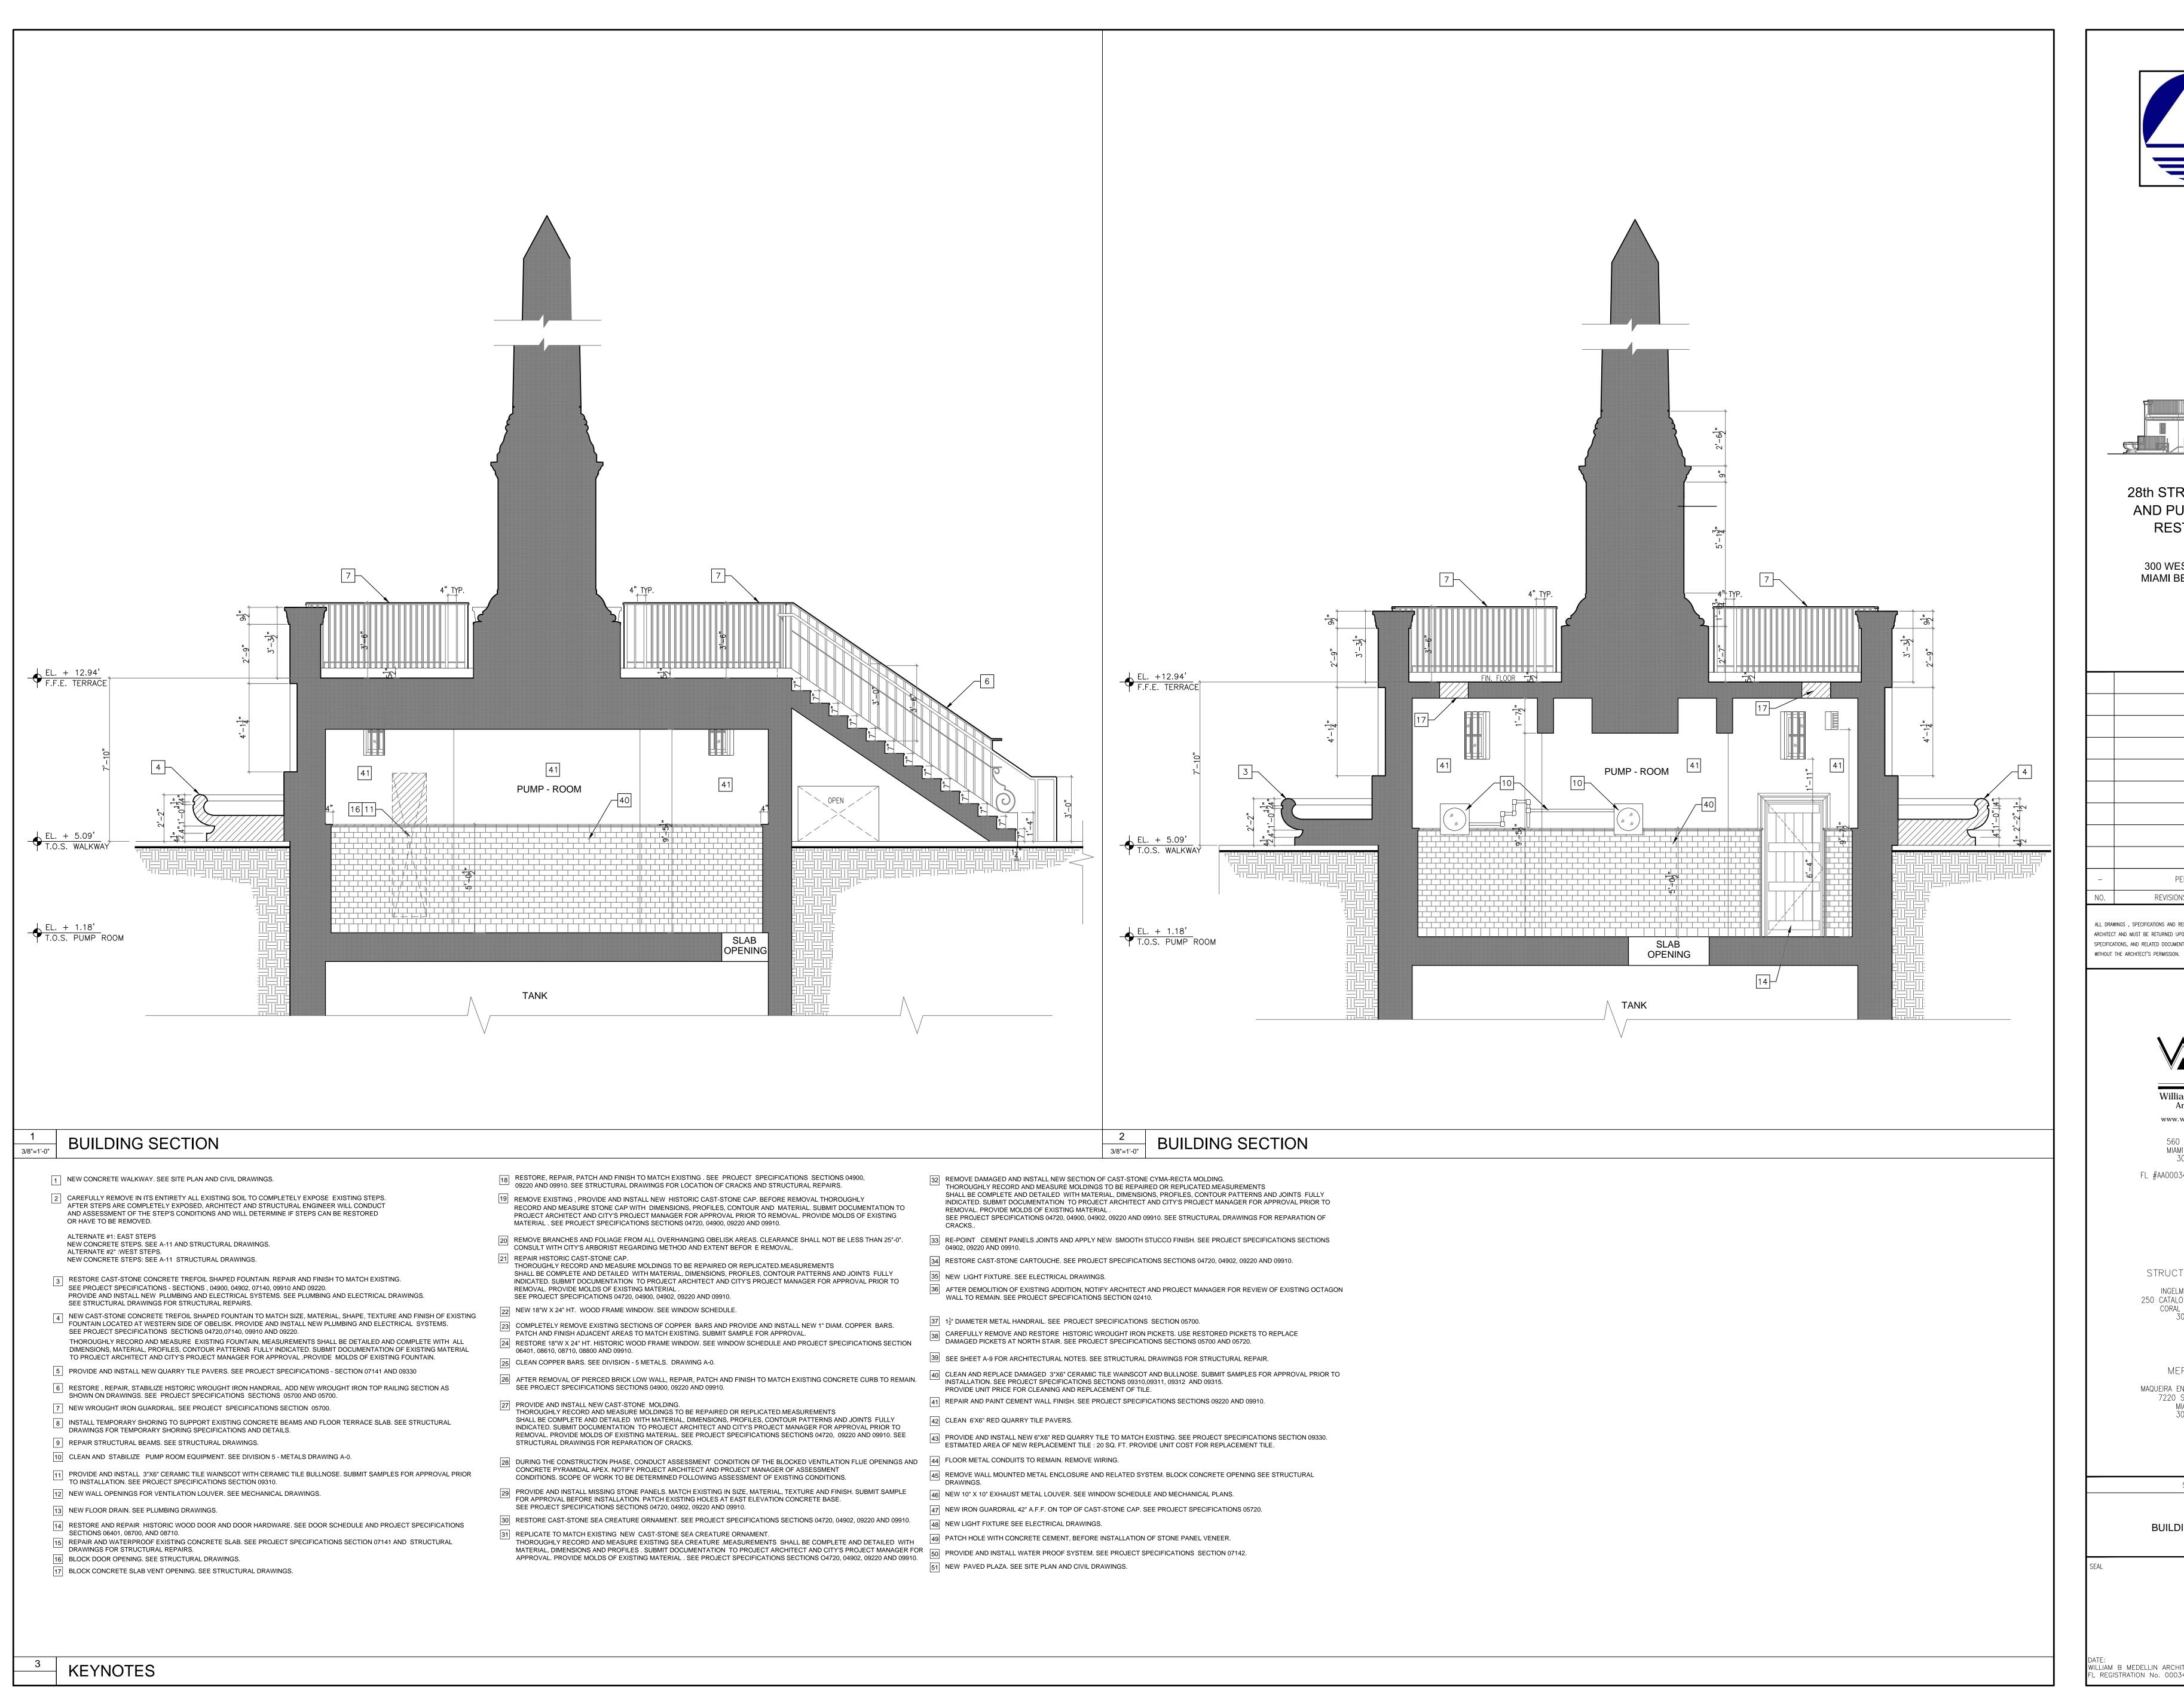

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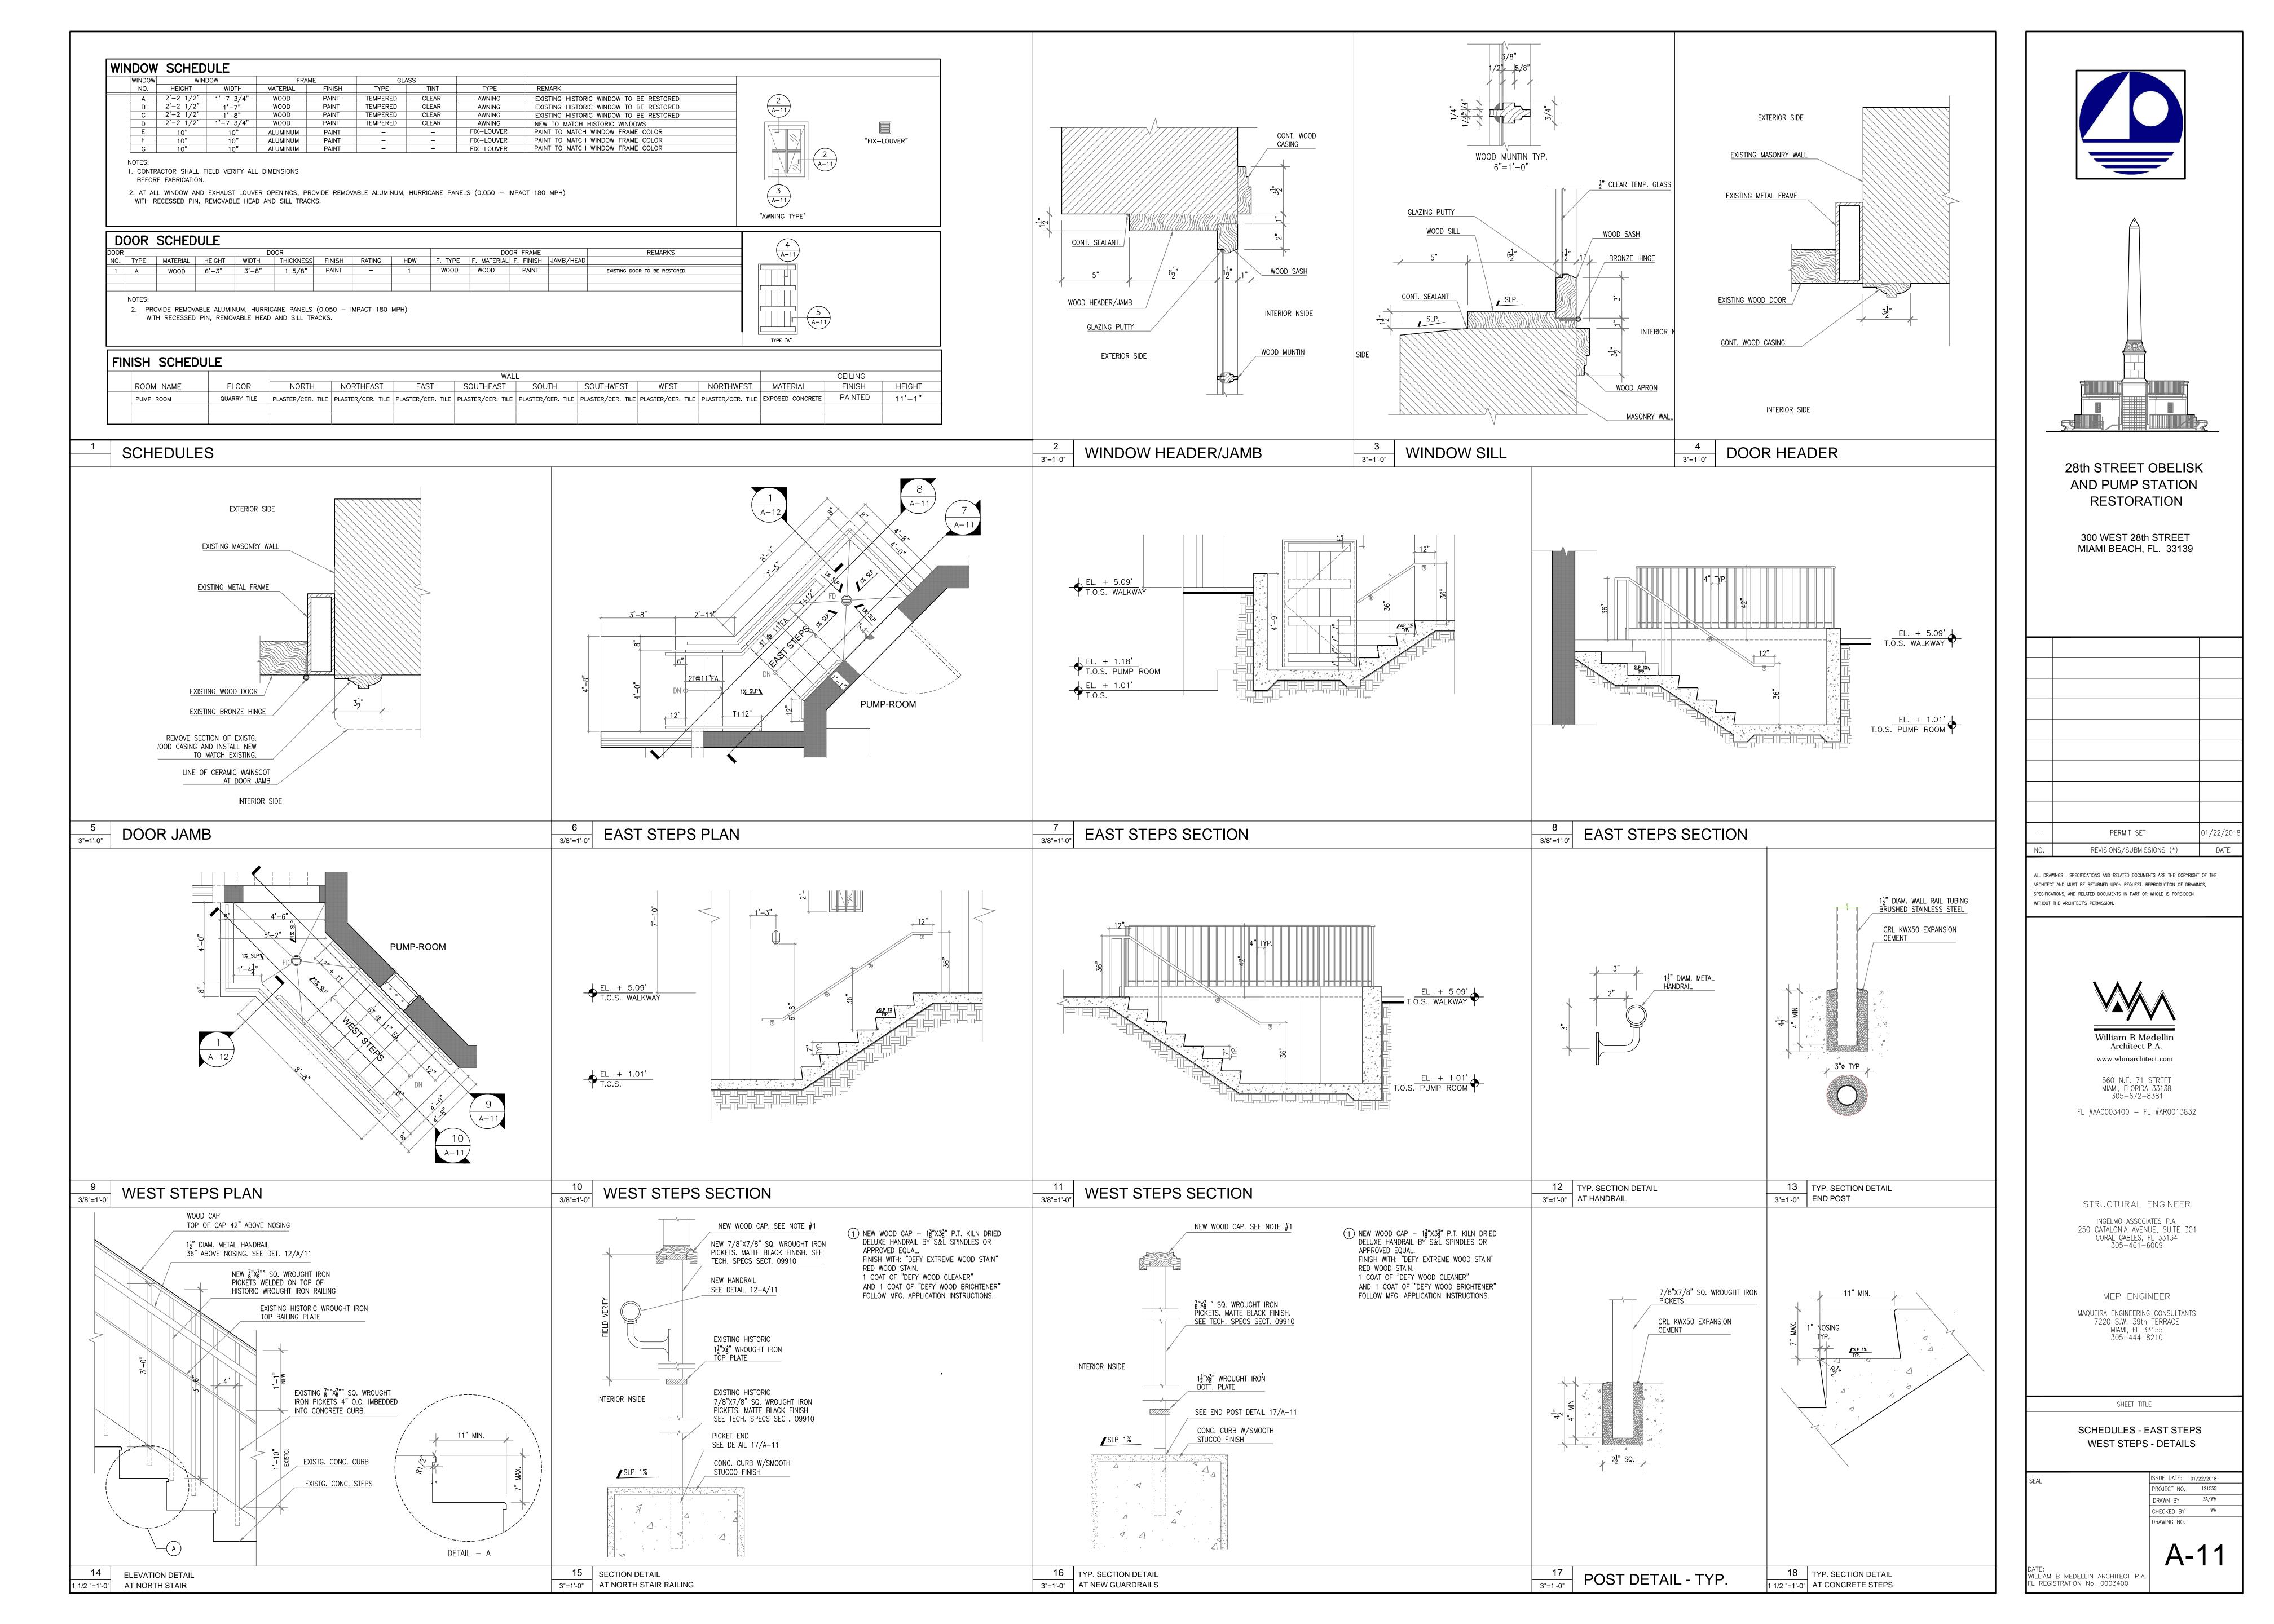
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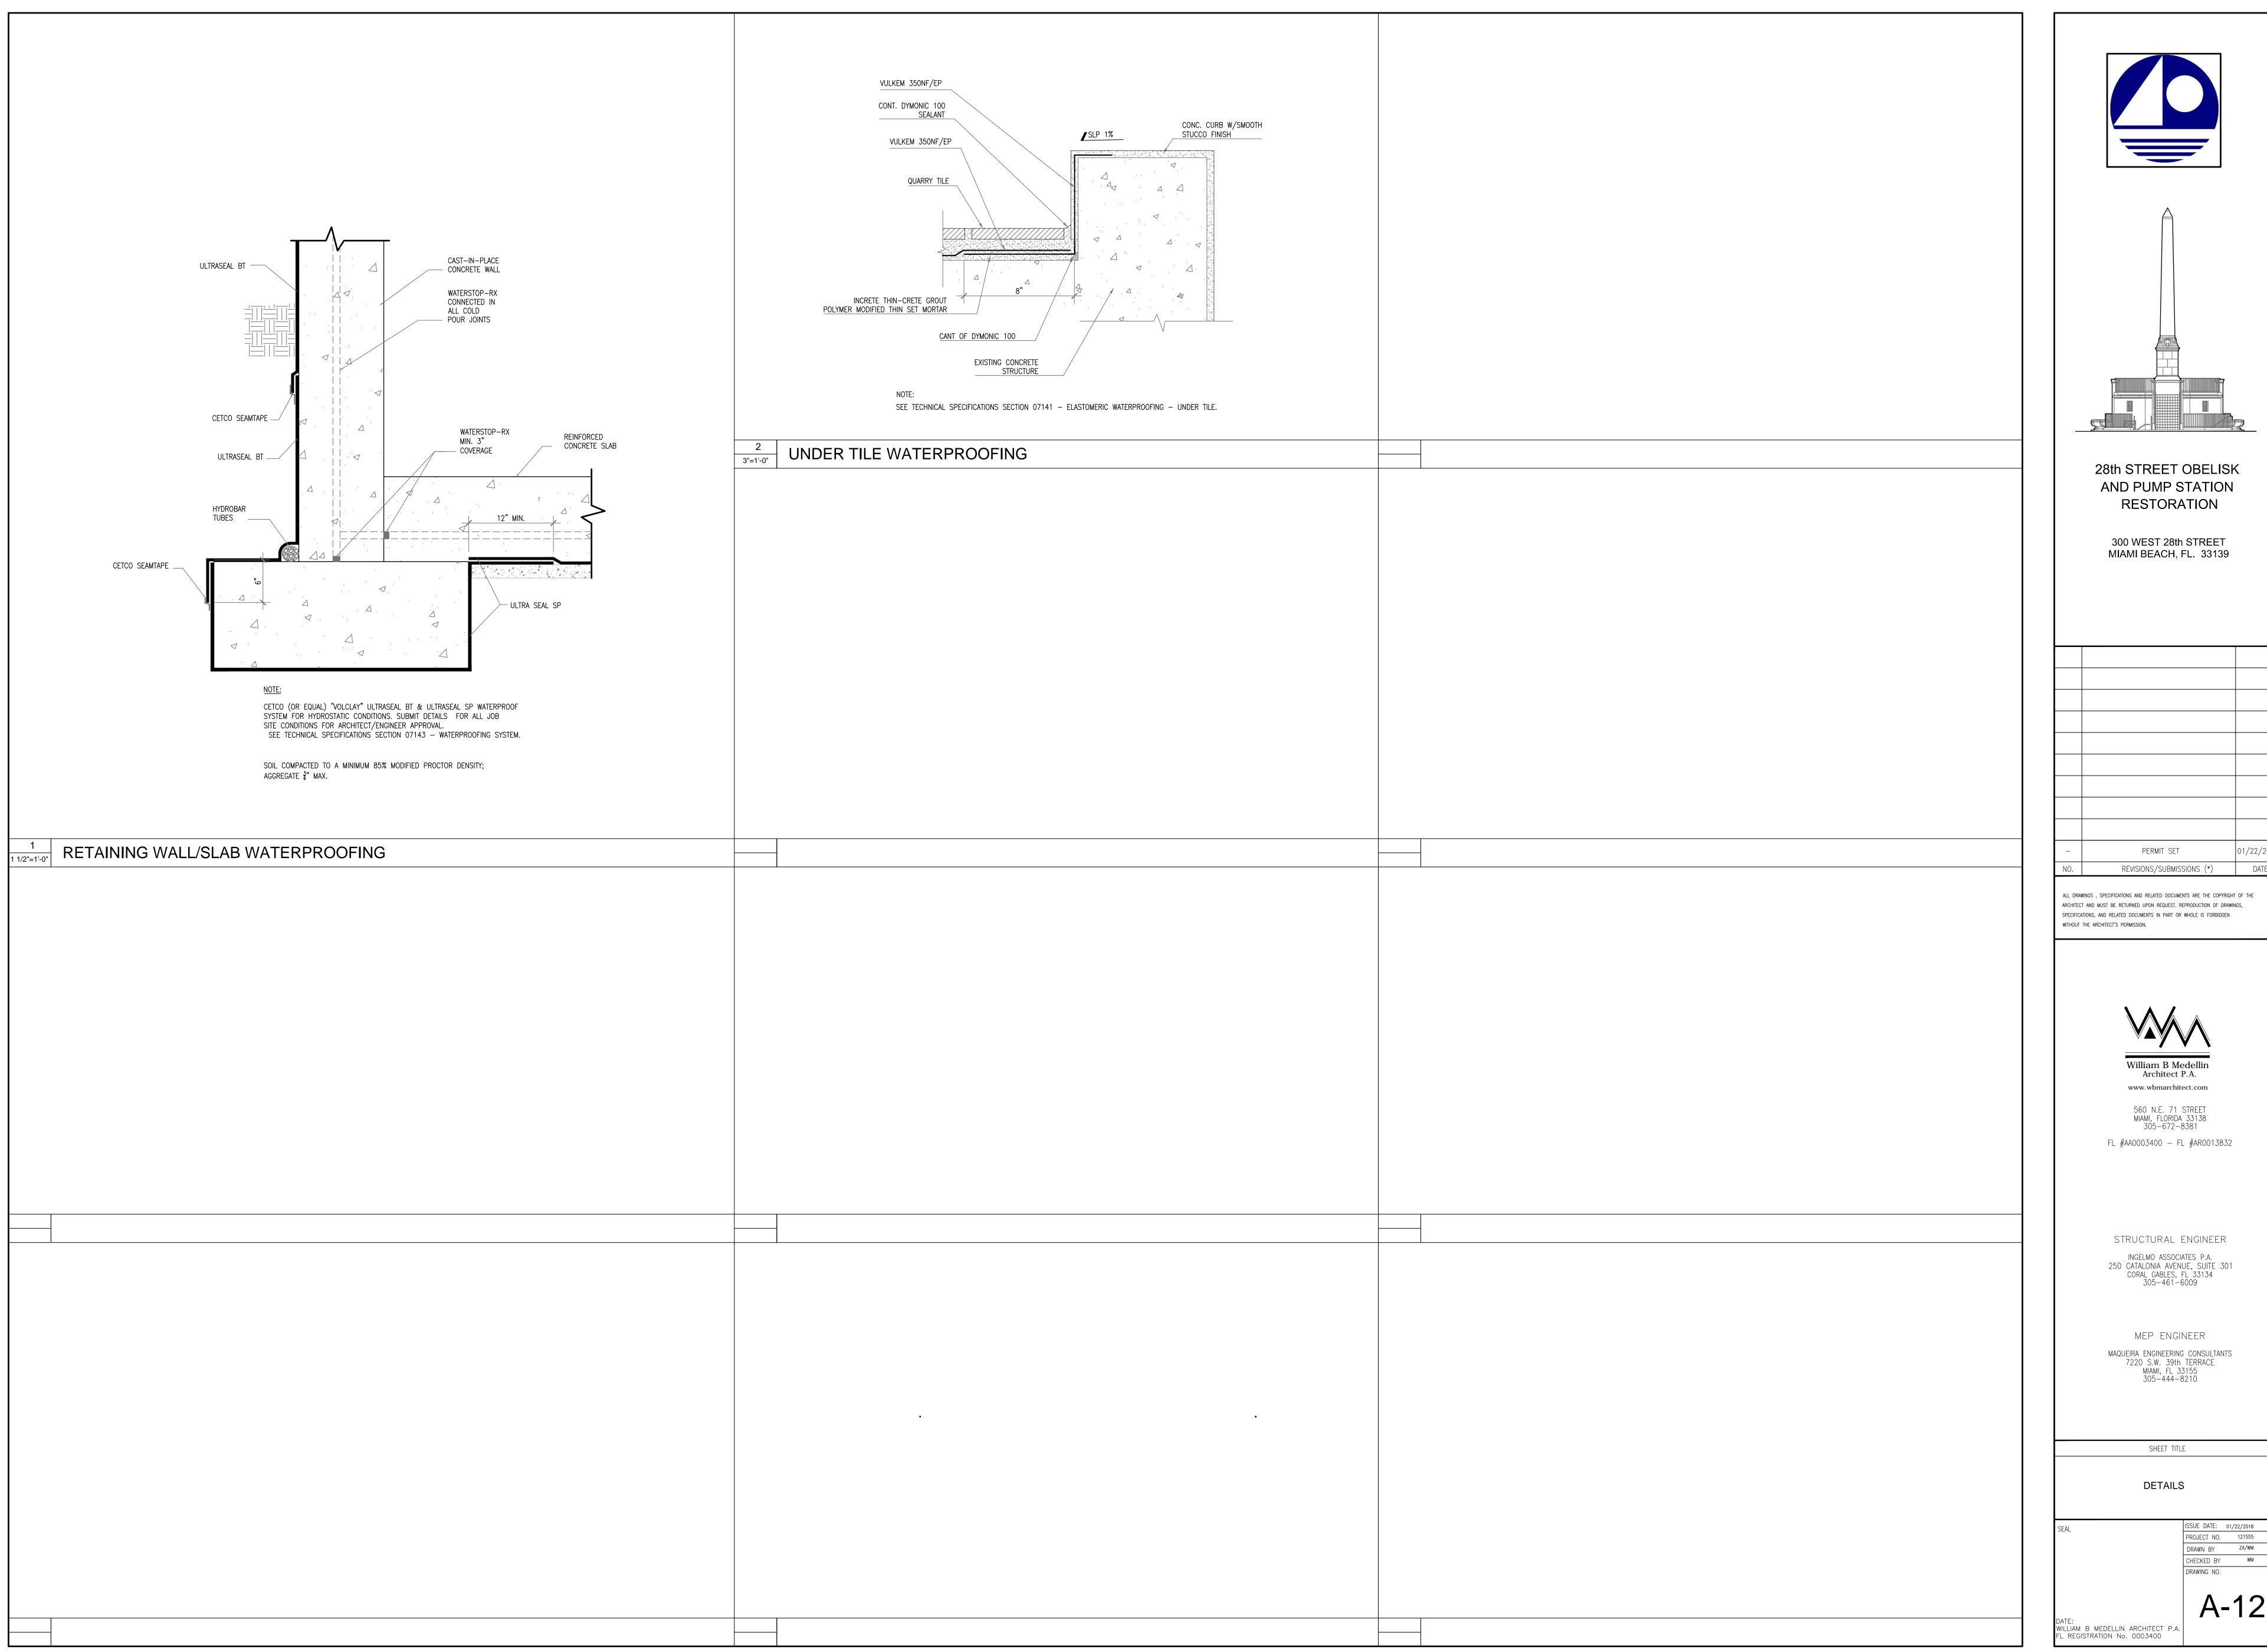
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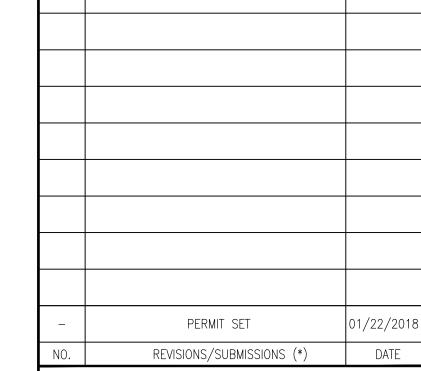
BUILDING SECTIONS

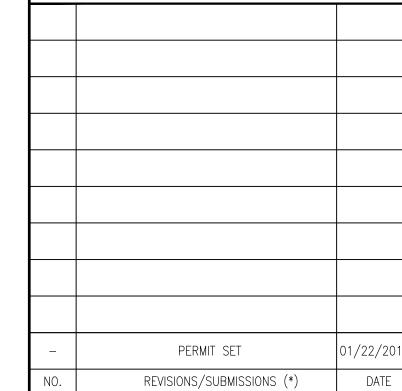
ISSUE DATE: 01/22/2018 PROJECT NO. 121555 DRAWN BY ZA/WM CHECKED BY WM


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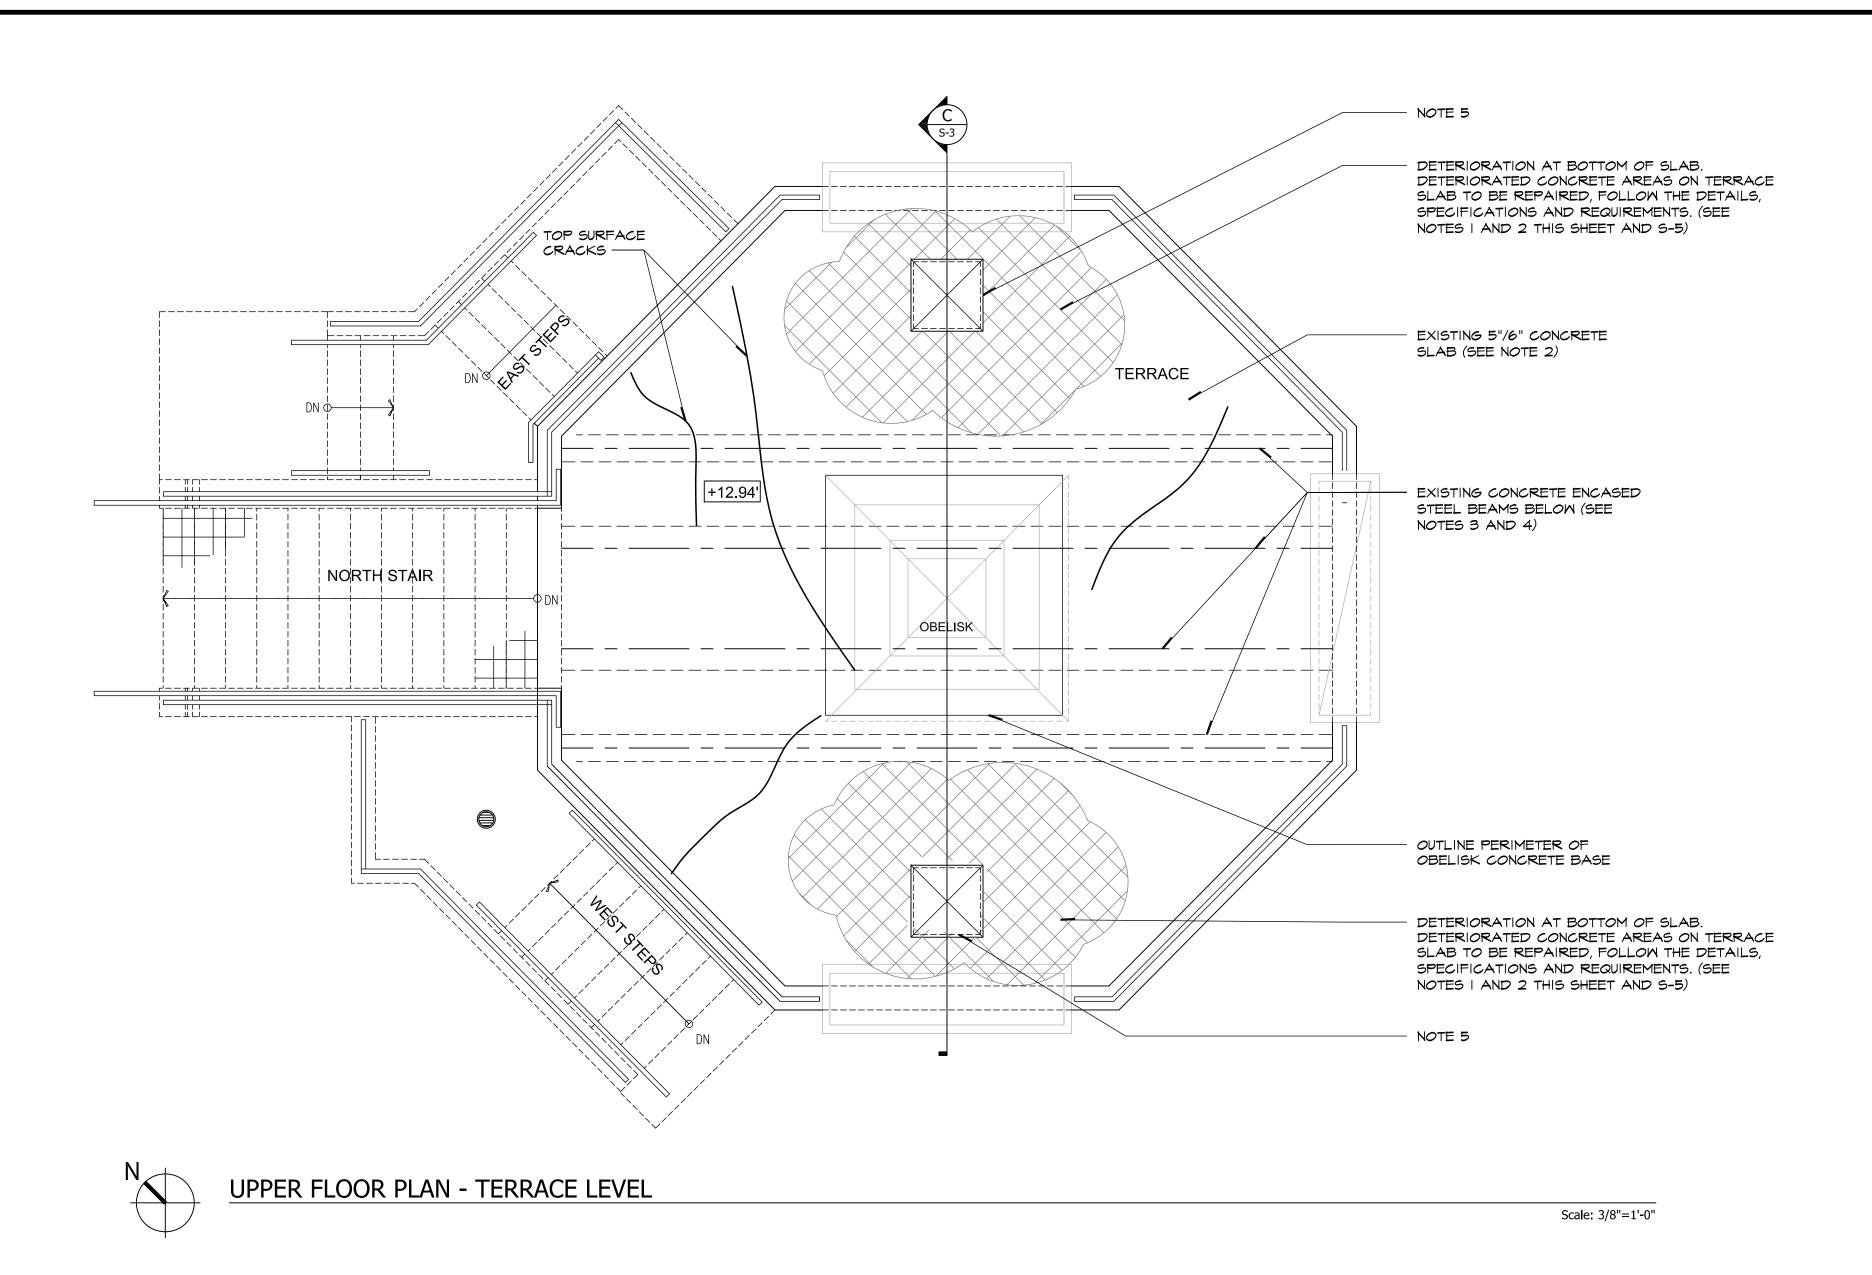









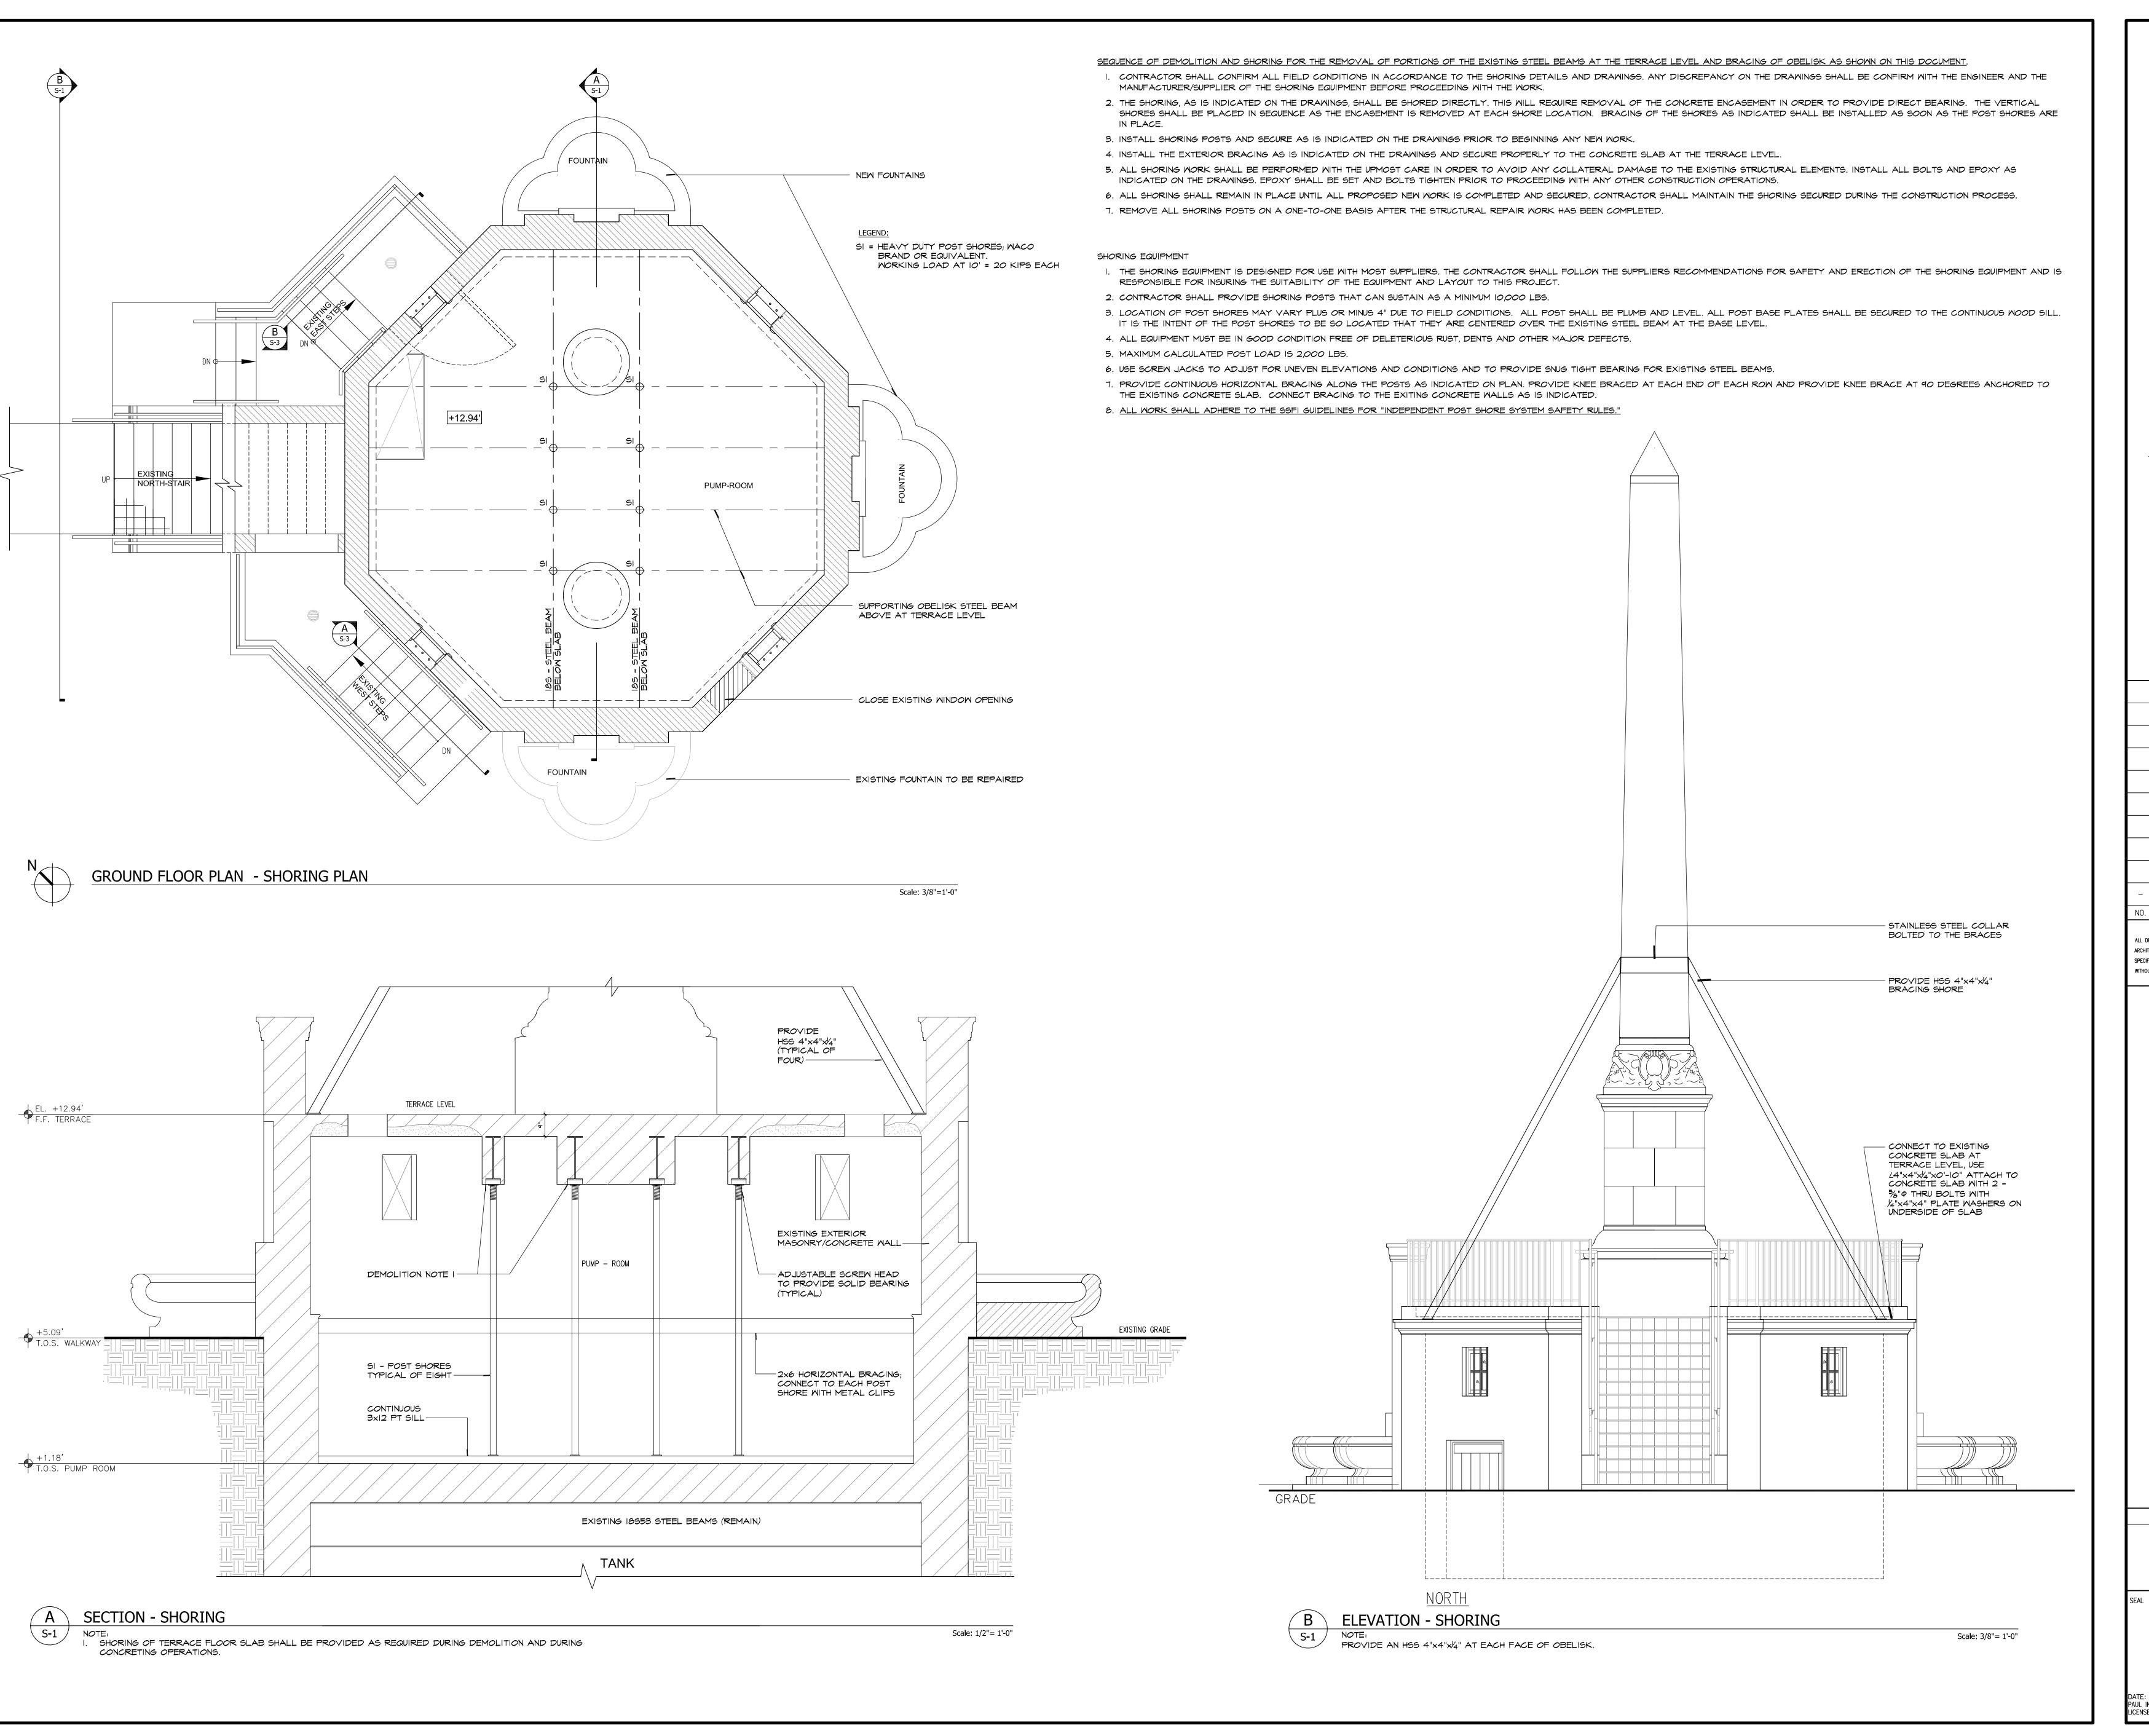

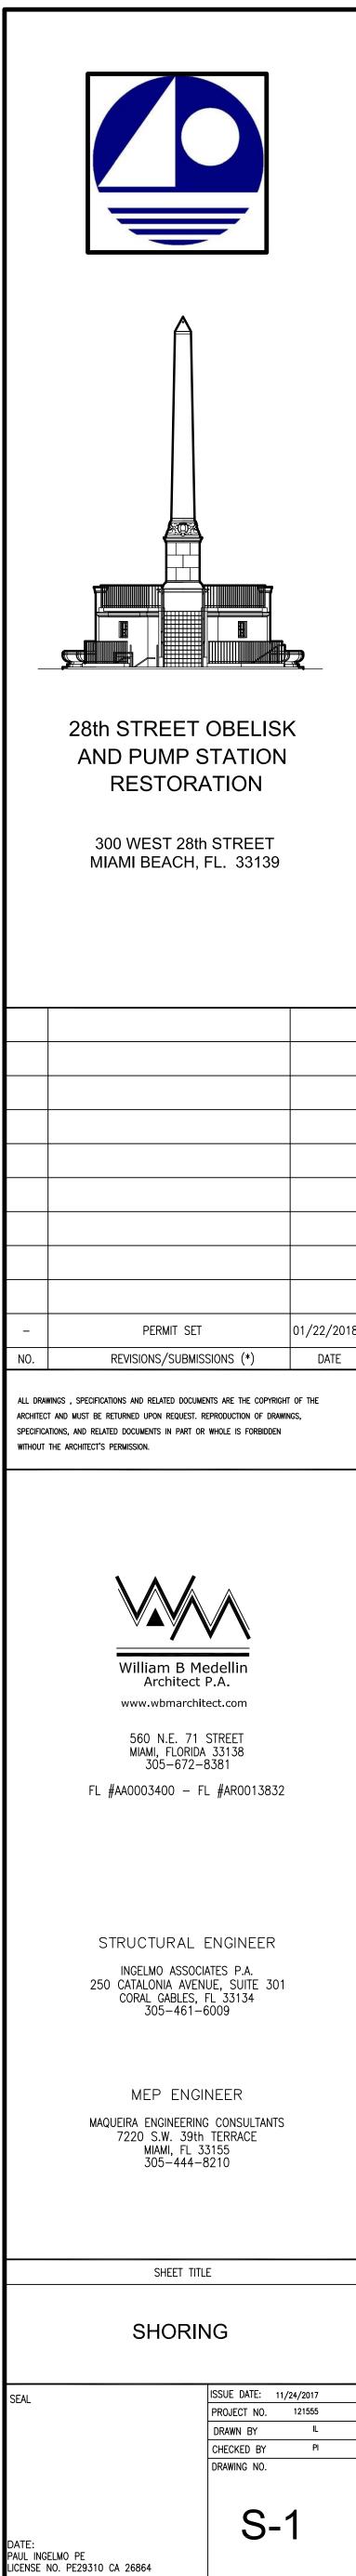

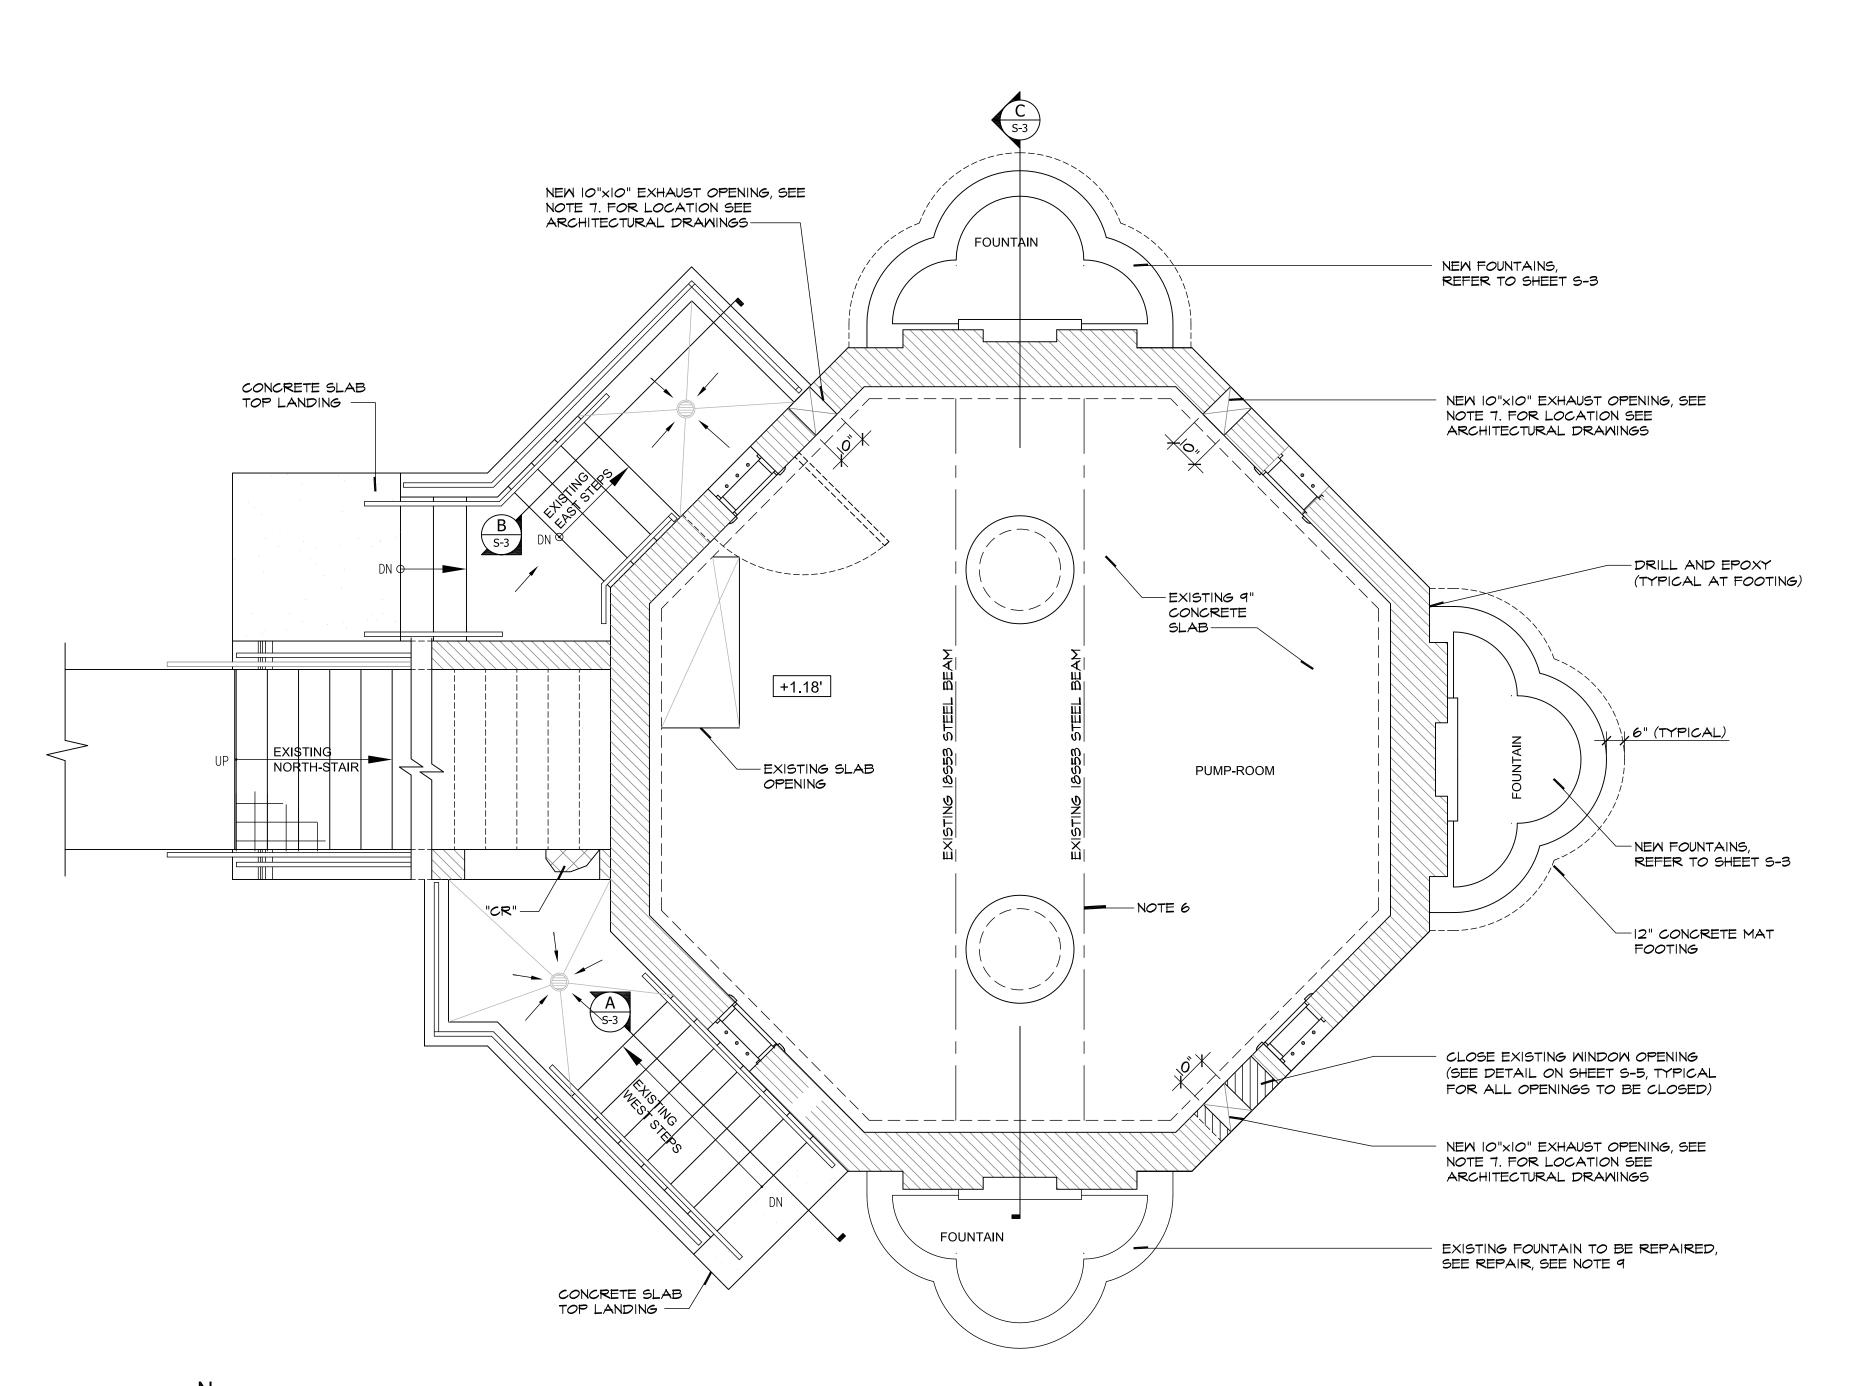

GROUND FLOOR PLAN - PUMP ROOM

<u>structural/ repair legend</u>

U.O.N. UNLESS OTHERWISE NOTED

C.J. CONSTRUCTION JOINT

"CR" - TYPICAL CONCRETE REPAIR PROCEDURE.

"SC" - SURFACE CRACKS; SEE ARCHITECTURAL.

"EI" - TYPICAL EPOXY INJECTION CRACK REPAIR


WALL LEGEND

- I. TOP ELEVATION OF EXISTING TERRACE FLOOR SLAB AS NOTED IS +12.94' (REFER TO SURVEY) UNLESS OTHERWISE NOTED.
- 2. TOP ELEVATION OF SLAB IS SHOWN ON PLAN THUS:
- 3. COORDINATE ALL DIMENSIONS, FLOOR SLOPES AND ELEVATIONS WITH ARCHITECTURAL DRAWINGS.

REPAIR WORK/SEQUENCE


- I. ALL EXISTING AND DETERIORATED CONCRETE ELEMENTS SHALL BE REMOVED BY LOCALIZED DEMOLITION WITHOUT DAMAGING ADJACENT AREAS TO REMAIN. REFER TO THE ARCHITECTURAL DRAWINGS FOR SPECIFIC DETAILS AS TO PRESERVATION/PROTECTION OF HISTORICAL ITEMS.
- 2. THE SLAB AREAS NOTED ON THE TERRACE FLOOR PLAN OUTLINE THOSE AREAS THAT WERE VISUALLY APPARENT AND ARE DETERIORATED, IT IS ANTICIPATED THAT MOST OF THE TERRACE 6" CONCRETE SLAB WILL REQUIRE REMOVAL AND REPLACEMENT AS A RESULT OF INTERNAL DAMAGE THAT IS NOT VISUALLY
- 3. BASED ON THE EXTERNAL VISUAL OBSERVATIONS, IT IS PROBABLE THAT THE CONCRETE ENCASEMENT OF THE TWO MIDDLE STEEL BEAM WILL REQUIRE COMPLETE REPLACEMENT. THIS WILL ONLY BE APPARENT AFTER LOCALIZED DEMOLITION AND REMOVAL OF THE EXISTING AND SPALLED CONCRETE ELEMENTS IN THE ENCASEMENT. THIS WILL ALLOW FOR A VISUAL INSPECTION OF THE ENTIRETY OF THE CONCRETE ELEMENTS. THE ENCASED STEEL BEAMS WILL ALSO HAVE TO BE INSPECTED AT THAT TIME. REPLACEMENT OF THESE BEAMS WILL BE BASED ON ITS CONDITION AFTER VISUAL ACCESS. REPAIR AND REINFORCEMENT WILL BE AN ALTERNATE SOLUTION IF POSSIBLE BASED ON THE EXISTING CONDITIONS.
- 4. NOTE THAT ADDITIONAL SHORING WILL BE REQUIRED TO BE PROVIDED IF THE EXISTING STEEL BEAMS, AFTER INSPECTION, REQUIRE REPLACEMENT. SHORING AND RE-SHORING PROCEDURES WILL HAVE TO BE IMPLEMENTED IN ORDER TO SAFELY ACCOMPLISH THE REPAIR AND REPLACEMENT WORK.
- 5. THE EXISTING SLAB OPENINGS ON THE TERRACE SHALL BE CASTED IN CONJUNCTION WITH THE REPAIRS INDICATED TO THE EXISTING CONCRETE SLAB. THE REINFORCING FOR THE TERRACE LEVEL SLAB SHALL BE #5 AT 8" ON CENTERS, TOP AND BOTTOM, BOTH WAYS.
- 6. THE EXISTING STEEL BEAM THAT SUPPORT TO EXISTING PUMPS AT THE LOWER SLAB LEVEL REMAIN.
- 7. CUTOUTS FOR THE PROPOSED 10"X10" OPENINGS IN THE EXISTING WALL SHALL BE ACCOMPLISHED BY SAW CUTTING CAREFULLY PROTECTING THE ADJACENT AREAS TO REMAIN. IF CONCRETE MASONRY IS FOUND, THE PERIMETER SHALL BE GROUTED SOLID WITH GROUT. (REFER TO THE ARCHITECTURAL DRAWING FOR EXACT LOCATION)
- 8. CONCRETE OBELISK SUPERSTRUCTURE ELEVATIONS ARE SHOWN ON SHEET S-4, REPAIRS ITEMS ARE IDENTIFIED AS PER THE REPAIR LEGEND. REPAIR PROCEDURES ARE SHOWN ON SHEET S-5 AND IN THE
- 9. THE EXISTING CONCRETE FOUNTAIN ON THE WEST SIDE SHALL BE REPAIRED FOLLOWING THE PROCEDURES SHOWN ON SHEET S-5; SEE ADDITIONAL REQUIREMENTS ON ARCHITECTURAL DRAWINGS.



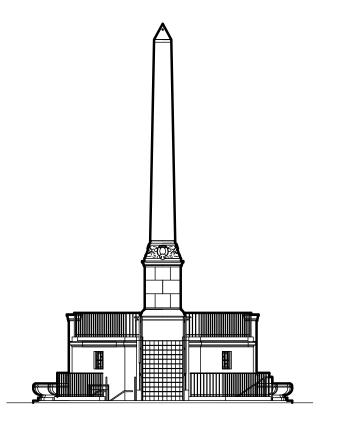

28th STREET OBELISK AND PUMP STATION RESTORATION

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SHEET TITLE

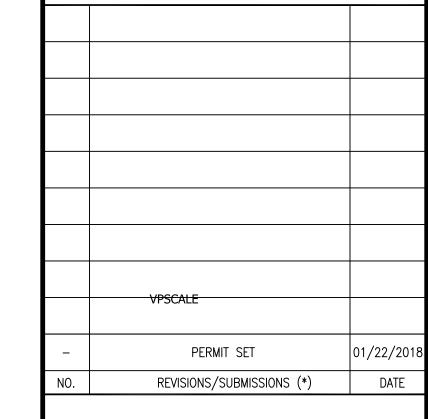
GROUND FLOOR PLAN -TERRACE FLOOR PLAN -NOTES

> ISSUE DATE: 11/24/2017 PROJECT NO. 121555


LICENSE NO. PE29310 CA 26864

PAUL INGELMO PE


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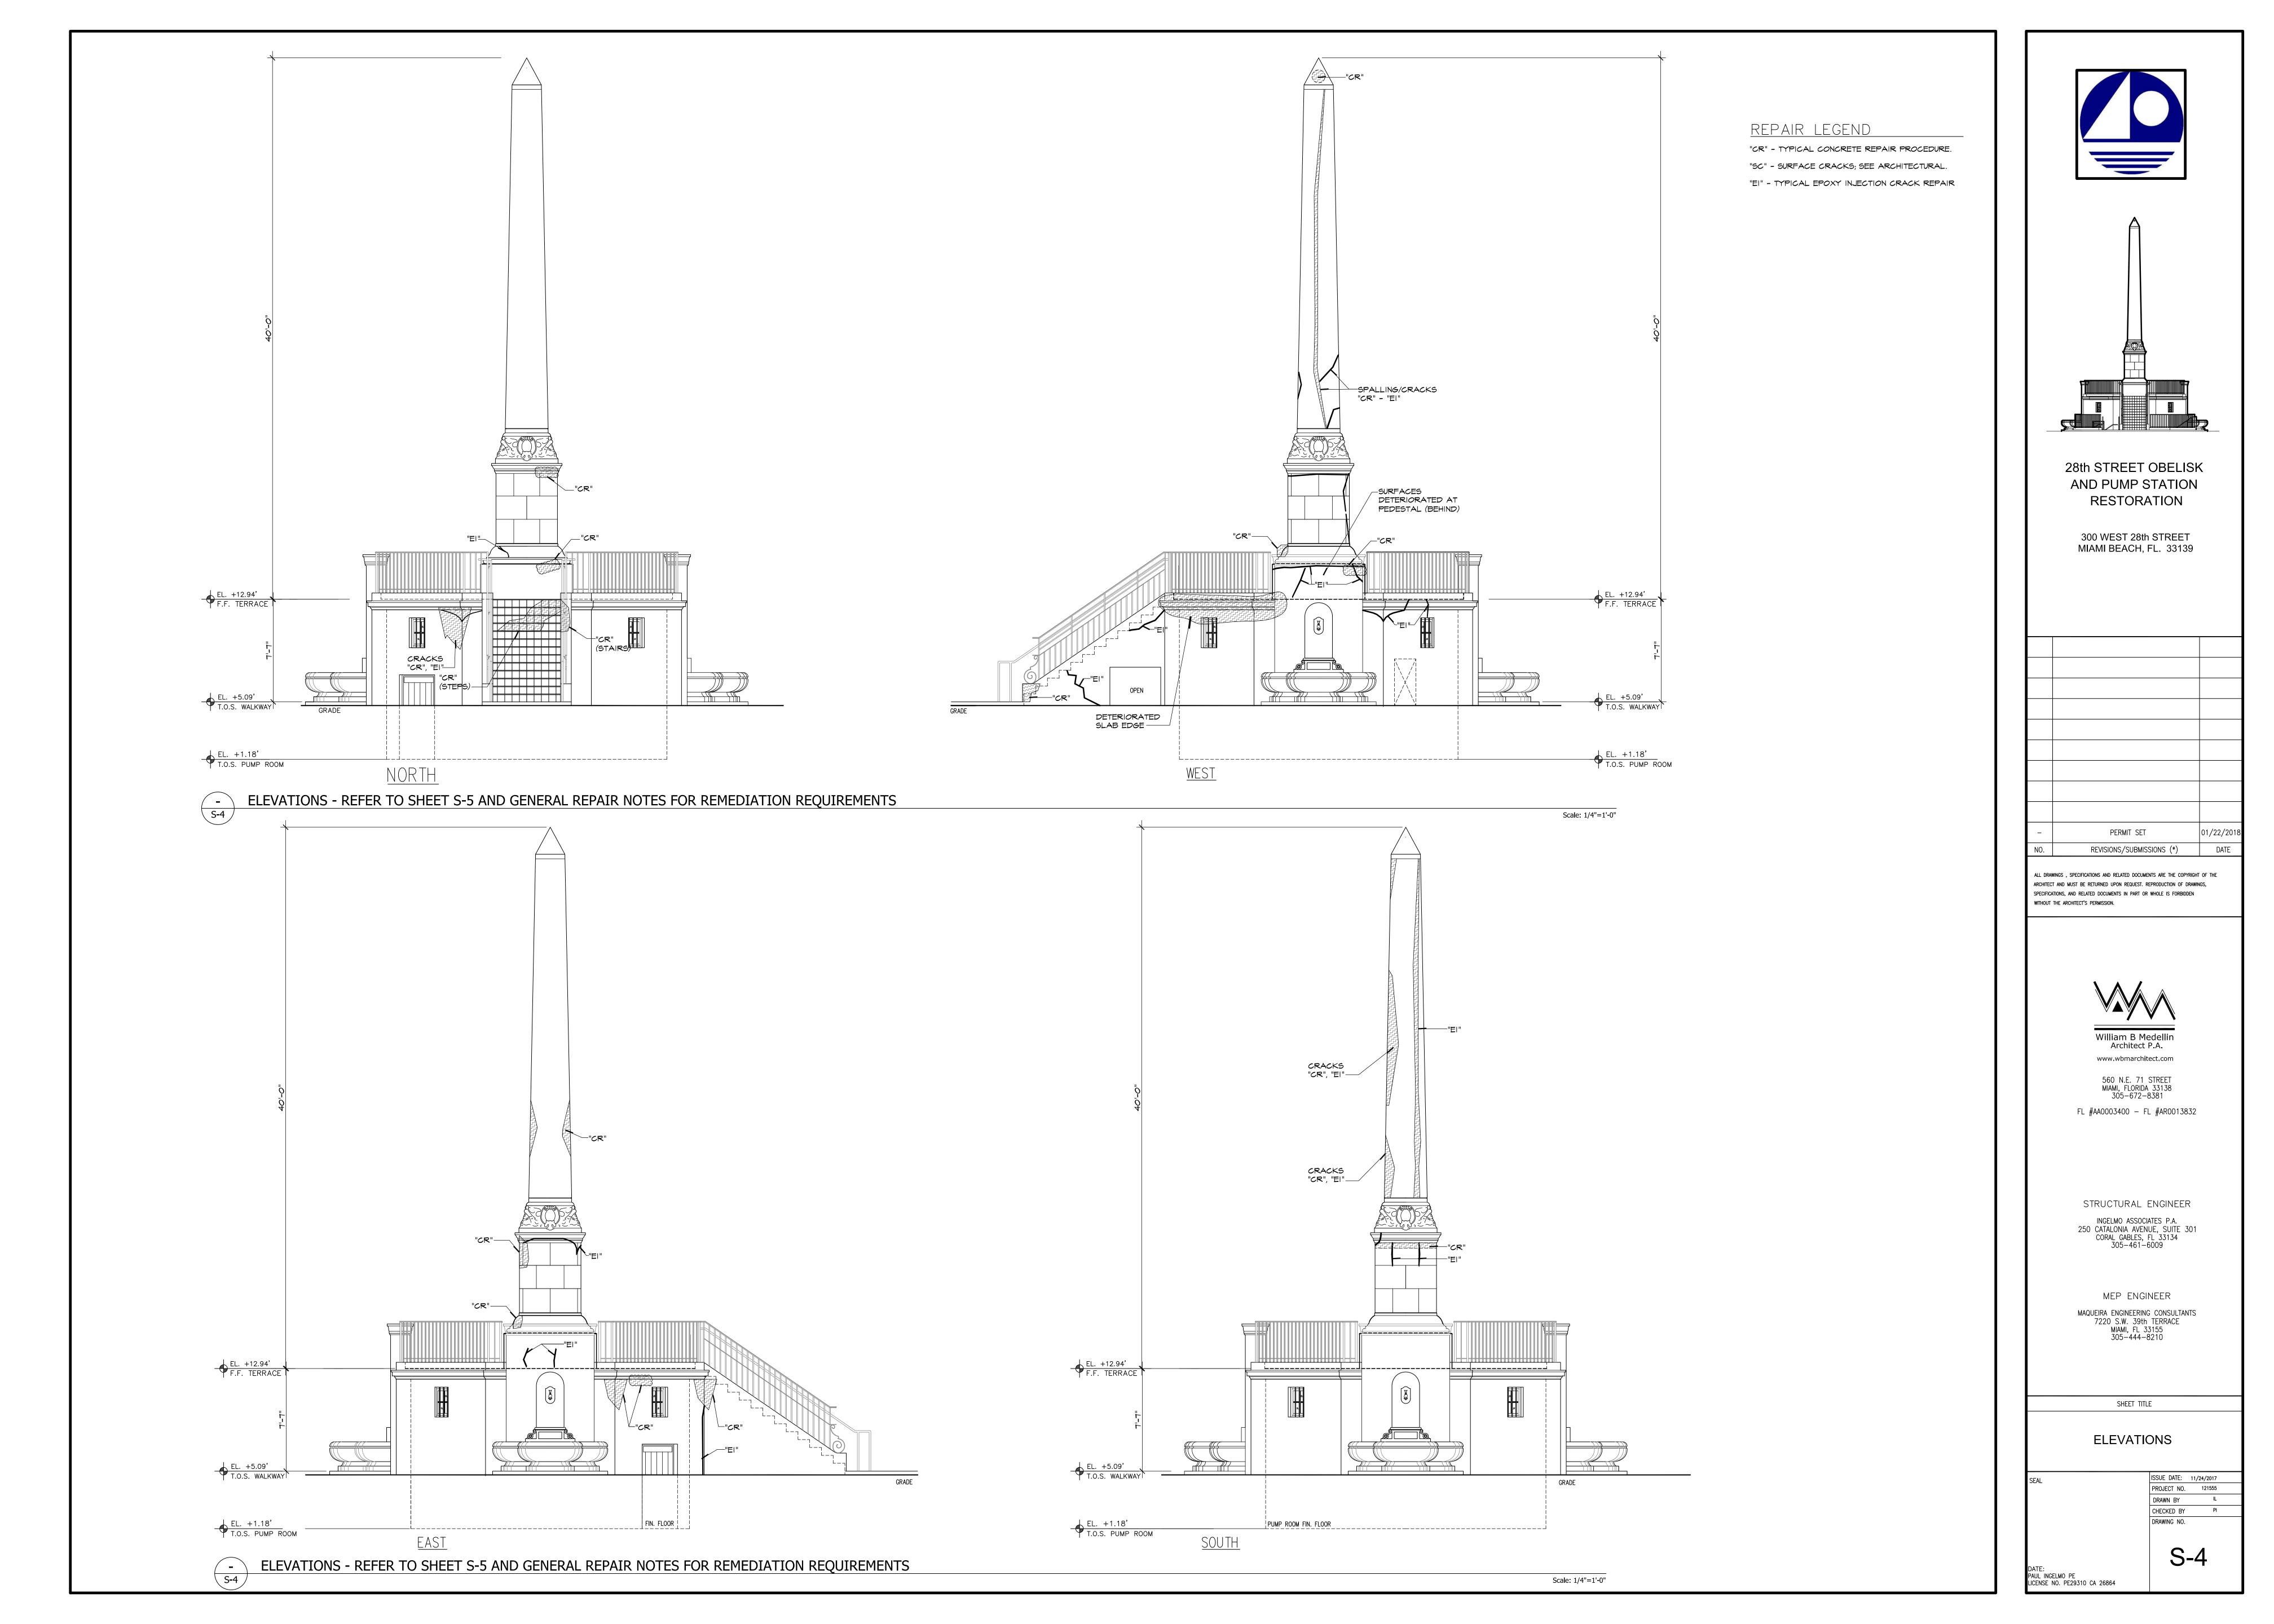
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SHEET TITLE

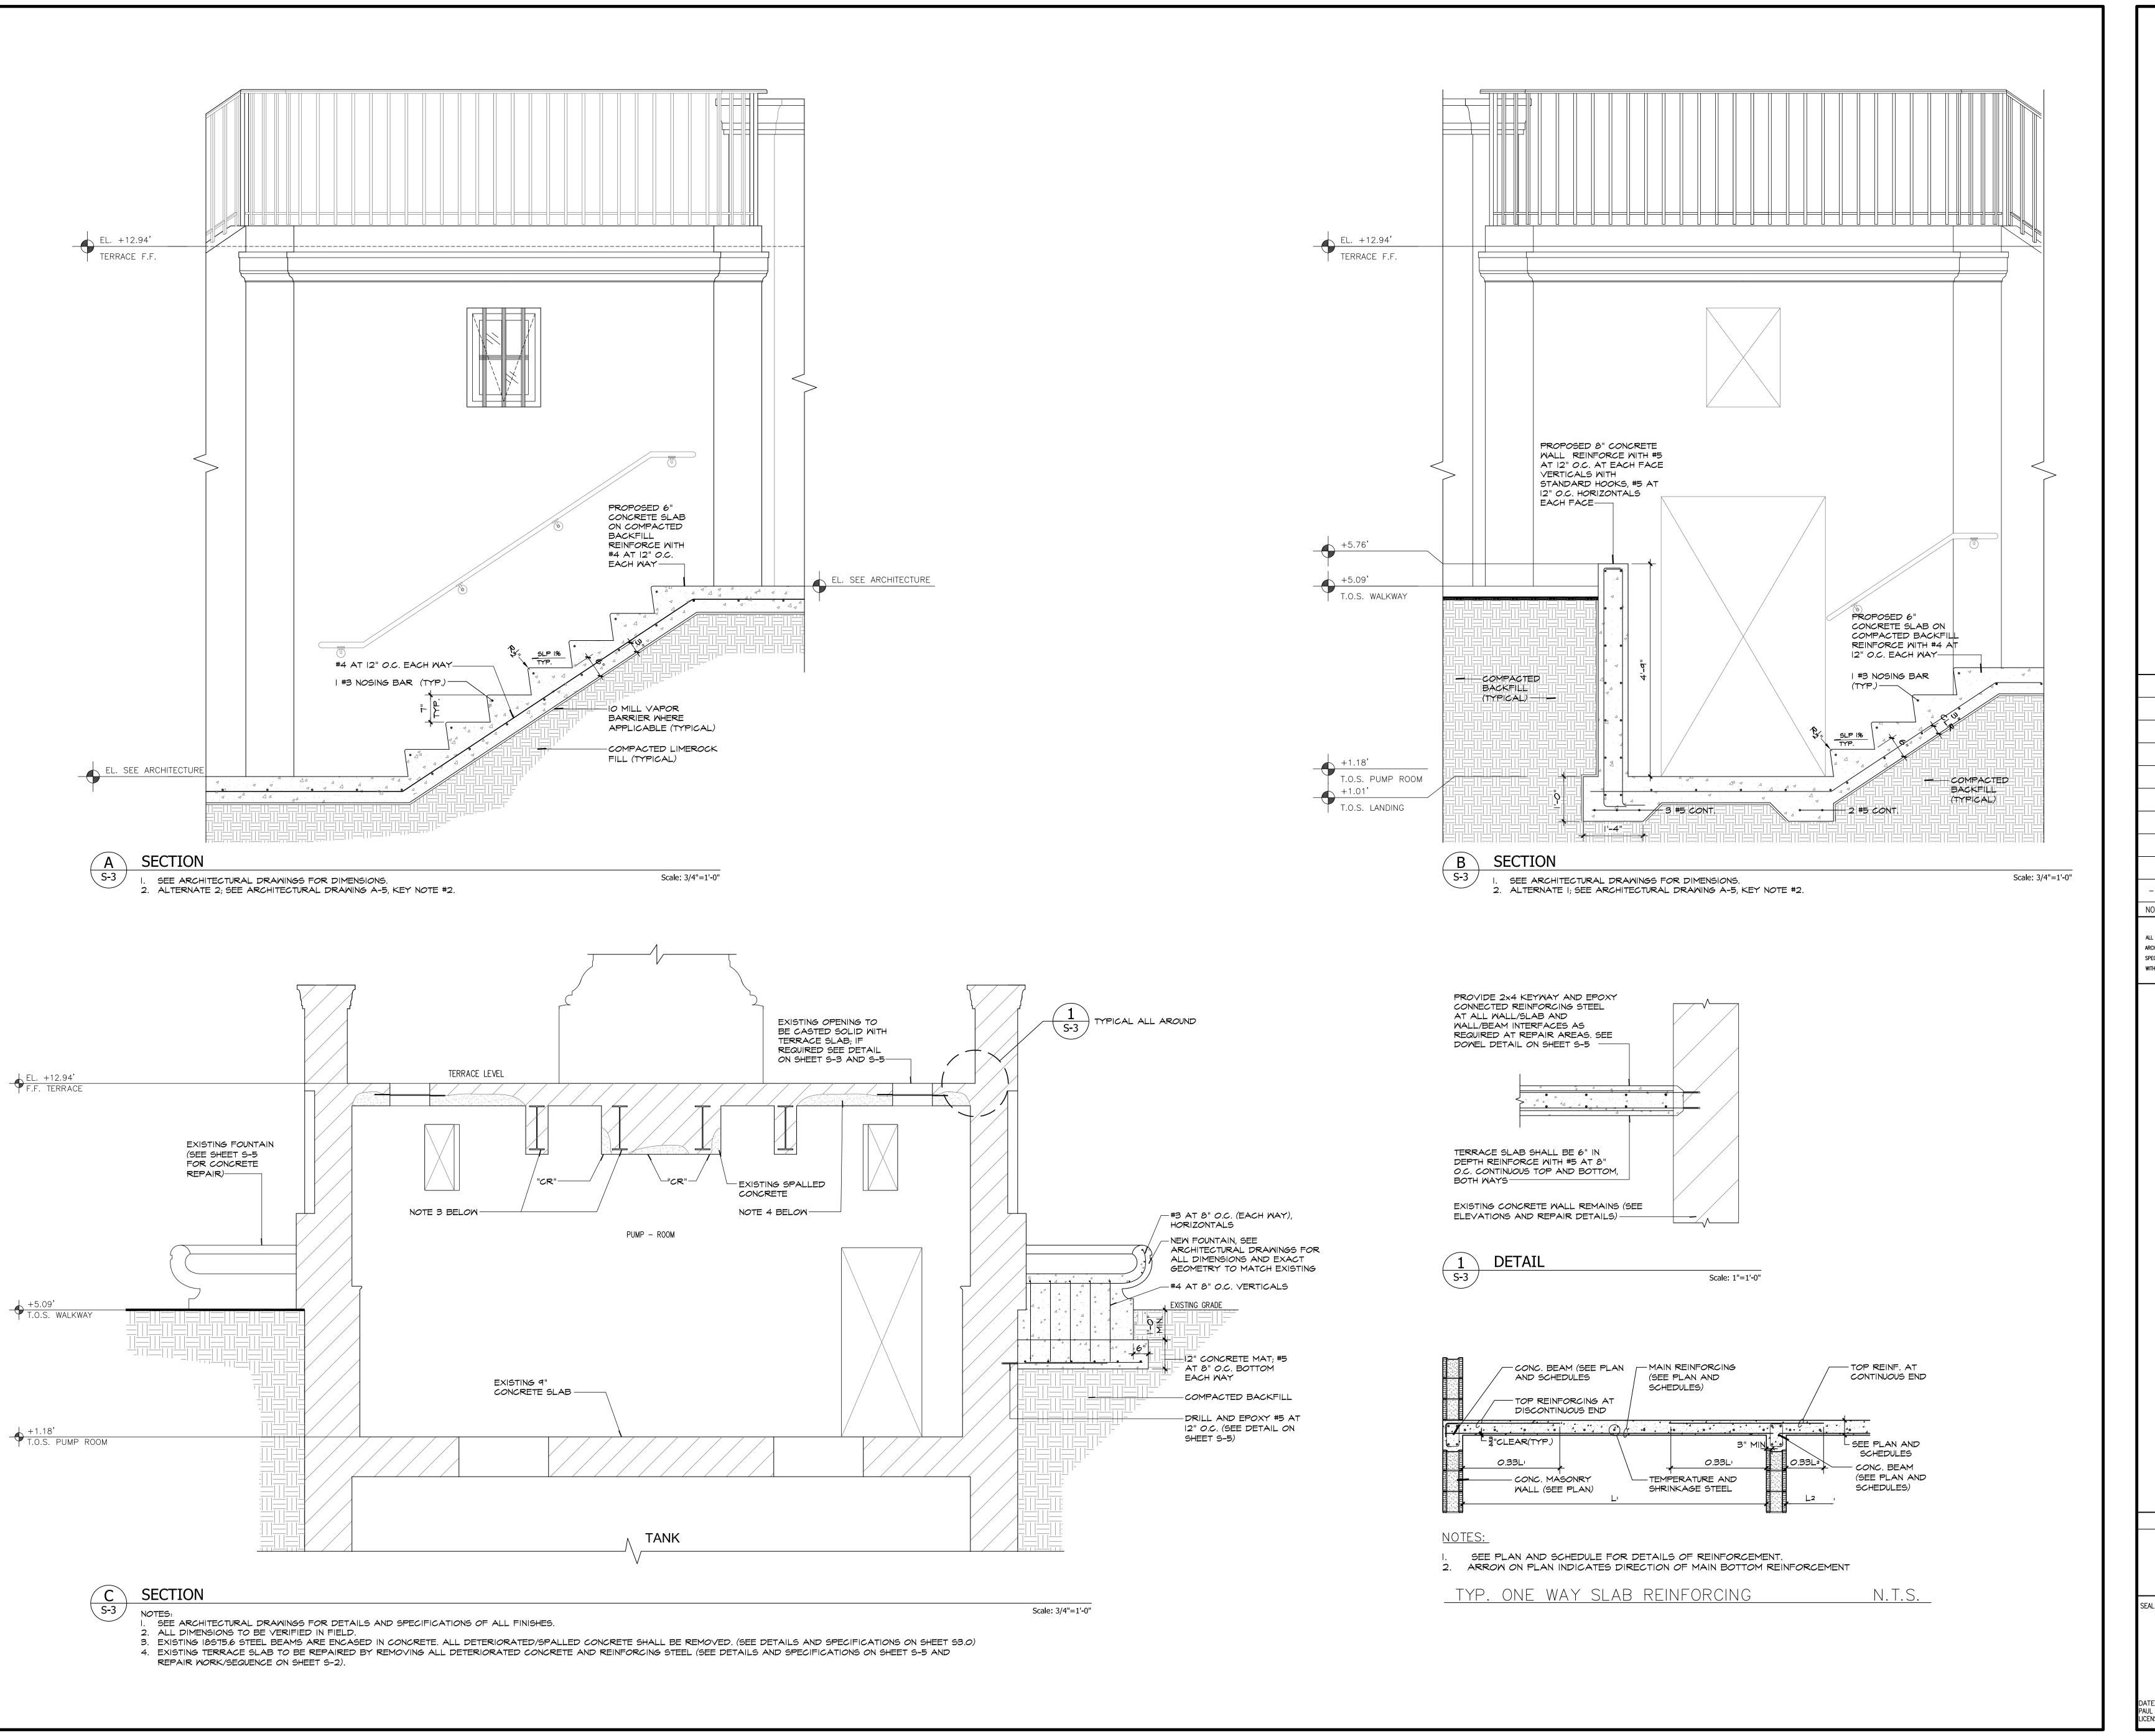SECTIONS AND DETAILS

ISSUE DATE: 11/24/2017
PROJECT NO. 121555
DRAWN BY IL
CHECKED BY PI
DRAWING NO.

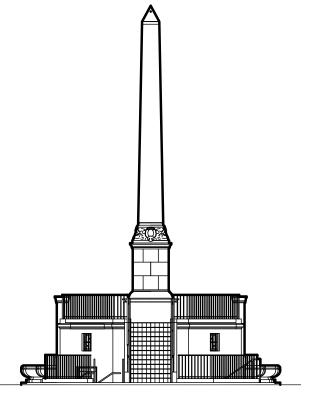
DATE: PAUL INGELMO PE LICENSE NO. PE29310 CA 26864

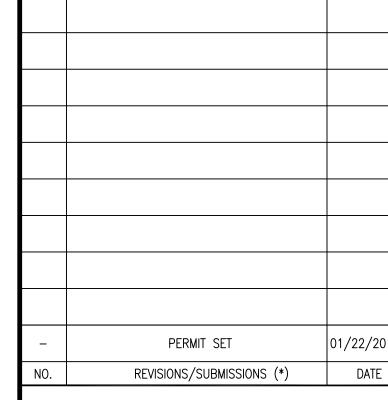


GENERAL CONCRETE REPAIR PROCEDURE

SPALLED AND DEFECTIVE CONCRETE - TYPICAL AT ALL BEAM AND SLAB SOFFITS, WALLS AND COLUMNS. REFER TO THE DRAWINGS. THE FOLLOWING SEQUENCE SHALL BE FOLLOWED. THE AREAS THAT REQUIRED REMOVAL ARE AS INDICATED ON THE DRAWINGS. HOWEVER, THE TOTALITY OF THE AREA TO BE REMOVED CAN ONLY BE DETERMINED AFTER THE GENERAL CONTRACTOR HAS BEGUN THE REMOVAL OPERATIONS. THE EXTENT OF DETERIORATION OF THE EXISTING CONCRETE AND THE REINFORCING STEEL WILL VARY DEPENDING ON THE INTERNAL DETERIORATION. THIS CAN ONLY BE DISCERNED BY REMOVING THE DAMAGED CONCRETE UNTIL SOUND CONCRETE AREAS ARE FOUND. PRIOR TO BEGINNING ANY CONCRETE REMOVAL OPERATIONS, GENERAL CONTRACTOR SHALL PROVIDE SHORING AS INDICATED AND / OR AS REQUIRED.


- REMOVE ALL LOOSE, CRACKED AND DETERIORATED CONCRETE TO A SOUND/SOLID CONCRETE BASE AT REINFORCING STEEL LOCATIONS AND AT SPALLED LOCATIONS. SOME CHIPPING OF SOUND CONCRETE WILL BE REQUIRED TO PROVIDE FOR ALL SQUARE EDGES. REMOVE A MINIMUM OF I" OF CONCRETE ALL AROUND THE REINFORCING STEEL IN ORDER TO PROVIDE PROPER BONDING. (SEE DETAIL I)
- 2. CLEAN CONCRETE SURFACES AND REMOVE ALL RUST FROM REINFORCING STEEL BY SANDBLASTING AND/OR HEAVY WIRE BRUSHING. CONCRETE REMOVAL SHALL REGULARLY EXTEND ALONG THE BARS TO LOCATIONS ALONG THE BAR THAT ARE FREE FROM BOND INHIBITING CORROSION AND WHERE THE BAR IS WELL BONDED TO THE SURROUNDING CONCRETE.
- 3. ANY REINFORCING STEEL BARS WHICH ARE LOOSE SHALL BE SECURED IN PLACE BY TYING TO OTHER SECURED BARS OR BY OTHER APPROVED METHODS. 4. CAUTION; BEFORE STARTING REMOVAL OPERATIONS, REVIEW THE EFFECT OF THE REMOVALS ON STRUCTURAL INTEGRITY, PROVIDE SHORING OF MEMBERS AS NECESSARY AND INDICATED, ALSO PROVIDE PROTECTION FROM FALLING DEBRIS. PARTICULAR CARE SHALL BE EXERCISED AT SLAB/BEAM AND CONNECTIONS TO
- MALLS/COLUMNS. 5. COAT THE NEWLY CLEANED STEEL BARS WITH SIKA-ARMATEC 110 OR ACCEPTED EQUIVALENT, THIS COATING WILL ELECTRICALLY ISOLATE THE REBARS FROM THE NEW REPAIR CONCRETE MATERIAL WHICH WILL BE USED. SIKA-ARMATEC IIO IS AN ANTI-CORROSION COATING, 2-COMPONENT, POLYMER MODIFIED CEMENTITIOUS COATING FORMULATED TO INHIBIT THE CORROSION OF REINFORCING STEEL.
- 6. WHERE EXISTING REINFORCING STEEL HAS BEEN REDUCED TO LESS THAN 75% OF ITS ORIGINAL EFFECTIVE AREA, CONTRACTOR IS TO PROVIDE NEW REINFORCING STEEL BY SPLICING SAME SIZE REINFORCING STEEL
- AT THESE LOCATIONS. (SEE DETAIL 2 AND 3). 7. BEFORE APPLYING THE PATCHING MATERIAL, ALL EXISTING CONCRETE SURFACES SHALL BE MOISTENED AND ALLOWED TO DRY UNTIL DAMP. 8. WE RECOMMEND TO USE STO OVERHEAD MORTAR WITH CI AS THE REPAIR MATERIAL FOR ALL PATCHING.
- 9. RESTORE ALL DEFECTIVE CONCRETE AREAS TO PROVIDE A MINIMUM COVER OF I" ON ALL NEW OR EXISTING REINFORCING STEEL.
- 10. AFTER FORM REMOVAL AND CURING, ALL REPAIRED AND PATCHED AREAS SHALL BE WATERPROOF. . CONTRACTOR SHALL STRICTLY FOLLOW THE MANUFACTURER'S RECOMMENDATIONS PERTAINING TO THE MIXING AND APPLICATION OF ALL OF THE PRODUCTS USED.
- 12. TYPICAL REPAIRS DETAILS ARE AS INDICATED ON THE DRAWINGS AND AS PER "GUIDE FOR SURFACE" PREPARATION FOR THE REPAIR OF DETERIORATED CONCRETE RESULTING FROM REINFORCING STEEL

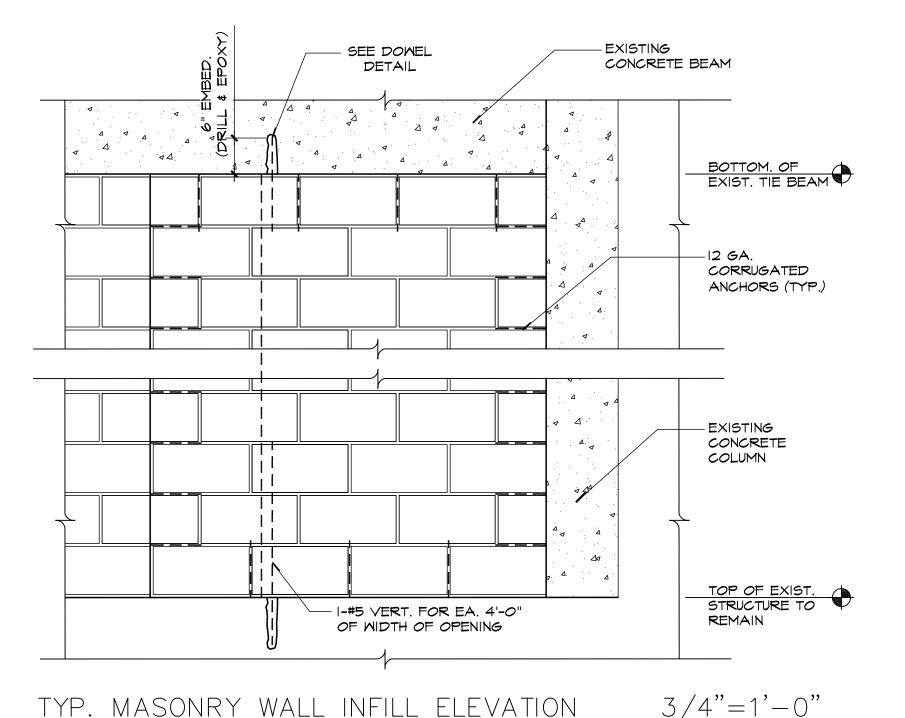


- FILL ONE CELL AT EACH SIDE OF OPENING WITH 1#5 VERTICAL BAR AT EACH FILLED CELL 2. CONNECT A 12 GA. CORRUGATED WALL ANCHOR TO EXISTING WALL FOR EACH MORTAR JOINT. USE HECKMAN 340-A ANCHORS. I 1/4" WIDE \times 3 1/2" LONG WITH A 3/16" DIA. TAPCON FASTENED TO
- EXISTING MASONRY OR CONCRETE. 3. PLACE 8 GA HORIZONTAL LADDER REINF. IN EACH NEW HORIZONTAL MASONRY JOINT LAPPING 3" MIN.
- 4. FOR WIDTHS GREATER THAN 4'-O" AND LESS THAN 8'-O" ADD #5 VERTS @ 4'-O" O.C. MAX. 5. IF JAMB CONSISTS OF A CONCRETE COLUMN, CONNECT CORRUGATED ANCHOR DIRECTLY TO COLUMN.

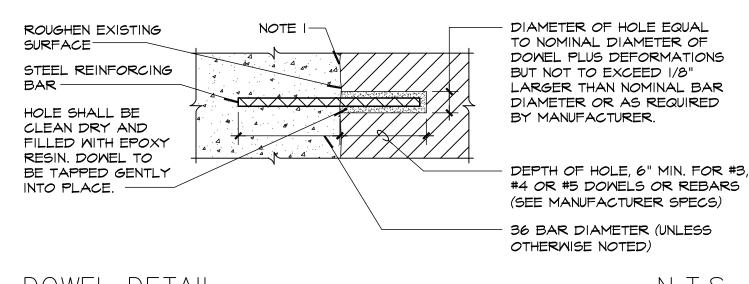

- DOWEL DETAIL
- EXISTING CONCRETE TO BE CLEANED IN ACCORDANCE WITH MANUFACTURER'S RECOMMENDATIONS BEFORE APPLYING EPOXY BONDING COMPOUND. USE "DURAWELD"
- BRAND OR ACCEPTABLE EQUIVALENT. 2. AT CONTRACTORS OPTION USE ITM-RAMSET/REDHEAD "EPCON ACRYLIC 7" ANCHORING ADHESIVE MIAMI DADE COUNTY N.O.A. # 06-0425.02, OR ALLIED FASTENER & TOOL INC. "ALLIED + ADHESIVE" ANCHORING SYSTEM MIAMI DADE N.O.A. No. 05-0317.02 OR HILTI "HIT HY200" ANCHORING ADHESIVES.

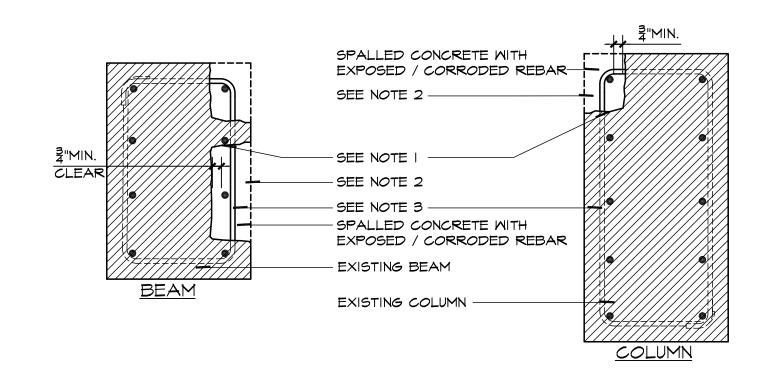

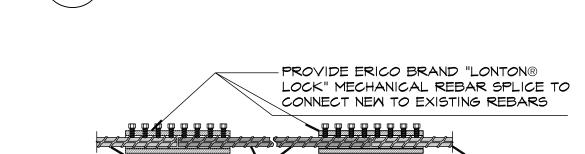


TYPICAL REBAR SPLICE

TYPICAL BEAM/COLUMN SECTION

NEW REBAR PIECE

DAMAGED SECTION-

-EXISTING REBAR; REMOVE

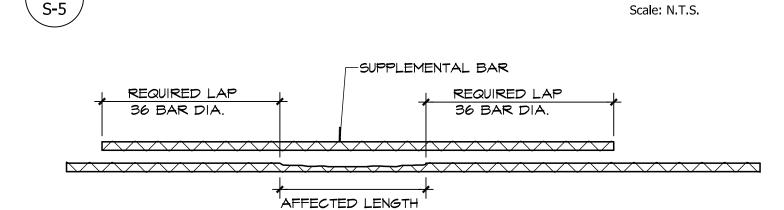



Scale: N.T.S.

IF REINFORCING STEEL HAS LOST SIGNIFICANT CROSS SECTION, THE STRUCTURAL ENGINEER SHALL BE CONSULTED. IF REPAIRS ARE REQUIRED TO THE REINFORCING STEEL, ONE OF THE FOLLOWING REPAIR METHODS SHOULD BE USED: - COMPLETE BAR REPLACEMENT.


ADDITION OF SUPPLEMENTAL BAR OVER AFFECTED SECTION. NEW BARS MAY BE MECHANICALLY SPLICED TO OLD BARS OR PLACED PARALLEL TO AND APPROXIMATELY 3/4" FROM EXISTING BARS. LAP LENGTHS SHALL BE DETERMINATE IN ACCORDANCE WITH ACI 318; ALSO REFER TO CRSI AND AASHTO MANUAL.

REPAIR OF REINFORCING STEEL DUE TO LOSS OF SECTION

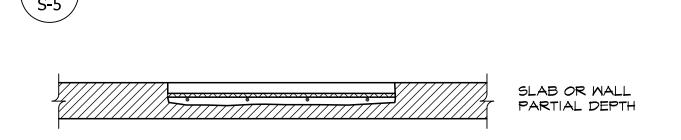

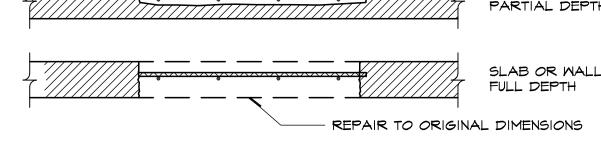




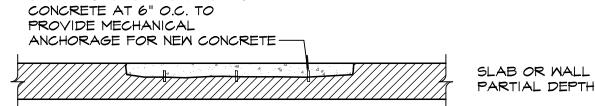

CONCRETE REPAIR -FULL AND PARTIAL DEPTH



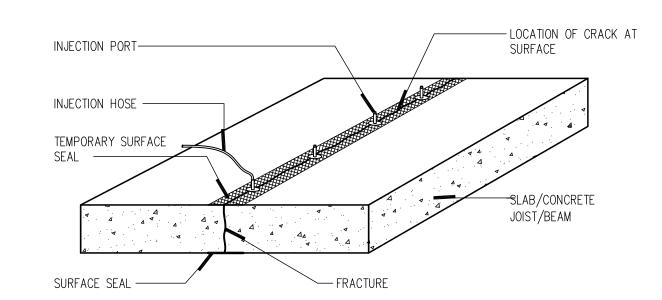

REPAIR PROCEDURES

- SURFACE SHALL BE CLEANED BY GRINDING, SANDBLASTING, OR WATERBLASTING TO ENSURE BOND OF SURFACE SEAL TO CRACK.
- 2. INJECTION PORTS SHALL BE PLACED ACCORDING TO THE SPECIFICATIONS.
- 3. THE SURFACE OF CRACK AND THE AREA AROUND EACH INJECTION PORT SHALL BE SEALED WITH AN EPOXY GEL OR HYDRAULIC CEMENT.
- 4. THE CRACK SHALL BE INJECTED WITH A LOW VISCOSITY EPOXY RESIN, SUCH AS SIMPSON ETI INJECTION EPOXY; ETI-LV; SIKADUR 52 INJECTION RESIN, SIKADUR 35 HI-MOD LV INJECTION RESIN OR EQUIVALENT.
- 5. AFTER COMPLETION OF INJECTION OPERATION, REMOVE SURFACE SEAL BY MECHANICAL

Scale: N.T.S.



- ALL CONSTRUCTION SHALL BE IN ACCORDANCE WITH THE FLORIDA BUILDING CODE 2014 OR LATEST EDITION. ALL WIND
- LOADINGS ARE IN ACCORDANCE TO ASCE 7-10. 2. TO THE BEST OF OUR KNOWLEDGE, THE STRUCTURAL DRAWINGS AND SPECIFICATIONS COMPLY WITH THE APPLICABLE
- REQUIREMENTS OF THE GOVERNING BUILDING CODE. 3. THE STRUCTURAL DOCUMENTS ARE TO BE USED IN CONJUNCTION WITH THE ARCHITECTURAL DOCUMENTS.
- 4. DETAILS LABELED "TYPICAL" APPLY TO ALL SITUATIONS THAT ARE THE SAME OR SIMILAR TO THOSE SPECIFICALLY REFERENCED, WHETHER OR NOT THEY ARE KEYED IN AT EACH LOCATION. ALL SECTIONS AND DETAILS SHALL BE CONSTRUED TO BE TYPICAL OR SIMILAR UNLESS ANOTHER SECTION OR DETAIL IS NOTED. QUESTIONS REGARDING THE APPLICABILITY OF TYPICAL DETAILS SHALL BE RESOLVED BY THE ARCHITECT.
- 5. CONTRACTORS WHO DISCOVER DISCREPANCIES, OMISSIONS OR VARIATIONS IN THE CONTRACT DOCUMENTS DURING BIDDING SHALL IMMEDIATELY NOTIFY THE ARCHITECT. THE ARCHITECT WILL RESOLVE THE CONDITION AND ISSUE WRITTEN INSTRUCTIONS.
- 6. THE GENERAL CONTRACTOR SHALL REVIEW AND DETERMINE THAT DIMENSIONS ARE COORDINATED BETWEEN ARCHITECTURAL AND STRUCTURAL DRAWINGS PRIOR TO FABRICATION OR START OF CONSTRUCTION. 7. THE CONTRACTOR IS RESPONSIBLE FOR STABILITY AND TEMPORARY BRACING, INCLUDING, BUT NOT LIMITED TO THE EXISTING PERGOLA ROOF AND TEA HOUSE WOOD STRUCTURE. WHENEVER THE CONTRACTOR IS UNSURE OF THESE REQUIREMENTS, THE

CONTRACTOR SHALL RETAIN A FLORIDA LICENSED ENGINEER TO DESIGN AND INSPECT THE TEMPORARY BRACING AND

STABILITY OF THE STRUCTURE. 8. NO STRUCTURAL MEMBER SHALL BE CUT, NOTCHED OR OTHERWISE REDUCED IN STRENGTH UNLESS OTHERWISE NOTED.

REINFORCED REPAIR CONCRETE:

GENERAL NOTES:

- ALL REBARS, INCLUDING FOOTINGS AND DOWELS MUST BE SECURED IN THE PROPER POSITION BY A POSITIVE BY A POSITIVE MEANS. EXCEPT WHERE DIMENSIONS OTHERWISE, ALL HOOKS ON REBARS SHALL BE STANDARD ACI-318 HOOKS. REBAR ACCESSORIES TO HAVE UPTURNED LEGS PLASTIC DIPPED AFTER FABRICATION.
- 2. REINFORCING STEEL, NEW ASTM A-615, GRADE 60. FABRICATE AND DETAIL IN ACCORDANCE WITH ACI-315. SPLICES IN REBARS SHALL BE AS INDICATED ON THE DETAILS. CONCRETE COVER OVER THE REBARS SHALL BE AS DETAILED IN THE DRAMINGS. IF NOT DETAILED ON DRAMINGS, USE THE FOLLOMING: 3" FOR BOTTOM AND ENDS OF FOOTINGS; I" AT THE SIDES FOR TIES OR STIRRUPS ON COLUMNS AND BEAMS (2" OVER MAIN REINFORCEMENT); 2" FORMED CONCRETE IN CONTACT WITH THE GROUND; I" FOR INTERIOR SLAB REINFORCEMENT; 2" FOR EXTERIOR SLAB REINFORCEMENT.
- 3. ALL CONCRETE FOR REPAIRS SHALL BE AS SPECIFIED ON THE CONCRETE REPAIR NOTES. CONSTRUCTION SHALL COMPLY WITH ACI 318, AMERICAN CONCRETE INSTITUTE "BUILDING CODE REQUIREMENTS FOR STRUCTURAL CONCRETE AND COMMENTARY" AND WITH ACI 530. LOCATION OF CONSTRUCTION JOINTS NOT SHOWN ON DRAWINGS SHALL BE APPROVED BY THE ENGINEER. ALL CONSTRUCTION JOINTS FOR BEAMS AND SLABS SHALL BE KEYED. 4. COMPLY WITH ACI 301 AND 318 AND SPECIFICATION SECTION AS APPLICABLE.

CRACK REPAIR ADHESIVE SYSTEMS

EXPANSION/EPOXY ANCHORS:

- I. ALL CRACK REPAIRS SHALL BE ACCOMPLISHED USING SIMPSON BRAND STRONG TIE REPAIR ADHESIVES, "ETI, INJECTION
- EPOXY" OR ACCEPTABLE EQUIVALENT. 2. CRACK REPAIR SHALL BE REMEDIATED USING THE ETI-LV, LOW VISCOSITY INJECTION EPOXY.
- 3. ALL WORK SHALL COMPLY AND ADHERE TO THE REQUIREMENTS AND SPECIFICATION OF THE EPOXY MANUFACTURER. 4. SUBMIT FOR APPROVAL CATALOGUE LITERATURE OF MANUFACTURER'S INJECTION EQUIPMENT AND MATERIAL SPECIFICATIONS.

5. SEE DRAWINGS FOR TYPICAL CRACK REPAIR PROCEDURE.

ACCORDANCE TO THE AMERICAN WELDING SOCIETY.

- I. USE WEDGE-TYPE EXPANSION ANCHORS SUCH AS THE HILTI KWIK BOLT II, ITW RAMSET RED HEAD TRUBOLT WEDGE. POWERS RAML POWER-STUD, OR ACCEPTED EQUIVALENT. FOLLOW MANUFACTURER'S SPECIFICATIONS FOR USE AND INSTALLATION.
- 2. USE SCREW ANCHORS SUCH AS THE HILTI HUS-EZ CARBON STEEL SCREW ANCHOR, POWER FASTENERS WEDGE BOLT SCREW ANCHOR AND/OR ACCEPTED EQUIVALENT. FOLLOW MANUFACTURER'S SPECIFICATIONS FOR USE AND INSTALLATION.
- 3. CONFIRMS THE ABSENCE OF REINFORCING STEEL BY DRILLING A 1/4" DIAMETER PILOT HOLE FOR EACH ANCHOR. DO NOT CUT REINFORCING STEEL WITHOUT APPROVAL OF THE STRUCTURAL ENGINEER. 4. PROVIDE ANCHOR EMBEDMENT, SPACING AND EDGE DISTANCE AS SHOWN ON THE DRAWINGS. 5. USE AN EPOXY, ACRYLIC OR POLYESTER RESIN ADHESIVE SYSTEM SUCH AS THE POWERS RAWL POWER-FAST SYSTEM, HILTI

HIT HY200, ALLIED FASTENER ALLIED GOLD A-1000 OR ACCEPTED EQUIVALENT. FOLLOW MANUFACTURER'S SPECIFICATION

FOR USE AND INSTALLATION. STRUCTURAL STEEL:

- I. FABRICATE AND ERECT STRUCTURAL STEEL AND CONFORMANCE WITH AISC "SPECIFICATIONS FOR THE DESIGN, FABRICATION AND ERECTION OF STRUCTURAL STEEL FOR BUILDINGS" WITH COMMENTARY AND ALL OSHA REQUIREMENTS
- 2. STRUCTURAL STEEL: a.STEEL SHALL CONFORM TO THE FOLLOWING ASTM SPECIFICATION:
- a.a. ALL STIFFENER, PLATES, CHANNELS ANGLES, PLATES AND BARS SHALL BE STAINLESS STEEL, ASTM T316. **b.MISCELLANEOUS METALS:**
- b.a. ANCHOR BOLTS, BOLTS AND EXPANSION ANCHORS ON FORMING TO ASTM A c.COLD FORMED HOLLOW STRUCTURAL SECTIONS (HSS)
- c.a. STEEL PIPE: STAINLESS STEEL, ASTM T 316, SCHEDULE 80 d.MISCELLANEOUS SHAPES AND PLATES, STAINLESS STEEL CONFORMING TO ASTM T316. 3. WELDING:
- a. ALL WELDING IS TO BE PERFORMED BY CERTIFIED WELDERS **b.ELECTRODES TO BE APPLICABLE TO STAINLESS STEEL AND IN ACCORDANCE WITH AWS REQUIREMENTS** C.ALL FIELD WELDING SHALL BE INSPECTED BY AN INDEPENDENT TESTING LABORATORY RETAINED BY THE OWNER. d.ALL WELDING SHALL CONFORM TO THE REQUIREMENTS OF THE STANDARD CODE FOR WELDING BUILDING CONSTRUCTION IN
- 4. ALL STEEL EXPOSED TO THE WEATHER SHALL BE STAINLESS STEEL. 5. ALL BOLTS, SCREWS, WASHERS AND OTHER FASTENERS AND MISCELLANEOUS METAL HARDWARE SHALL BE ASTM 1316,
- STAINLESS STEEL. 6. SETTING BASE, BEARING PLATES AND SUPPORTING ANGLES: CLEAN CONCRETE AND MASONRY BEARING SURFACE OF
- BOND-REDUCING MATERIALS AND CLEAN BOTTOM OF BASE AND BEARING PLATE. a.SET BASE OR BEARING PLATE ON WEDGES OR OTHER ADJUSTING DEVICES.
- 6.TIGHTEN ANCHOR RODS AFTER STRUCTURAL STEEL FRAME HAS BEEN PLUMBED. DO NOT REMOVE WEDGES OR SHIMS BUT, IF PROTRUDING, CUT OFF FLUSH WITH EDGE OF BASE OR BEARING PLATE PRIOR TO PACKING WITH GROUT. c.IF REQUIRED, PACK OR POUR NON-SHRINK GROUT SOLIDLY BETWEEN BEARING SURFACE AND BASE OF BEARING PLATE. ENSURE THAT NO VOIDS REMAIN. FINISH EXPOSED SURFACES, PROTECT GROUT AND ALLOW TO CURE. d.FOR PROPRIETARY GROUT MATERIALS, COMPLY WITH MANUFACTURER'S INSTRUCTIONS
- 6.BASE PLATES MUST BE GROUTED A MINIMUM OF 72 HOURS PRIOR TO PLACING CONCRETE SLABS ON SUPPORTING STEEL
- 7. REFER TO ARCHITECTURAL DRAWINGS AND PROJECT SPECIFICATIONS FOR PAINTING AND OR COATINGS OF STRUCTURAL STEEL. DO NOT PAINT STEEL SURFACES IN CONTACT WITH CONCRETE.

SHORING:

- SHORING REQUIREMENTS FOR THE EXISTING STRUCTURE INCLUDING THE OBELISK ARE NOTED ON THE DRAWINGS. HOWEVER, THE SHORING CONTRACTOR IS REQUIRED TO SUBMIT COMPLETE SHORING SHOP DRAWINGS AND CALCULATIONS SIGNED AND
- SEALED BY A FLORIDA REGISTERED ENGINEER.
- 2. ADDITIONAL SHORING AS REQUIRED BY GC FOR REINFORCED CONCRETING SHALL BE DETAILED BY GC TO INCLUDE ANY TEMPORARY BRACING OF THE STRUCTURE.
- 3. DO NOT REMOVE SHORING UNTIL CONCRETE STRENGTH HAS REACHED 2,800 PSI. 4. THE CONTRACTOR SHALL BE RESPONSIBLE FOR ALL NECESSARY SHORING, BARRICADES AND OTHER SAFETY PROCEDURES
- AS RECOMMENDED BY O.S.H.A AND OTHER GOVERNING CODES. 5. THE CONTRACTOR IS RESPONSIBLE FOR PROTECTING THE EXISTING PROPERTY FROM DAMAGE DURING CONSTRUCTION. REFER TO THE ARCHITECTURAL DRAWINGS FOR SPECIAL PROTECTION OF HISTORICAL ITEMS AND PROCEDURES DURING

COORDINATION OF CONSTRUCTION PLANS


CONSTRUCTION.

- DO NOT SCALE DIMENSIONS FROM DRAWINGS.
- 2. THE CONTRACTOR SHALL VERIFY THAT ACTUAL FIELD MEASUREMENTS AND CONDITIONS COMPLY WITH CONTRACT DOCUMENTS AND SHALL BE RESPONSIBLE FOR IDENTIFYING ANY DEVIATIONS FROM THE CONTRACT DOCUMENTS PRIOR TO SUBMITTAL OF SHOP DRAWING TO THE ARCHITECT FOR REVIEW
- 3. STRUCTURAL DOCUMENTS MUST BE WORKED TOGETHER WITH ARCHITECTURAL DOCUMENTS IN ORDER TO: a.CHECK AND COORDINATE ALL DIMENSIONS; ALL DISCREPANCIES MUST BE BROUGHT TO THE ATTENTION OF THE ARCHITECT. b.CHECK ALL PLANS. THOROUGHLY AND BRING ANY DISCREPANCY TO THE ATTENTION OF THE ARCHITECT.

SUBMITTALS:


I. SUBMIT SHOP DRAWINGS FOR ALL SPECIFIED MATERIALS AND PROCEDURES FOR REPAIR AND INSTALLATION. 2. SUBMIT SHORING SHOP DRAWINGS.



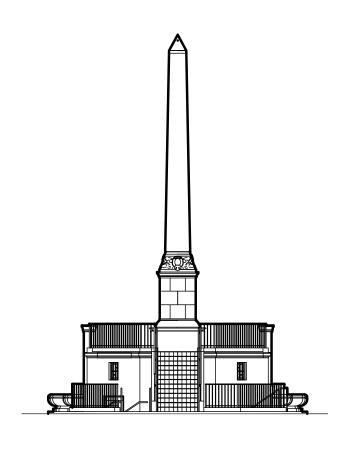

28th STREET OBELISK AND PUMP STATION RESTORATION

300 WEST 28th STREET MIAMI BEACH, FL. 33139

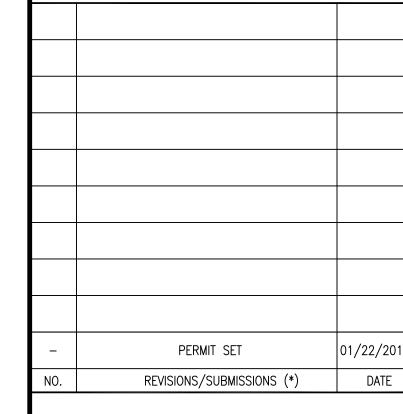

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MIAMI, FLORIDA 33138 305-672-8381 FL #AA0003400 - FL #AR0013832

STRUCTURAL ENGINEER

INGELMO ASSOCIATES P.A. 250 CATALONIA AVENUE, SUITE 301 CORAL GABLES, FL 33134 305-461-6009

MEP ENGINEER MAQUEIRA ENGINEERING CONSULTANTS 7220 S.W. 39th TERRACE 305-444-8210


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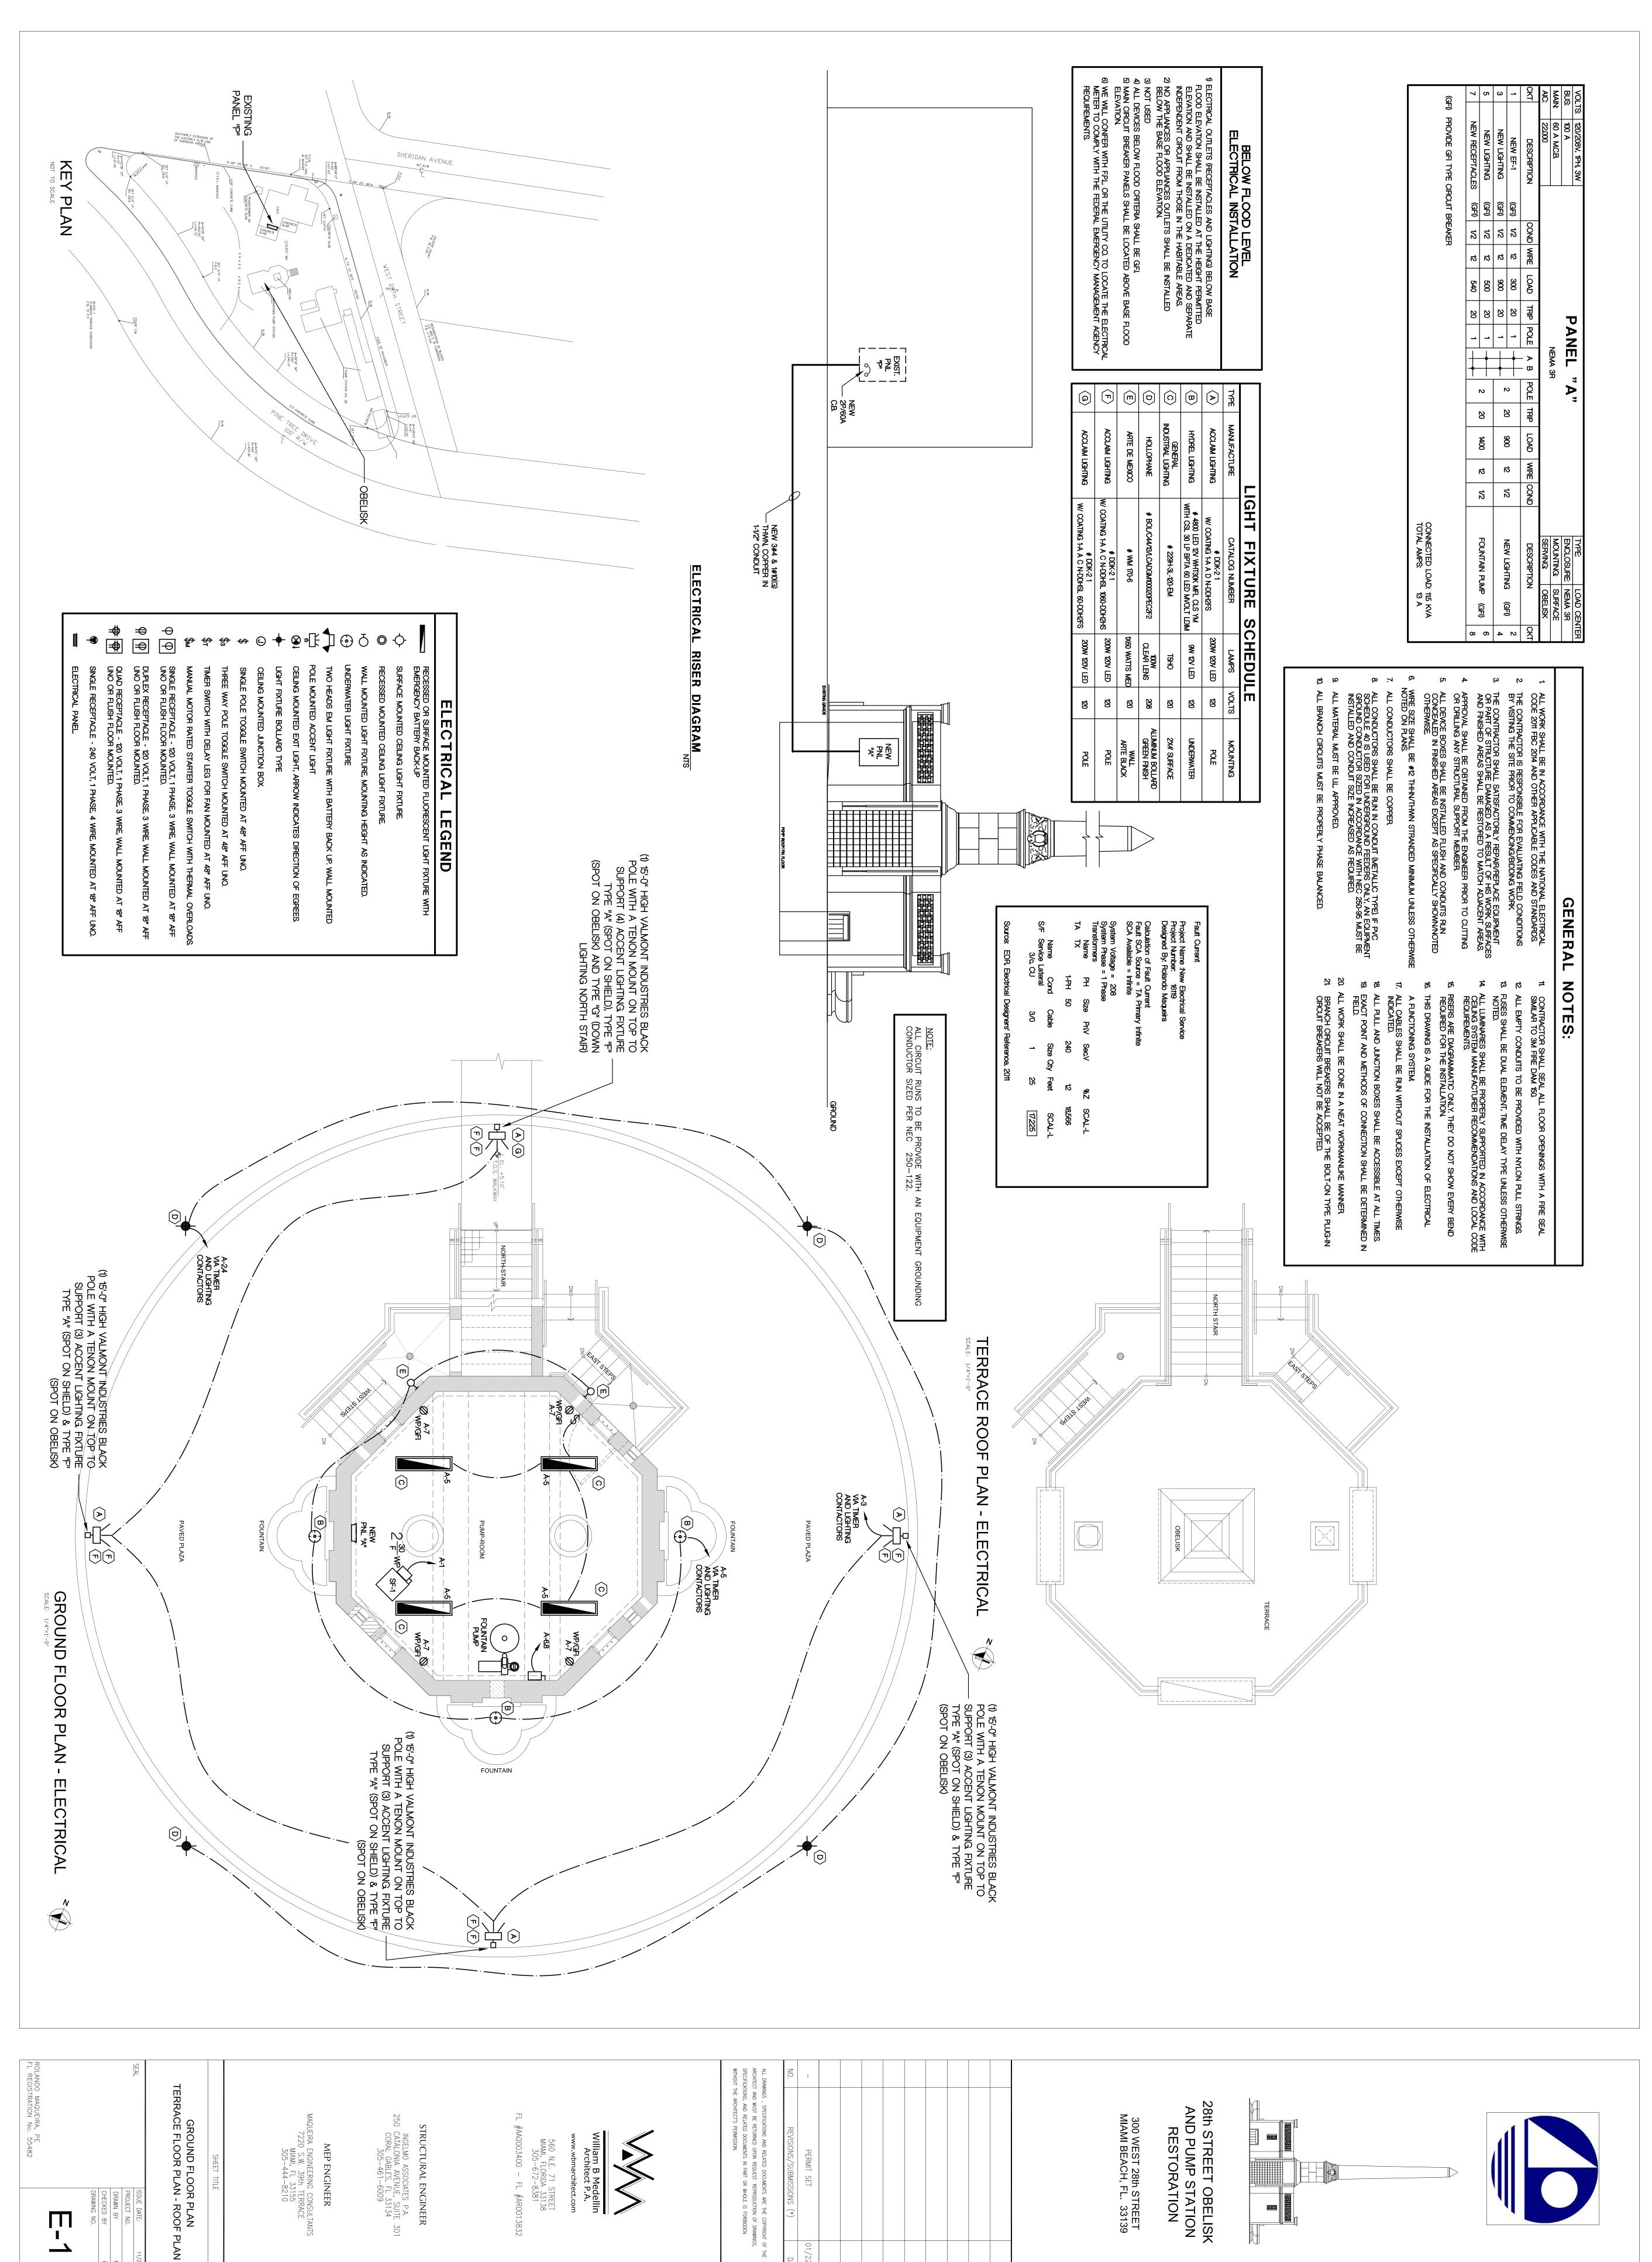
NOTES AND DETAILS

ISSUE DATE: 11/24/2017 PROJECT NO. 121555 DRAWING NO.

PAUL INGELMO PE

ICENSE NO. PE29310 CA 26864



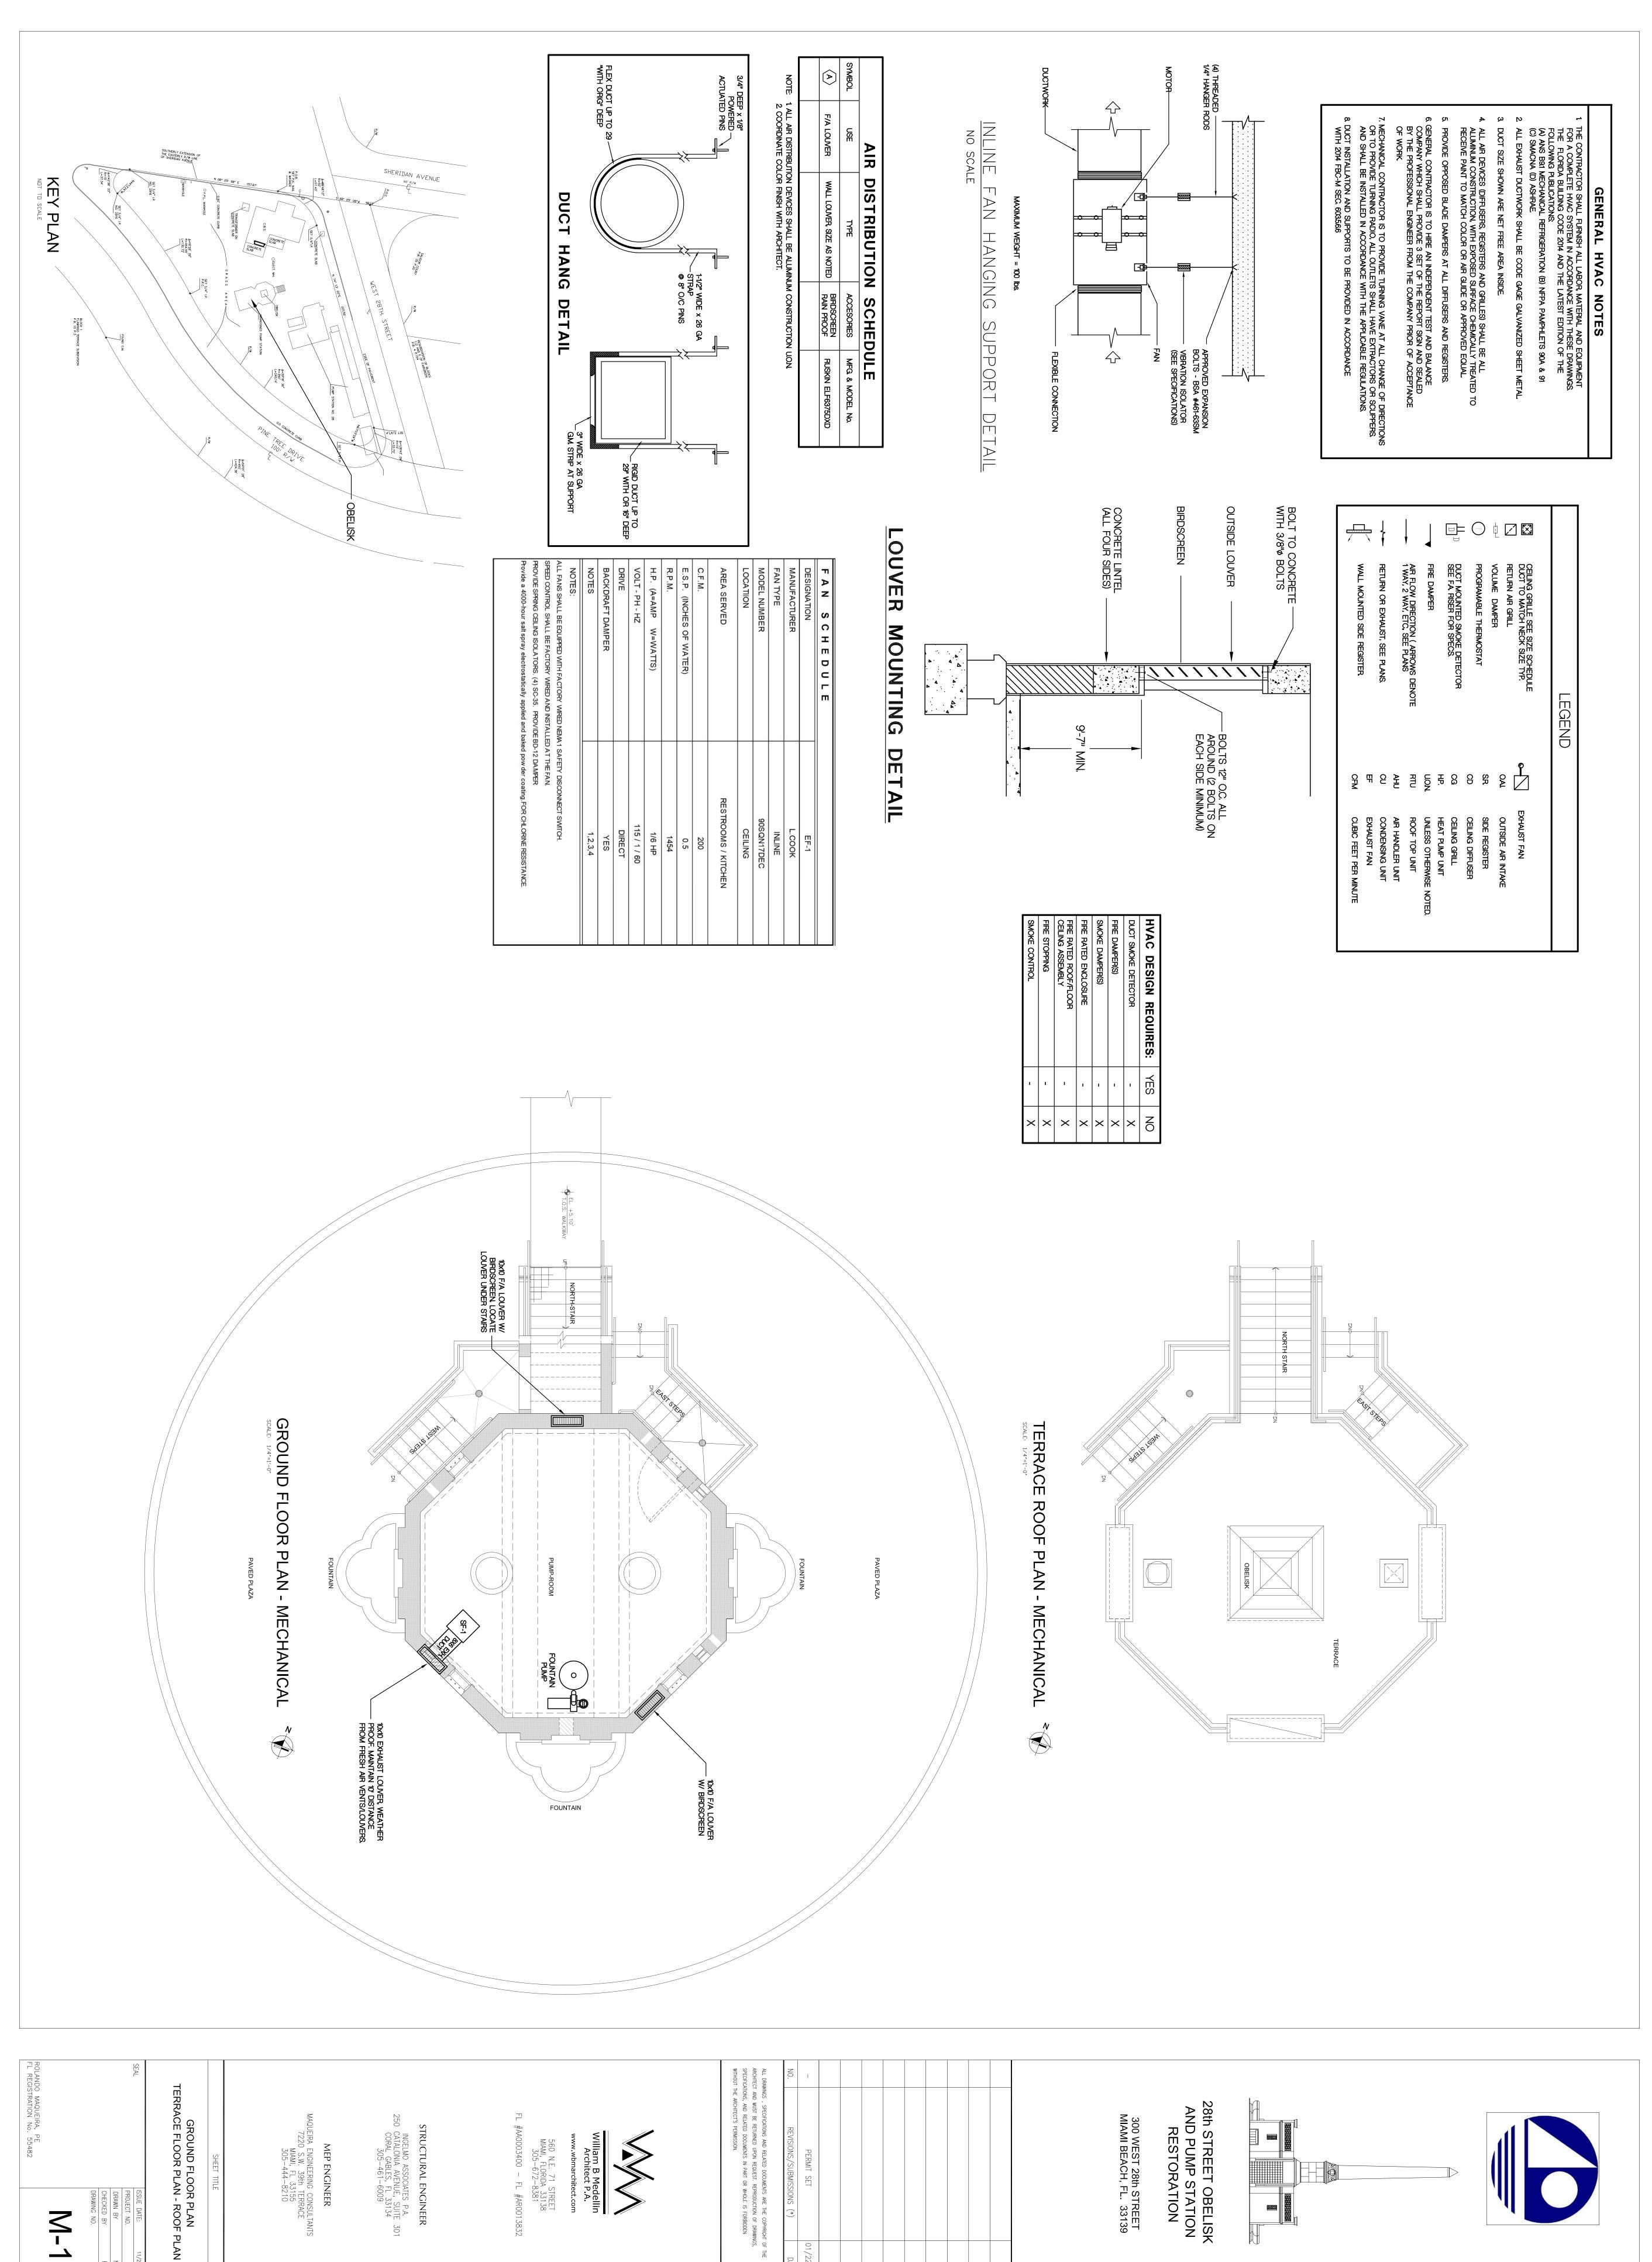

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