RATED PARTITIONS

DOOR NUMBERS

NORTH ARROW SYMBOL

DRAWING REVISION

FLOOR DRAIN

<u>SPRINKLERS</u>

SMOKE DETECTOR

O FD

FIRE HOSE CABINET

(RECESSED AND SURFACE MOUNTED)

(RECESSED AND SURFACE MOUNTED)

FIRE EXTINGUISHER CABINET

CARBON MONOXIDE DETECTOR

TOILET EXHAUST LOUVER

**ALIGNMENT OF SURFACES** 

DIFFUSER GRILL

LINEAR DIFFUSER

UTILITY BOX

<u>WD</u>

ONE-HOUR RATED

TWO-HOUR RATED

- DOOR TYPE

REVISION NUMBER

**COMMUNICATION BOX** 

ROOM TITLES & NUMBERS

TYPE OF ROOM
KEY NUMBER

GR XXXXX

TYP KING, QUEEN, DD BED TYPE
BTH TYP-A 01/A-223

PLAN # / SHEET #
BATHROOM CALL OUT
BATHROOM TYPE

ELEVATION MARKERS

T.O.S. FLOOR 23

SHAFT OPENING & MECH. DUCT SYMBOL

X COORDINATE

Y COORDINATE

OPENING SIZE


MATCH LINES

MATCH LINE


PROPERTY LINES

OVER SIZE GRILLE


PLAN AND DETAIL BLOW-UP TARGETS

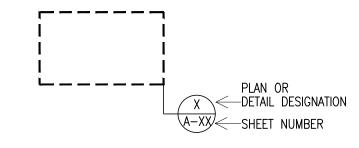

INTERIOR ELEVATION TARGETS

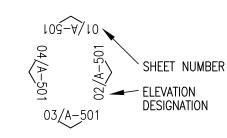

SHEET NUMBER 12/ A-201.00

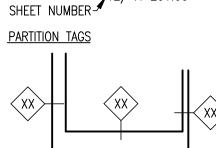

WALL LEGEND

1 HR RATED PARTITION

NEW PARTITION WALL

EXISTING WALL

#### GENERAL NOTES

01. CONTRACTOR TO VERIFY ALL EXISTING CONDITIONS AND NOTIFY ARCHITECT OF ANY DISCREPANCIES WITH PLANS AND AS-BUILT CONDITIONS PRIOR TO PROCEEDING WITH THE WORK.

02. DO NOT SCALE DRAWING; DIMENSION GOVERN. WHERE CONFLICTS OCCUR BETWEEN LARGE AND SMALL SCALE DETAIL DIMENSIONS, NOTIFY ARCHITECT FOR CLARIFICATION.

03. THE CONTRACTOR SHALL OBTAIN AND PAY FOR ALL PERMITS, FEES, INSPECTION FEES AND DEPOSITS REQUIRED BY GOVERNING BODIES HAVING LEGAL JURISDICTION FOR THE INSTALLATION OF ALL WORK. CONTRACT SUM SHALL INCLUDE ALL FEES, DEPOSITS, METER CHARGES, AND COORDINATION WITH THE VARIOUS UTILITY COMPANIES FOR SERVICE. FINAL HOOKUP AND CONNECTION TO BE BY BUILDING GENERAL CONTRACTOR. IT SHALL BE THE BUILDING GENERAL CONTRACTOR'S RESPONSIBILITY TO CALL FOR LOCAL INSPECTIONS AND TO OBTAIN APPROVAL FROM LOCAL INSPECTORS.

04. MINIMUM HEADROOM CLEARANCE AT STAIRS SHALL BE 6'-8" TO THE TREAD NOSING.

05. THE CONTRACTOR SHALL GIVE ALL NOTICES AND COMPLY WITH ALL LAWS ORDINANCES, RULES, REGULATIONS, AND LAWFUL ORDERS OF ANY PUBLIC AUTHORITY FOR THE PERFORMANCE OF THE WORK.

06. UNLESS OTHERWISE PROVIDED IN THE CONTRACT DOCUMENTS, THE CONTRACTOR SHALL PROVIDE AND PAY FOR ALL LABOR, MATERIALS, EQUIPMENT, TOOLS, CONSTRUCTION EQUIPMENT, MACHINERY, TRANSPORTATION AND OTHER FACILITIES AND SERVICES NECESSARY FOR PROPER EXECUTION AND COMPLETION OF THE WORK.

07. CONTRACTOR TO SUPPLY REQUIRED SPRINKLER PLANS TO BE APPROVED BY LOCAL FIRE MARSHALL, OWNER'S INSURANCE COMPANY, TENANT'S INSURANCE COMPANY, ARCHITECT AND THE ENGINEER OF RECORD. CONTRACTOR SHALL PAY FOR ALL PERMITS AND FEES REQUIRED TO EXECUTE THE WORK.

08. COORDINATE PLACEMENT OF ALL CEILING ELEMENTS WITH MECHANICAL, ELECTRICAL AND INSTALLER. WHERE DISCREPANCIES EXIST BETWEEN DRAWINGS AND INSTALLATION CONSULT WITH ARCHITECT PRIOR TO PROCEEDING WITH THE

09. WORKMANSHIP, MATERIALS AND INSTALLATIONS SHALL CONFORM TO LATEST EDITIONS OF THE APPLICABLE BUILDING CODES, AS WILL AS APPLICABLE STATE AND LOCAL CODES, TRADE ASSOCIATION STANDARDS THAT HAVE AUTHORITY OVER THIS

10. CONTRACT DRAWINGS AND SPECIFICATIONS REPRESENT FINISHED CONSTRUCTION. THEY DO NOT INDICATE MEANS OR METHODS OF CONSECUTION OF BUILDING AND STRUCTURE. CONTRACTOR SHALL PROVIDE ALL MEASURES NECESSARY TO PROTECT STRUCTURE AND PERSONNEL DURING CONS. SUCH MEASURES SHALL INCLUDE, BUT NOT BE LIMITED TO, BRACING, SHORING OF LOADS DUE TO CONSTRUCTION EQUIPMENT, EXCAVATION PROTECTION, SCAFFOLDING, JOB SITE SAFETY ETC. OBSERVATION VISITS TO THE SITE BY ARCHITECT, OWNER OR ENGINEER SHALL NOT INCLUDE INSPECTION OF ABOVE ITEMS.

11. IT IS THE RESPONSIBILITY OF THE CONTRACTOR TO SUPERVISE AND COORDINATE VARIOUS TRADES IN ALL MECHANICAL AND EQUIPMENT ROOMS TO ALLOW SUFFICIENT ROOM OF ALL EQUIPMENT.

12. STOREFRONT AND CURTAIN WALL SYSTEMS SHOWN ARE THE RESULT OF PRELIMINARY ENGINEERING BY MANUFACTURER. SHOP DRAWINGS SHALL BE SUBMITTED TO ARCHITECT AND ENGINEER PREPARED BY AND BEARING THE SEAL OF A REGISTERED PROFESSIONAL ENGINEER. LOAD CALCULATION SHALL REFLECT SUCH DESIGN VALUES AS REQUIRED BY THE CITY AND OTHER APPLICABLE CODES.

13. THE INSULATION CONTRACTOR IS TO ISSUE CERTIFICATE OF COMPLIANCE TO ARCHITECT AND OWNER UPON COMPLETION OF WORK.

14. ALL SPOILS OF EXCAVATION (PIERS, FOOTINGS, TRENCHES, ETC.) NOT REUSED SHALL BE DISPOSED OF BY THE CONTRACTOR, A S DIRECTED BY THE DEVELOPER.

15. THE CONTRACTOR SHALL NOT STORE BUILDING MATERIALS, STAGE CONSTRUCTION OPERATIONS FROM NOR GAIN ACCESS TO THE CONSTRUCTION SITE OVER ADJACENT PROPERTIES WITHOUT THE WRITTEN CONSENT OF THE BUILDING DEVELOPER.

17. ALL HOLES IN CONCRETE FLOOR SLAB CAUSED BY THE ATTACHMENT OF FORM WORK, BRACING CONSTRUCTION TRAFFIC,

16. ALL WELD BURNS, SCRATCHES, ETC. ON ALL STRUCTURAL STEEL AND METAL DECK SHALL BE PROPERLY CLEANED AND

MATERIAL STORAGE OR OTHER REASONS SHALL BE CLEANED AND PATCHED.

18. PROVIDE GROUND FAULT INTERRUPTERS, IN WET AREAS, AS REQUIRED.

19. CONTRACTOR TO PROVIDE AND INSTALL SMOKE DETECTORS AND FIRE EXTINGUISHERS PER CITY REQUIREMENTS. PROVIDE MOUNTING AND/OR SIGNAGE AS REQUIRED.

20. ALL PIPING AND CONDUIT ON THE EXTERIOR FACE OF THE BUILDING SHALL BE PAINTED TO MATCH THE ADJACENT SURFACE.

21. PARKING SPACES SHALL NOT OBSTRUCT REQUIRED EXITS.

22. CONTRACTOR TO PROVIDE AND INSTALL EXIT AND EMERGENCY LIGHTING PER DRAWINGS AND/OR CITY REQUIREMENTS AND ANY OTHER APPLICABLE CODES.

23. THE FLAME SPREAD RATING FOR ALL MATERIALS SHALL CONFORM TO ALL APPLICABLE CODES.

24. PENETRATIONS THROUGH WALLS OR CEILINGS NOTED TO BE FIRE RATED ARE TO BE SEALED AS REQUIRED TO MAINTAIN THE RATING OF THE WALL OR CEILING. DUCTWORK PENETRATIONS THROUGH RATED ASSEMBLIES SHALL BE PROVIDED WITH AN APPROPRIATELY RATED FIRE DAMPER.

25. THIS FACILITY HAS BEEN DESIGNED WITH THE INTENT TO COMPLY WITH THE AMERICANS WITH DISABILITIES ACT (ADA). GRAPHIC GUIDELINES FOR CLEARANCES AT DOORS AND TOILET ROOMS HAVE BEEN PROVIDED FOR REFERENCE. WHERE DIMENSIONS INDICATED OR PRODUCTS SPECIFIED HEREIN DO NOT COMPLY WITH GUIDELINES NOTIFY THE ARCHITECT IN WRITING PRIOR TO ORDERING THE ITEM IN QUESTION OR CONSTRUCTION OF THE AFFECTED ASSEMBLY.

26. STAGGER ALL JOINTS OF GYPSUM BOARD CONSTRUCTION.

INSTALLED AT NO ADDITIONAL COST TO THE OWNER.

27. WHERE POSSIBLE, LAYOUT WALLS FROM INTERIOR COLUMN LINES.

28. ALL WOOD BLOCKING, FRAMING AND PLYWOOD TO BE FIRE RETARDANT TREATED AND U.L. NON-COMBUSTIBLE RATED. ALL WOOD IN CONTACT WITH MASONRY OR EARTH SHALL BE WOLMANIZED.

29. THE CONTRACTOR SHALL COORDINATE AND PROVIDE ALL SLAB AND WALL OPENINGS REQUIRED BY MECHANICAL AND ELECTRICAL DRAWINGS.

30. ESTABLISH AND VERIFY ALL OPENINGS AND INSERTS FOR ARCHITECTURAL, MECHANICAL, ELECTRICAL AND PLUMBING, AND ASSOCIATED WORK PRIOR TO CONSTRUCTION.

31. DETAILS NOT SHOWN ARE SIMILAR IN CHARACTER TO THOSE DETAILED. WHERE SPECIFIC DIMENSIONS, DETAILS OR DESIGN INTENT CANNOT BE DETERMINED, THE CONTRACTOR IS TO CONSULT THE ARCHITECT BEFORE PROCEEDING WITH ANY CONSTRUCTION.

32. ALL GYPSUM BOARD PARTITIONS SHALL BE TAPED, BEDDED AND PAINTED UNLESS NOTED OTHERWISE.

33. SHEET METAL WORK SHALL CONFORM TO LATEST S.M.A.C.N.A. STANDARDS. SOLDER ALL SEAMS AND CONNECTIONS.

34. ARCHITECT RESERVES THE RIGHT TO DIRECT REMOVAL AND REINSTALLATION OF WORK WHICH DOES NOT, THE OPTION OF THE ARCHITECT, MAINTAIN STANDARDS AND WORKMANSHIP OF A CRAFT.

35. SHOP DRAWINGS ARE TO COMPLIMENT AND SUPPLEMENT CONSTRUCTION DOCUMENTS. WHEN CONFLICTING INFORMATION IS PROVIDED IN SHOP DRAWINGS AND CONSTRUCTION DOCUMENTS, NOTIFY ARCHITECT PRIOR TO FABRICATION. REVIEW OF SHOP DRAWINGS BY ARCHITECT DOES NOT RELIEVE CONTRACTOR OF RESPONSIBILITY FOR CONFORMANCE WITH CONSTRUCTION DOCUMENTS. SHOP DRAWINGS SHALL BE SUBMITTED FOR ALL MILLWORK, UNLESS NOTED "SUPPLIED BY TENANT".

36. THESE DOCUMENTS ARE NOT TO BE REPRODUCED OR USED FOR ANY PURPOSE OTHER THAN ORIGINALLY ISSUED UNLESS AUTHORIZED IN WRITING BY ARCHITECT.

37. ALL MEASUREMENTS ARE SUBJECT TO VERIFICATION IN THE FIELD BY THE CONTRACTOR. THE CONTRACTOR SHALL NOTIFY THE ARCHITECT OF ANY DISCREPANCIES PRIOR TO FABRICATION OR CONSTRUCTION.

38. NOTIFY ARCHITECT OF CONFLICT IN DETAILS OR GENERAL NOTES AND TYP. DETAILS. WHERE NO SPECIFIC DETAILS ARE SHOWN, CONSTRUCTION SHALL CONFORM TO SIMILAR WORK IN THE PROJECT AND APPLICABLE CODES. IN CASE OF PLAN LOCATION CONFLICTS BETWEEN DISCIPLINES, NOTIFY ARCHITECT.

39. CONTRACTOR SHALL PROVIDE BACKING BEHIND FINISHED WALL AND CEILING SURFACES FOR SUPPORT AND ATTACHMENT OF CASEWORK, SHELVING, MIRRORS, PEGBOARDS, COUNTERS, TOILET PARTITIONS, DOOR WALL STOPS AND ACCESSORIES, ETC.

40. THE CONTRACTOR SHALL BE RESPONSIBLE TO MAINTAIN THE BUILDING AND SITE CLEAN, AND PROVIDE ALL AND ANY

SAFETY PROVISIONS TO INSURE THE PUBLIC SAFETY.

41. MATERIALS, EQUIPMENT, ETC. NOT INDICATED ON DRAWINGS OR SPECIFIED HEREIN BUT REQUIRED FOR SUCCESSFUL AND SUFFICIENT COMPLETION OF THE INSTALLATION SHALL BE HELD TO BE IMPLIED AND SHALL BE FURNISHED AND

## GENERAL NOTES (CONT.)

42. ALL MATERIALS AND EQUIPMENT FURNISHED BY CONTRACTORS SHALL BE NEW AND FREE FROM DEFECTS. DAMAGED WORK MUST BE REPLACED AT NO ADDITIONAL COST TO THE OWNER.

43. ALL PRODUCTS AND MATERIALS SHALL BE INSTALLED IN ACCORDANCE WITH THE MANUFACTURER'S INSTRUCTIONS UNLESS SPECIFICALLY NOTED TO THE CONTRARY.

44. CONTRACTOR TO VERIFY ALL INFORMATION ON DRAWINGS AND REPORT ANY DISCREPANCIES OR OMISSIONS TO ARCHITECT PRIOR TO COMMENCING ANY AFFECTED WORK.

45. FINISHED FLOOR ELEVATIONS ARE TO DESIGNED TOP OF CONCRETE OR TOP OF STONE UNLESS NOTED OTHERWISE.

46. CEILING HEIGHT DIMENSIONS ARE FROM DESIGNED FINISHED FLOOR TO FINISHED CEILING SURFACES UNLESS NOTED OTHERWISE.

47. ANY DECORATIONS ON INTERIOR WALLS OR CEILINGS SHALL BE NON—CONBUSTABLE OR FIRE RETARDANT TREATED TO COMPLY WITH FLAME SPREAD AND SMOKE DEVELOPMENT CODE REQUIREMENTS.

48. ALL STRUCTURAL STEEL SHALL HAVE SPRAY ON FIREPROOFING PER FIRE RESISTIVE REQUIREMENTS OF THE APPLICABLE CODES AND THE SPECIFICATIONS.

49. CONCRETE HOUSEKEEPING PADS UNDER ALL MECHANICAL AND ELECTRICAL EQUIPMENT ARE TO BE HIGH MINIMUM. 3000 PSI LIGHTWEIGHT CONC. WITH ONE LAYER MIN. OF 6X6 / 1.4X1.4 WELDED WIRE FABRIC, UNLESS OTHERWISE NOTED.

50. MECHANICAL AIR SHAFT WALL SHALL BE INSTALLED TO WITHSTAND AN INWARD AND OUTWARD ACTING PRESSURE OF 7.5 LBS/SQUARE FOOT MINIMUM. ELEVATOR SHAFT WALLS SHALL BE INSTALLED TO WITHSTAND AND INWARD AND OUTWARD ACTING PRESSURE OF 7.5 LBS PER SQ. FT MIN.

51. PROVIDE ONE HOUR RATED WALL CONSTRUCTION FOR ALL ELECTRICAL AND TELEPHONE ROOMS UNLESS NOTED OTHERWISE. PROVIDE TWO HOUR RATED WALL CONSTRUCTION FOR ALL SHAFT AND STAIR ENCLOSURES.

52. ALL DISSIMILAR METALS SHALL BE EFFECTIVELY ISOLATED FROM EACH OTHER TO PREVENT MOLECULAR AND GALVANIC ACTION.

53. ALL ELEVATOR OPENINGS SHALL BE CERTIFIED BY ELEVATOR SUBCONTRACTOR PRIOR TO FORMING. IF MODIFICATIONS ARE REQUIRED, THE CONTRACTOR SHALL BRING SUCH MODIFICATIONS TO THE ATTENTION OF THE OWNER PRIOR TO FORMING.

54. ENTRANCES AND VERTICAL CLEARANCES FOR NON-HANDICAP AREAS IN PARKING GARAGES SHALL BE A MIN. OF 7'-0". CLEAR HEIGHT SHALL BE MAINTAINED UNOBSTRUCTED INCLUDING BEAMS. PIPING, LIGHTING, EXIT SIGNS, ETC.

55. PROVIDE COLLISION BARRIERS ADEQUATE TO PROTECT ALL CONTROL METERS, REGULATORS, AND PIPING FOR HAZARDOUS MATERIALS THAT ARE EXPOSED TO VEHICULAR DAMAGE. CONSULT WITH ARCHITECT PRIOR TO INSTALLATION.

56. EACH PVC PIPE RUNNING ADJACENT TO A COLUMN IN THE PARKING GARAGE AREAS SHALL BE SLEEVED WITHIN A GALVANIZED 18 GAUGE CORNER GUARD BOLTED TO THE COLUMN. SEE DETAILS.

57. ALL CORNER GUARDS AND BOLLARDS IN PARKING GARAGE AREAS TO BE PAINTED YELLOW.

58. ALL PARKING SPACES TO BE DELINEATED WITH A 4" FLUORESCENT WHITE STRIPE PAINTED ON THE FLOOR.

59. DIFFERENCES IN SLAB ELEVATIONS FROM FINISHED INTERIOR FLOOR ELEVATION TO EXTERIOR FLOOR ELEVATION MUST BE NO GREATER THAN 1/2".

60. ALL WALLS ADJACENT TO HANDICAPPED (H.C.) TOILETS, H.C. TUBS AND H.C JACUZZIS TO RECEIVE A 20 GAUGE 6" STRAP FOR INSTALLATION OF HANDICAP GRAB BARS.

61. ALL WALLS TO BE TILED TO BE CLAD WITH CEMENT BOARD ALL OTHER WALLS IN WET AREAS TO BE MOISTURE RESISTANT GYPSUM BOARD. SEE SCHEDULE.

62. REFER TO M.E.P. DRAWINGS FOR EXACT A/C CHASE DIMENSIONS.

#### INTERIOR FINISHES—FIRE NOTE:

1. FLAME SPREAD RATING FOR CEILING AND WALLS SHALL BE CLASS B OR

2. FLAME SPREAD FOR DECORATIVE MATERIALS AND TRIM MAY BE CLASS C OR

HIGHER

3. FLOORS MAY BE CLASS I OR CLASS II

4. ALL WOOD FINISHES TO BE FIRE RETARDANT WOOD
5. ALL FLOORING MATERIAL TO ALLOW FOR A MAXIMUM 1/2 "THRESHOLD AND

TRANSITION AT EACH SIDE OF DOOR.

6 ALL WOOD MATERIAL SHALL BE INHERENTLY FIRE RETARDANT

7. ALL NEW FINISHES (WALL/CEILING/TRIM/DECOR) ARE TO COMPLY WITH FBCB CHAPTER 8 FOR FLAME SPREAD AND SMOKE DEVELOPMENT CLASS REQUIREMENTS.

#### ASBESTOS NOTE:

THE OWNER HAS NO KNOWN KNOWLEDGE OF ASBESTOS MATERIAL IN THE AREAS OF WORK PROPOSED. REFER TO OWNER'S ASBESTOS REPORT & SURVEY OF THE AREAS OF WORK FOR ADDITIONAL INFORMATION.

#### MEP/FP BUILDING DEPT. NOTE:

. CAP WATER SUPPLY AT SOURCE AND CAP WASTE AT SLAB.

PROTECT FIRE ALARM SYSTEM SPEAKERS AND ASSOCIATED WIRING FROM DUST, PAINT, AND ANY TYPE OF DAMAGE DURING CONSTRUCTION

3. THE SMOKE DETECTORS SHOULD NOT BE ON MORE THAN 1 BRANCH

CIRCUIT.

4. OTHER THAN OUTLETS SHOWN IN DEMO AND RENOVATED AREAS, ALL OTHER OUTLETS LAYOUT TO REMAIN AS EXISTING.

SMOKE DETECTOR NOTE:

1. PROVIDE INTERCONNECTED SMOKE LARMS IN COMPLIANCE WITH FBCE 704.3

1. PROVIDE INTERCONNECTED SMOKE LARMS IN COMPLIANCE WITH FBCE 704.3
2. FIELD VERIFY LOCATION OF EXISTING S.D.
3. S.D. SHALL BE NO LESS THAN 36" FROM A/C SUPPLY
FIRE ALARM/FSP NOTE:

E ALARM/FSP NOTÉ:

CONTRACTOR SHALL PROVIDE FIRE ALARM AND SPRINKLER SHOP DRAWINGS

FOR SUBMITIAL

#### SOUNDPROOFING NOTE:

 ALL FLOORING TO HAVE SOUNDPROOFING UNDERLAYMENT MATERIAL IN ALL ARFAS.

SOUNDPROOFING TO HAVE AN STC RATING OF 55 (MIN) CLASS II C
 IIC RATING OF 50 MIN WHEN TESTED PER ASTM E 492

4. ALL SOUNDPROOFING TO FOLLOW SECTION 1207 FBC

#### GLAZING NOTE:

1. NO GLAZING IN THIS SCORE OF WORK.

2. PER FBCB 2406—ANY GLAZING IN BATHROOMS, GUARDRAILS, OR HAZARDOUS LOCATIONS TO BE CATEGORY II.

#### PUBLIC WORKS NOTE:

1. AT RIGHT OF WAY AREAS ADJACENT TO LOT/PARCEL BEING
DEVELOPED/IMPROVED/ALTERED/MODIFIED AND CONSTRUCTION STAGING
AREAS: ALL MISSING, BROKEN, RACKED, UPLIFTED, AND DAMANGED SIDEWALK,
CURB & GUTTER, SWALE AREA, DRAINAGE STRUCTURE, PAVEMENT SHALL BE
CONSTRUCTED RECONSTRUCTED, REPAIRED, MILLED AND RESURFACED PRIOR
TO PUBLIC WORKS TCO/CO APPROVAL. ALL IMPROVEMENTS SHALL BE
ACCORDING TO CITY OF MIAMI BEACH PUBLIC WORKS ENGINEERING
STANDARDS AND BULLETINS. SEPARATE PUBLIC WORKS PERMITS ARE
REQUIRED FOR IMPROVEMENTS WITHIN RIGHT OF WAY AREAS.

## PROJECT DATA



#### ADDRESS

1418 OCEAN DRIVE MIAMI BEACH, FL 33139

FOLIO NUMBER

#### 02-3234-185-0450

THE PENGUIN CONDO
UNIT CU
UNDIV16.111/13395.115
INT IN COMMON ELEMENTS

OFF REC24728-0812

OR 24694-0248 0706 2

#### CONSTRUCTION & OCCUPANCY:

TYPE OF CONSTRUCTION: 3-A
THIS IS A FULLY SPRINKLERED BUILDING WITH EXISTING FIRE ALARM. ALL
EXISTING SPRINKLERS ANUNCIATORS, PULL STATIONS TO REMAIN IN OPERATION
DURING CONSTRUCTION.

OCCUPANCY TYPE: R1

#### ZONING

ZONING DESIGNATION: RM-3

#### APPLICABLE CODES AND STANDARDS:

FLORIDA BUILDING CODE 2017/FLORIDA BUILDING CODE 2017 EXISTING BLDG.
 FLORIDA ACCESSIBILITY CODE 2017
 FLORIDA FIRE PREVENTION CODE (6TH EDITION 43.1.1.
 NFPA 1 / 101, 2012 EDITION

#### SCOPE OF WORK

CLASS. OF WORK

ALTERATION LEVEL: LEVEL 2 (PER CHAPTER 5 SECTION 504.1 & 504.2)

LEVEL 2 ALTERATIONS INCLUDE THE RECONFIGURATION OF SPACE, THE ADDITION

OR ELIMINATION FO ANY DOOR OR WINDOW, THE RECONFIGURATION OR EXTENSION

OF ANY SYSTEM, OR THE INSTALLATION OF ANY ADDITIONAL EQUIPMENT.

CHANGE OF USE FROM CU2 USE TO RESIDENTIAL HOTEL USE

#### ARCHIT

ARCHITECTURAL: DEMOLITION:

1. DEMOLITION:

1. DEMOLISH ALL INTERIOR FINISHES OF DESIGNATED SPACE

 REMOVE ALL EQUIPMENT, MECHANICAL UNITS OF THE DESIGNATED SPACE

3. CAP ALL UTILITIES AND MEP SERVICES

4. MAINTAIN EXISTING LIFE SAFETY DEVICES AND EQUIPMENT.

NEW CONSTRUCTION:

 RE-BUILD ORIGINAL GUESTROOMS PREVIOUS TO EXISTING KITCHEN SPACE

2. BUILD OUT NEW GWB DEMISING PARTITIONS BETWEEN ROOMS

NEW GWB CEILINGS
 NEW BATHROOMS WITH NEW PLUMBING FIXTURES AND

FINISHES

5. NEW WINDOW TO REPLACE EXISTING DOORS

6. NEW GUESTROOM ENTRY DOORS7. NEW HVAC FOR EACH ROOM8. NEW FIRE SPRINKLER LAYOUT FOR EACH ROOM

10. NEW INTERIOR FLOORING AND BASE AND INTERIOR PAINT

9. NEW FIRE ALARM DEVICES FOR EACH ROOM

# THROUGHOUT. AREAS OF WORK;

INTERIOR: 800 SF

AREAS ARE APPROX. AND GC TO PERFORM OWN TAKEOFF FROM THE DRAWINGS

#### SPRINKLER NOTES:

1. THIS IS A FULLY SPRINKLERED BUIDLING
2. SPRINKLER SHOP DRAWINGS TO BE SUBMITTED BY SPRINKLER CONTRACTOR.

# STRUCTURAL NOTE:

1. NO INTERIOR STRUCTURAL BEARING WALL DEMOLITION 2. NO LOAD BEARING WALLS TO BE DEMOLISHED.

#### ARCHITECTURAL DRAWING LIST

G101.00-GENERAL NOTES
D101.00-DEMOLITION
A101.00-CONSTRUCTION PLAN
A102.00-UL DETAILS AND PARTITION TYPES
A103.00-DETAILS

AIA

Notes: Date

BLDG. DEPT 11.15.19

CORRECTIONS 02.11.20

+JMJ+

Owner:
Penguin Hotel Corp
1418 Ocean Drive
Miami Beach, FL 33139


Architect:
Juan J. Alayo, AIA
2307 Douglas Road
Suite 503
Miami, FL 33145
Tel: 305.322.1280
Florida Professional License# AR 0016549

Penguin Hotel Ground Floor Renovation Permit Set


Miami Beach, Florida

**Building Department Notes** 

Submission Date: November 15, 2019
Scale: As Noted
Drawn by: JJA
Project: 261.01

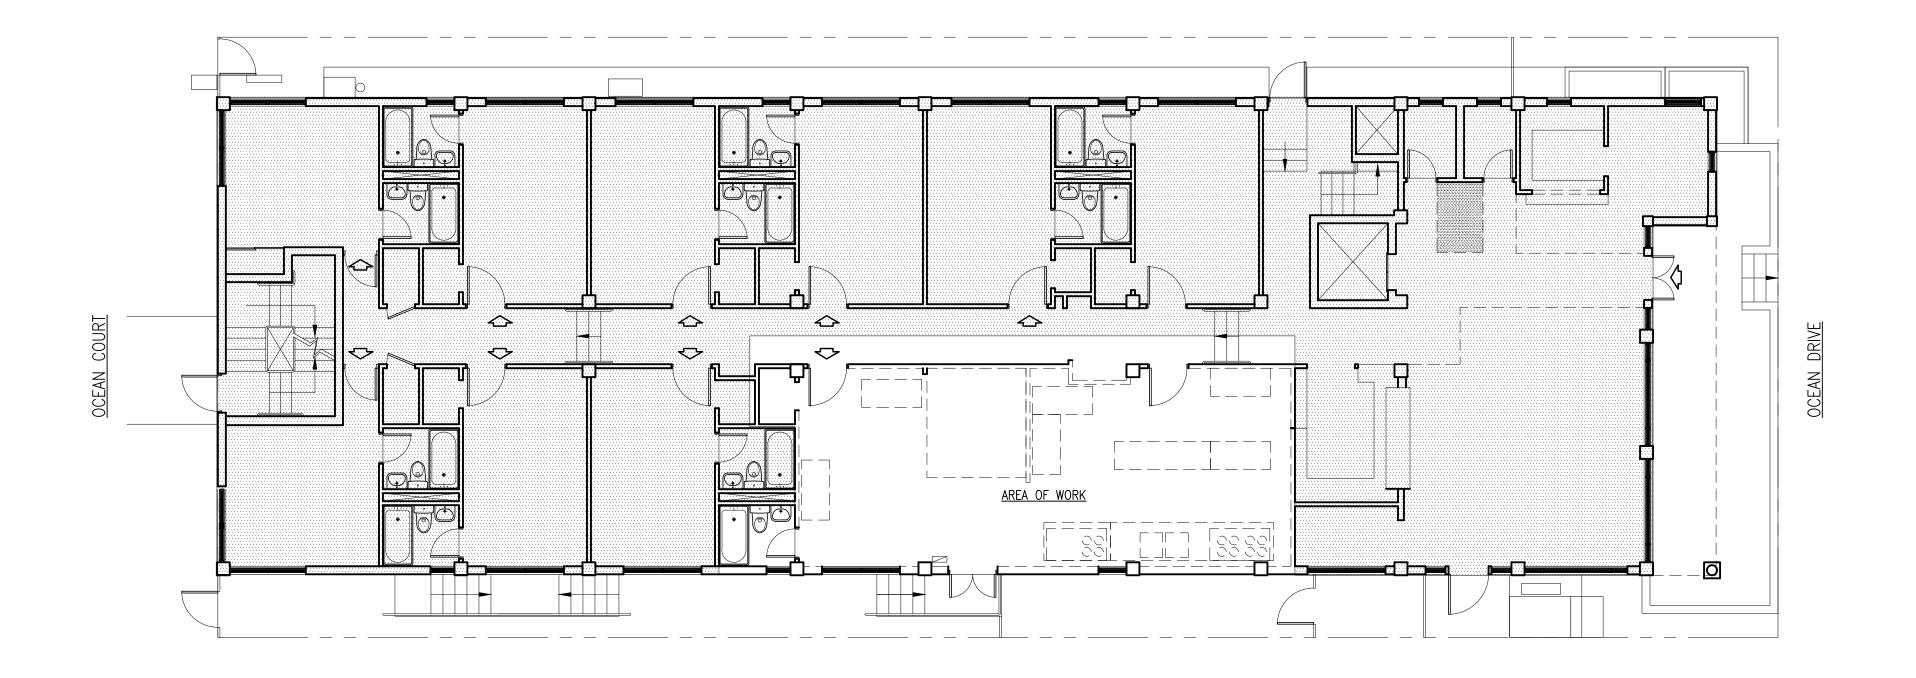

First Floor Demolition Plan (Area of work) Scale: 1/8"=1'-0"

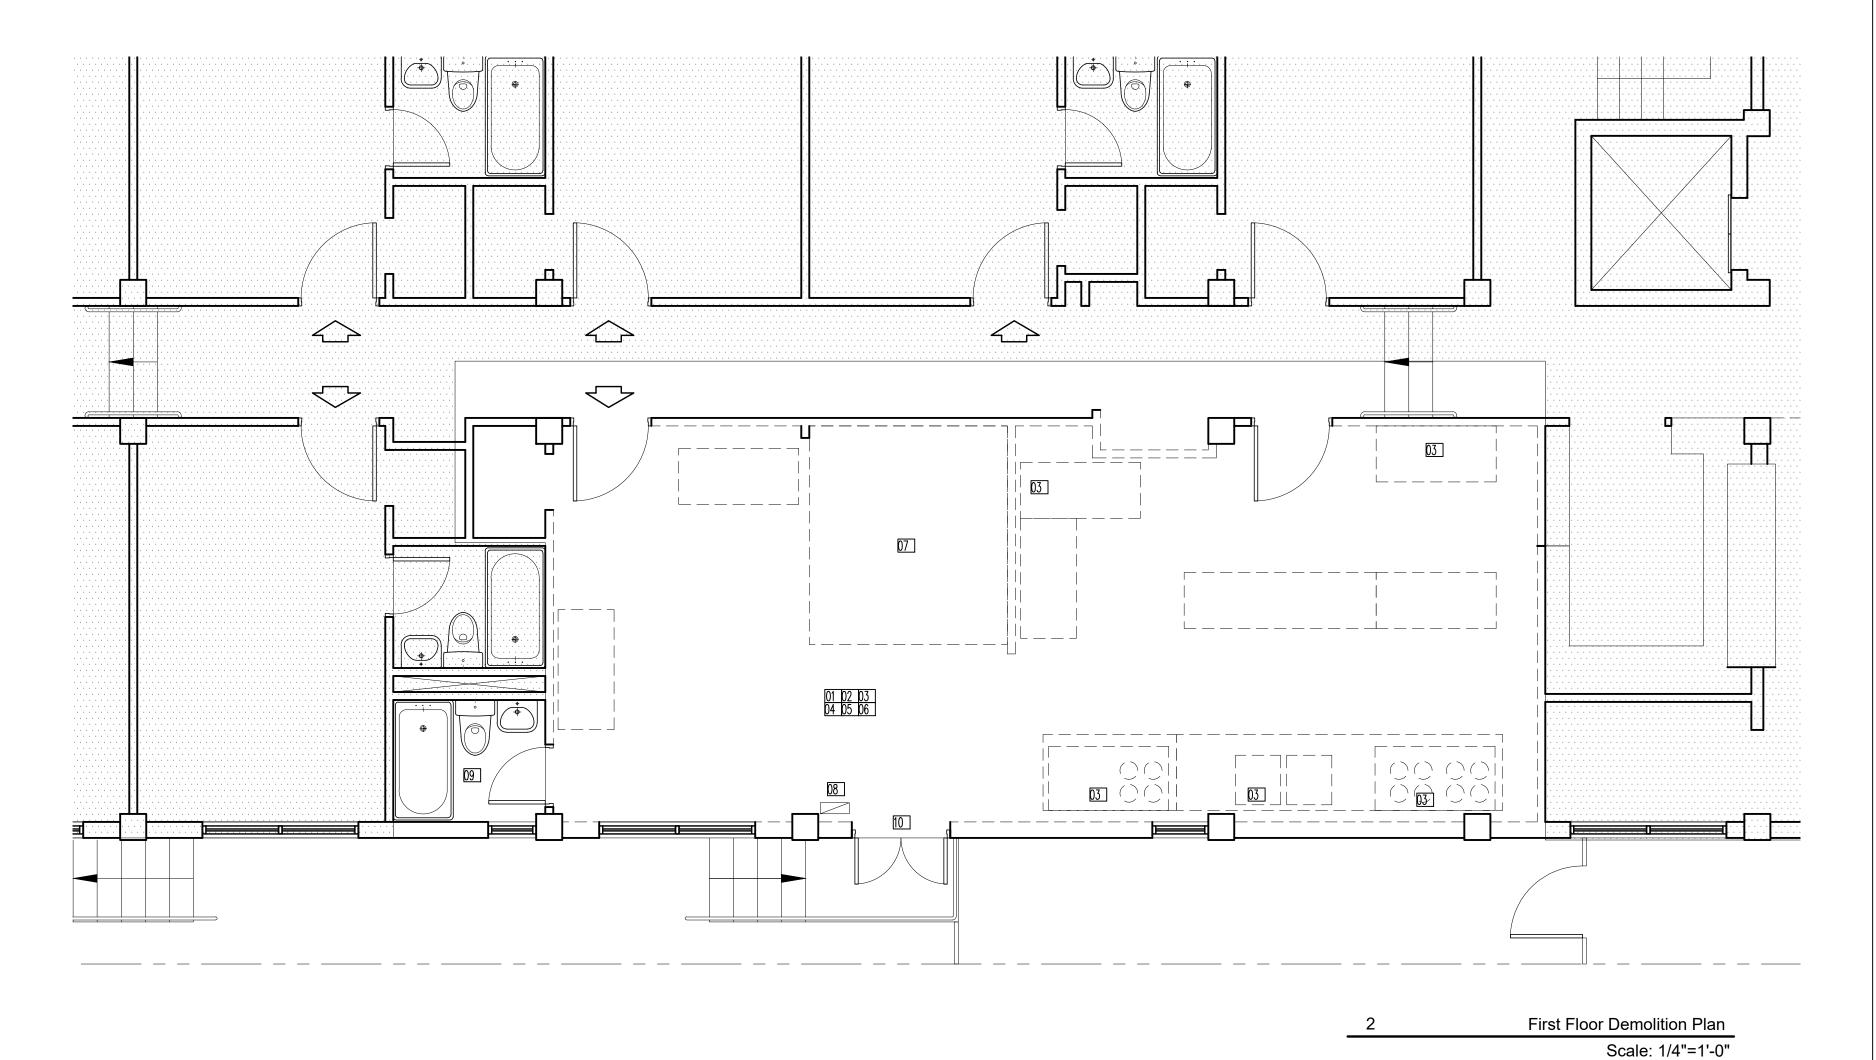

+JMJ+

Notes: Date BLDG. DEPT 11.15.19 02.11.20 CORRECTIONS

**GENERAL DEMOLITION NOTES:** 1. GC TO PROTECT ALL ADJACENT AREAS AND MAINTAIN SAFE EGRESS IN THE HOTEL CORRIDOR. 2. REMOVAL OF ALL DEBRIS IS TO BE DONE THROUGH THE SOUTHERN SIDE DOORS. 3. DISCONNECT ALL GAS AND ELECTRIC CONNECTIONS PRIOR TO DEMOLITION. 4. EXHAUST HOOD REMOVAL: REMOVE ALL HOODS, AND ANSUL SYSTEM EQUIPMENT. CAP WALL OPENING/CONNECTION TO MAIN BUILDING KITCHEN EXHAUST RISER. RISER TO REMAIN. 5. PROTECT EXISTING BATHROOM DURING DEMOLITION. 6. CAP AND REMOVE ALL EXISTING FLOOR DRAINS. 7. REMOVE ALL EXISTING CEILINGS AND LIGHTING. 8. REMOVE BUILT IN COOLER 9. REMOVE EXISTING MAKE UP AIR UNIT. 10. REMOVE INTERIOR LAYER OF GWB AND INSULATION. 11. REMOVE TILE FLOORING AND BASE 12. CAP ALL WATER CONNECTIONS AND ABANDON. 13. LEAVE TEMPORARY LIGHTING IN SPACE AFTER 14. LEAVE FIRE SPRINKLERS OPERATIONAL AND PROVIDE COVERAGE. 15. EQUIPMENT REMOVAL BY OWNER 16. NO STRUCTURAL DEMOLITION FIRE DEPARTMENT NOTES: 1. BUILDING IS TO REMAIN OCCUPIED DURING CONSTRUCTION. 2. ALL LIFE SAFETY SYSTEMS SHALL REMAIN ACTIVE AT ALL TIMES (FIRE ALARM/FIRE SPRINKLER/EGRESS) 3. DEMOLITION SCOPE IS CONTAINED WITHIN THE DEMISED AREAS AND DOES NOT HINDER ANY EGRESS VIA THE CORRIDOR OR LOBBY. ALL DEMOLITION DEBRIS REMOVAL SHALL BE VIA THE EXISTING EXTERIOR DOOR ON THE SOUTH SIDE DIRECTLY TO THE OUTSIDE. 

> Owner: Penguin Hotel Corp 1418 Ocean Drive Miami Beach, FL 33139

Architect: Juan J. Alayo, AIA 2307 Douglas Road Suite 503 Miami, FL 33145 Tel: 305.322.1280

Florida Professional License# AR 0016549

#### KEY NOTES:

- 01 REMOVE TILE FLOOR
- 02 REMOVE CEILINGS
- O3 CAP. ALL PLUMBING AND GAS CONNECTIONS
- 04 REMOVE ALL WALL MOUNTED FINISHES
- 05 REMOVE INTERIOR LAYER OF GWB AND INSULATION
- 06 CAP AND REMOVE EXISTING FLOOR DRAINS
- 07 REMOVE BUILT IN COOLER UNIT
- DISCONNECT ELECTRICAL PANEL 09 KEEP EXISTING BATHROOM OPERATIONAL

10 REMOVE EXISTING DOOR AND PREP. FOR INFILL


Penguin Hotel Ground Floor Renovation Permit Set 1418 Ocean Drive

Miami Beach, Florida



# DEMOLITION PLAN PLAN FIRST FLOOR

Submission Date:	November 15, 2019	D101.00
Scale:	As Noted	
Drawn by:	JJA	
Project:	261.01	

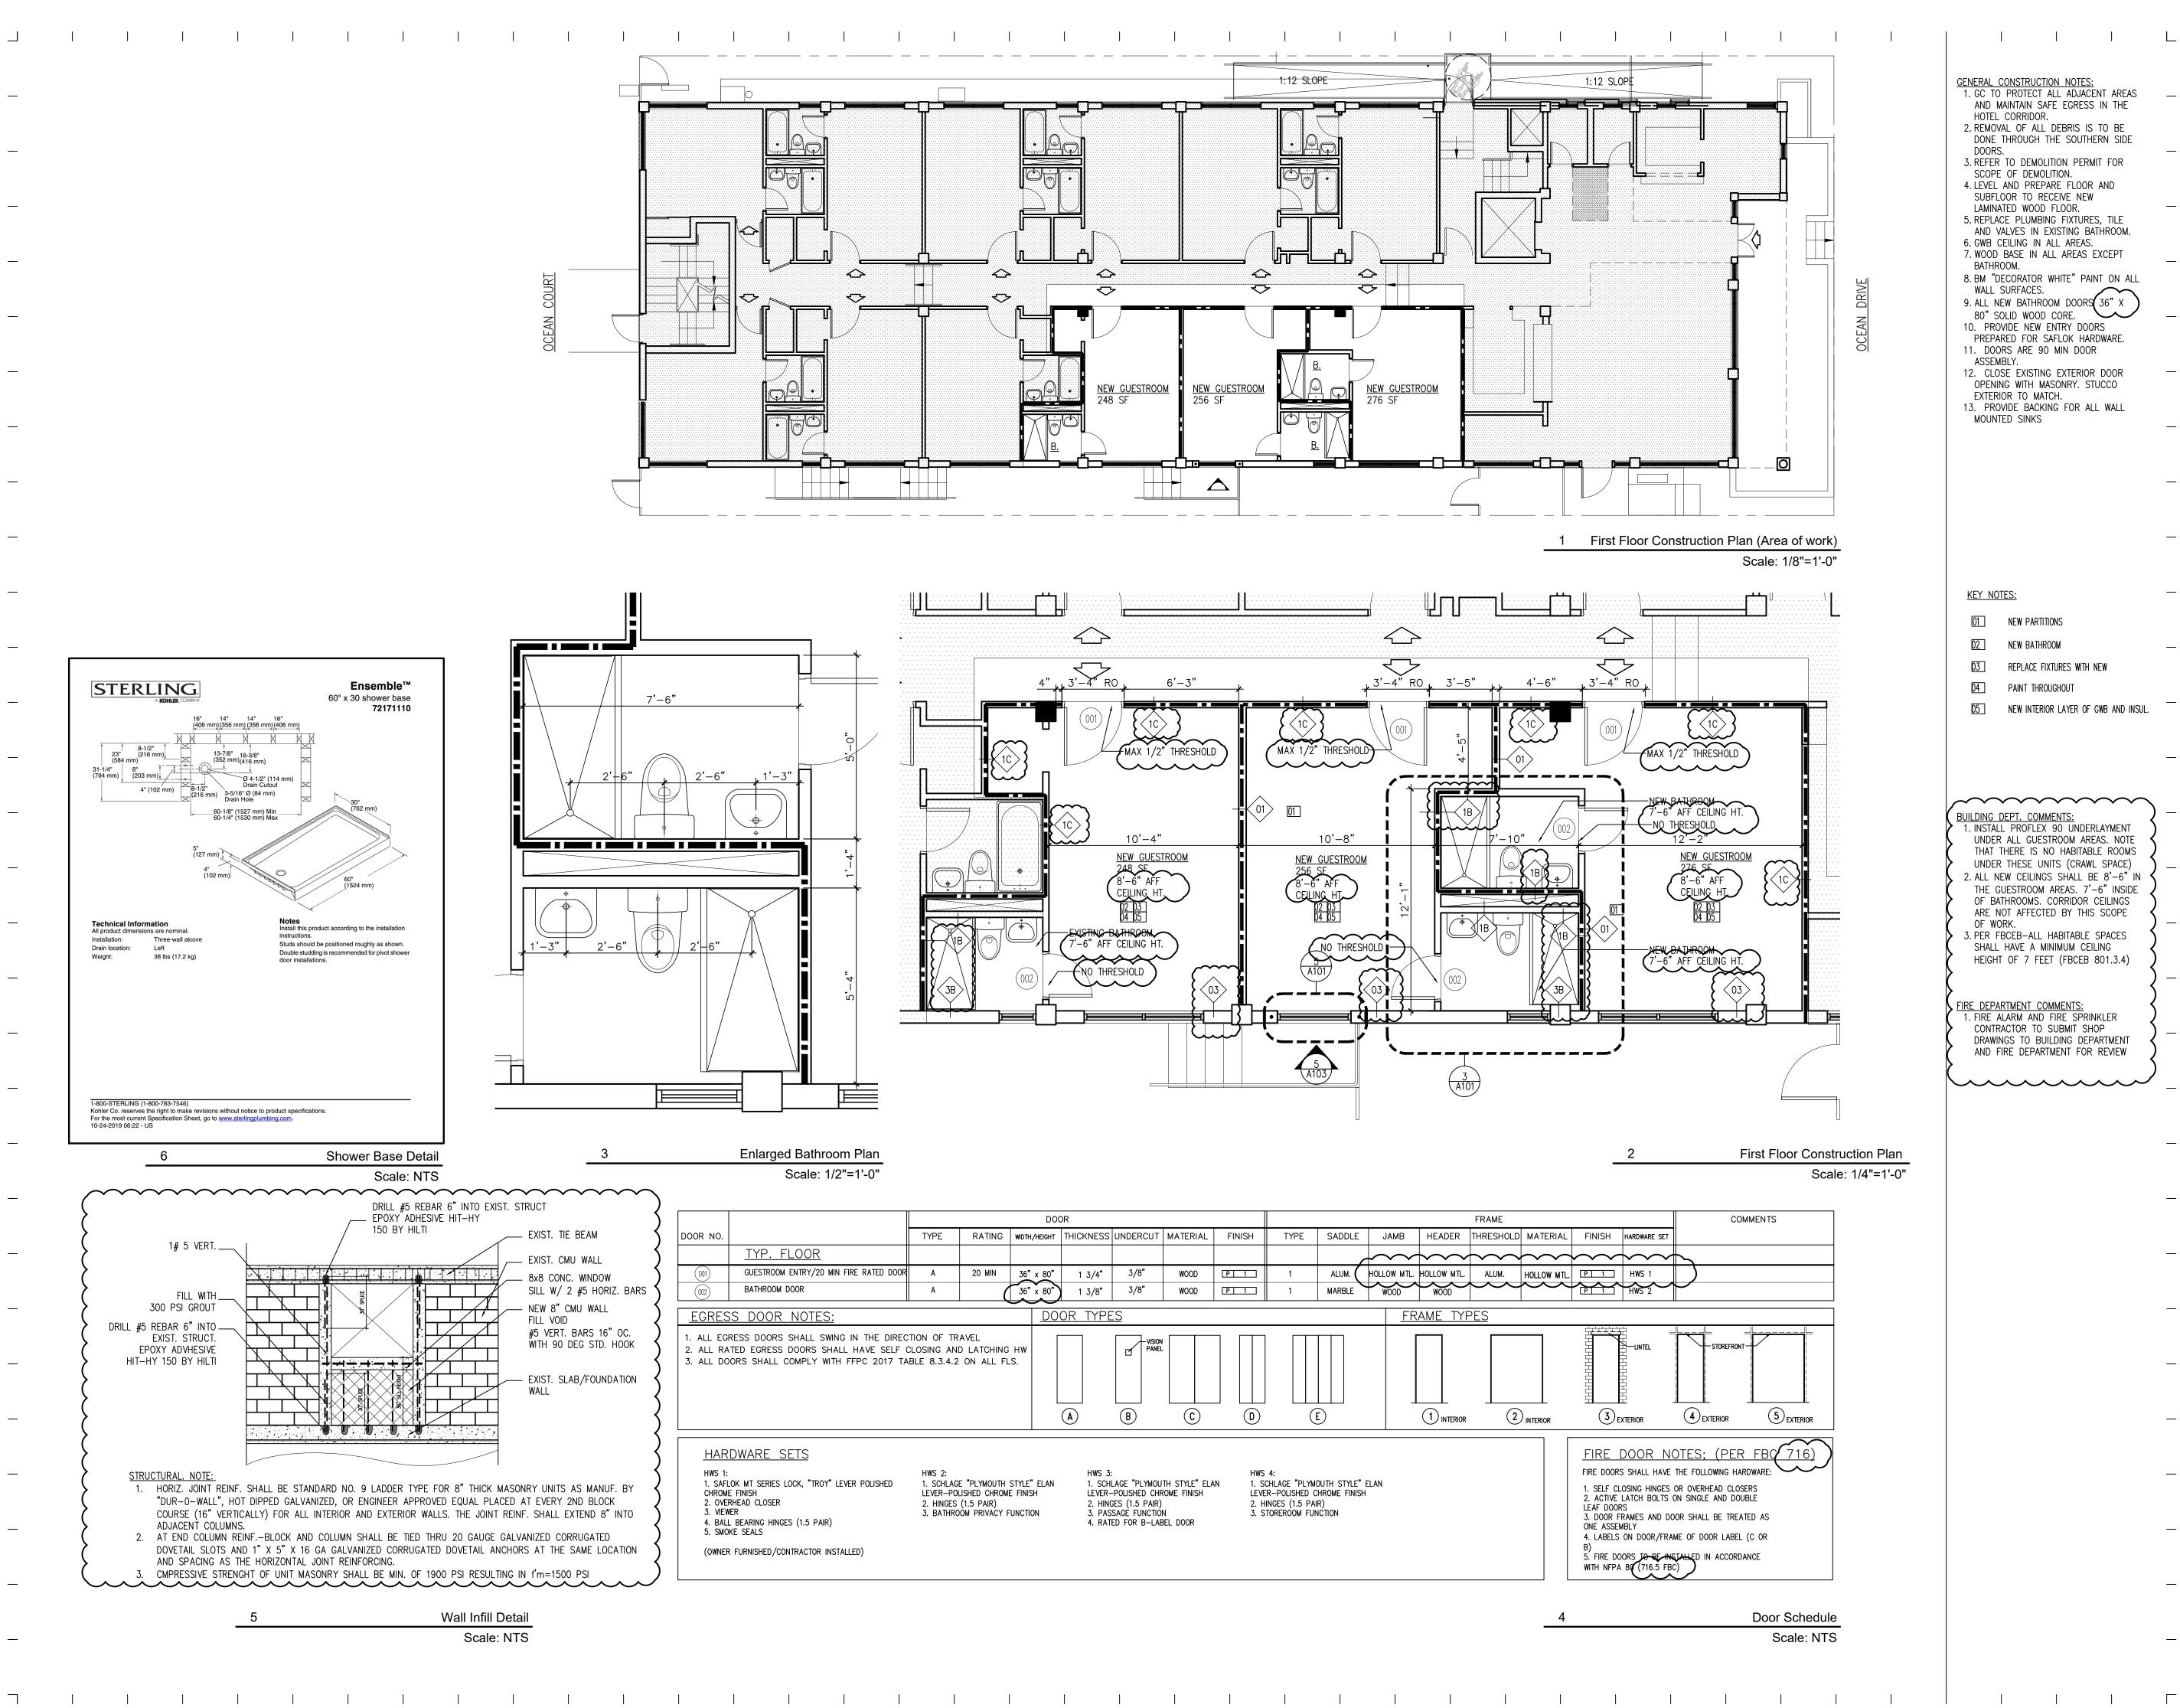

Ensemble™

60" x 30 shower base

**Notes**Install this product according to the installation

Studs should be positioned roughly as shown.

Double studding is recommended for pivot shower

<del>|</del> ← ← ← ← ← ← /4

STERLING.

**Technical Information**All product dimensions are nominal

Drain location: Left

Three-wall alcove

38 lbs (17.2 kg)

Kohler Co. reserves the right to make revisions without notice to product specifications. For the most current Specification Sheet, go to <a href="https://www.sterlingplumbing.com">www.sterlingplumbing.com</a>. 10-24-2019 06:22 - US

1# 5 VERT.\_\_\_\_\_

FILL WITH\_ 300 PSI GROUT

DRILL #5 REBAR 6" INTO \_

EXIST. STRUCT.

EPOXY ADVHESIVE

HIT-HY 150 BY HILTI

STRUCTURAL. NOTE:

AND SPACING AS THE HORIZONTAL JOINT REINFORCING.

BLDG. DEPT 11.15.19 02.11.20 CORRECTIONS

Date Notes:

+JMJ+

Owner:

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Architect:

Suite 503 Miami, FL 33145 Tel: 305.322.1280

Miami Beach, Florida

**Renovation Permit Set** 




Penguin Hotel

Ground Floor

1418 Ocean Drive


#### CONSTRUCTION PLAN FIRST FLOOR

Submission Date:	November 15, 2019	
Scale:	As Noted	A101.00
Drawn by:	JJA	A101.00
Project:	261.01	

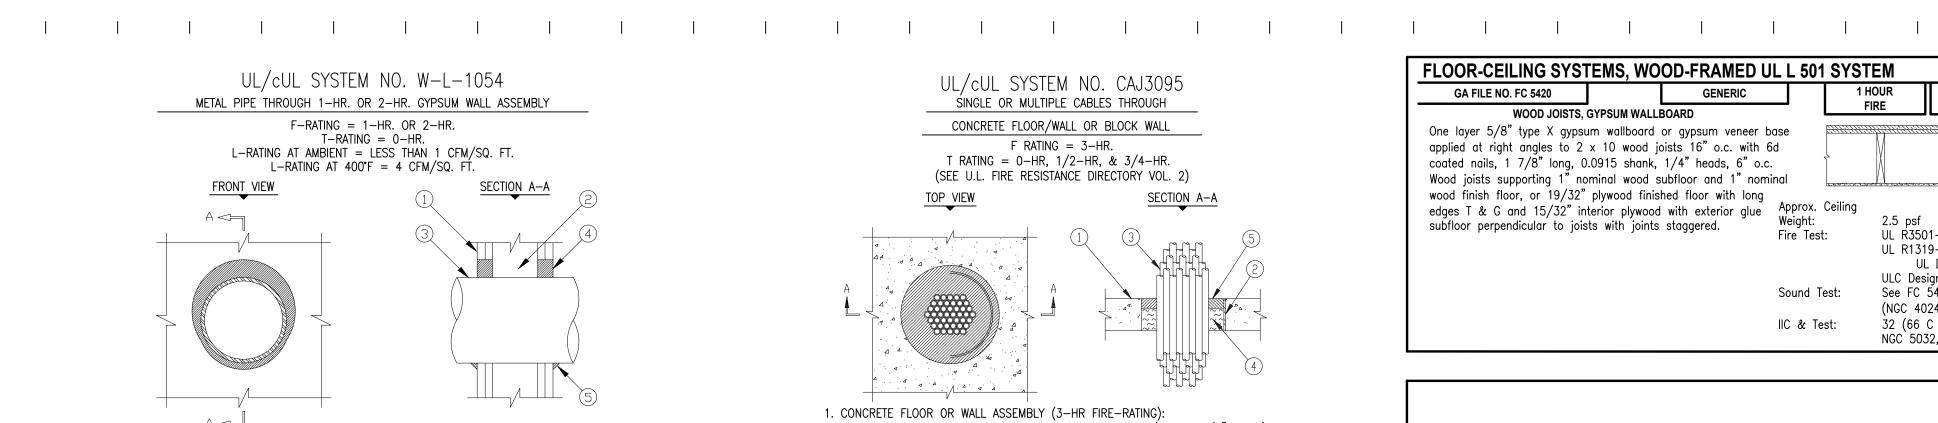

- 1. GYPSUM WALL ASSEMBLY (UL/ULC CLASSIFIED U300 OR U400 SERIES) (1-HR. OR 2-HR. FIRE-RATING) (2-HR. SHOWN). 2. (NOT SHOWN). WOOD STUDS TO CONSIST OF NOMINAL 2" x 4" LUMBER. STEEL STUDS TO
- BE MINIMUM 2-1/2" WIDE. 3. PENETRATING ITEM TO BE ONE OF THE FOLLOWING A. MAXIMUM 30" DIAMETER STEEL PIPE (SCHEDULE 10 OR HEAVIER). B. MAXIMUM 30" DIAMETER CAST IRON PIPE.
- C. MAXIMUM 6" NOMINAL DIAMETER COPPER PIPE D. MAXIMUM 6" NOMINAL DIAMETER STEEL CONDUIT E. MAXIMUM 4" NOMINAL DIAMETER EMT. 4. HILTI FS-ONE HIGH PERFORMANCE INTUMESCENT FIRESTOP SEALANT :
- A. MINIMUM 5/8", FOR A 1-HR. FIRE-RATING. B. MINIMUM 1-1/4" DEPTH, FOR A 2-HR. FIRE-RATING. 5. MINIMUM 1/2" BEAD HILTI FS-ONE HIGH PERFORMANCE INTUMESCENT FIRESTOP SEALANT AT POINT OF CONTACT.
- 1. MAXIMUM DIAMETER OF OPENING A. 32-1/4" FOR STEEL STUD WALLS. B. 14-1/2" FOR WOOD STUD WALLS. 2. ANNULAR SPACE = MINIMUM 0", MAXIMUM 2-1/2"

#### UL/cUL SYSTEM NO. W-L-7040 METAL DUCT (WITHOUT DAMPER) THROUGH 1-HR. OR 2-HR. GYPSUM WALL ASSEMBLY F-RATING = 1-HR. OR 2-HR. T-RATING = 0-HR.

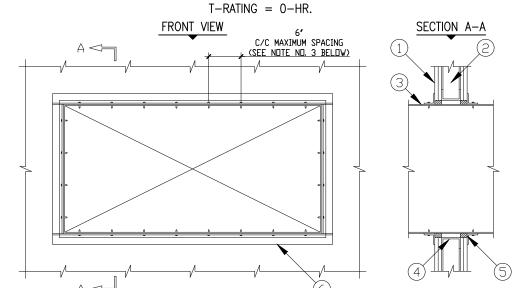


1. GYPSUM WALL ASSEMBLY (UL/ULC CLASSIFIED U300 OR U400 SERIES WALL) (1-HR. OR 2-HR. FIRE-RATING) (2-HR. SHOWN). 2. (NOT SHOWŃ). WOOD STUDS TO CONSIST OF NOMINAL 2" x 4" LUMBER. STEEL STUDS TO BE MINIMUM 2-1/2" WIDE. 3. RECTANGULAR SHEET METAL DUCT (MAXIMUM SIZE: 24" x 48", MINIMUM 24 GA. THICKNESS). (NOTE: NOT FOR USE IN DUCT SYSTEMS CONTAINING A FIRE DAMPER). 4. OPENING TO BE "FRAMED OUT" WITH LIGHTGAGE METAL FRAMING STUDS. 5. HILTI FS-ONE HIGH PERFORMANCE INTUMESCENT FIRESTOP SEALANT. HILTI CP 601S ELASTO-MERIC FIRESTOP SEALANT, OR HILTI CP 606 FLEXIBLE FIRESTOP SEALANT A. MINIMUM 5/8" DEPTH OF SEALANT FOR A 1-HR. FIRE-RATING.


B. MINIMUM 1'-1/4" DEPTH OF SEALANT FOR A 2-HR. FIRE-RATING.

6. SEE NOTE NO. 3 BÉLOW.

NOTES: 1. MAX. AREA OF OPENING = 1244 SQ. IN. WITH A MAXIMUM DIMENSION OF 49-1/4 IN. 2. ANNULAR SPACE = MINIMUM 1/4", MAXIMUM 1". 3. AFTER SEALING SPACE BETWEEN DUCT AND GYPSUM WALL ASSEMBLY WITH HILTI FIRESTOP SEALANT, FASTEN STEEL ANGLE (MINIMUM 1-1/2" x 1-1/2" x 16 GA.) TO DUCT WITH MINIMUM NO. 8  $\times$  3/4" LONG SHEET METAL SCREWS. ANGLE DOES NOT HAVE TO BE FASTENED TO THE WALL ASSEMBLY.

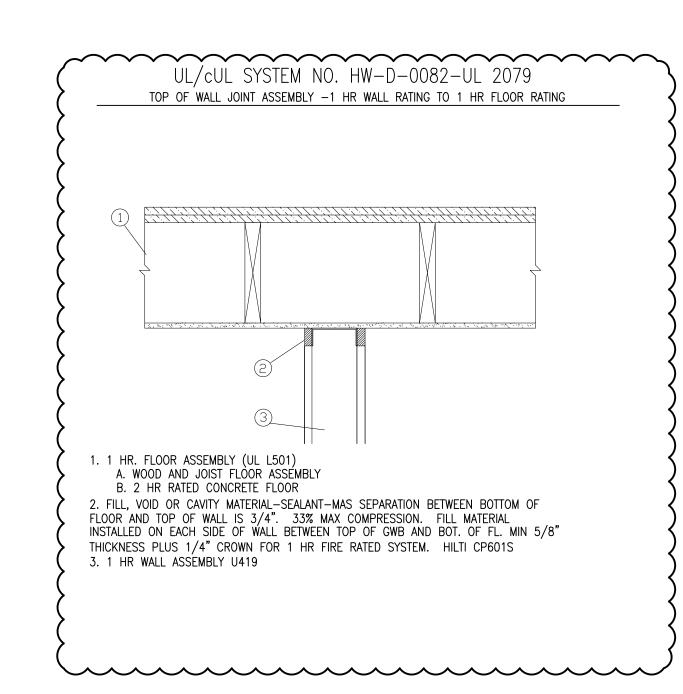

UL/cUL SYSTEM NO. CAJ3095 SINGLE OR MULTIPLE CABLES THROUGH CONCRETE FLOOR/WALL OR BLOCK WALL F RATING = 3-HR. T RATING = 0-HR, 1/2-HR, & 3/4-HR. (SEE U.L. FIRE RESISTANCE DIRECTORY VOL. 2) TOP VIEW SECTION A-A

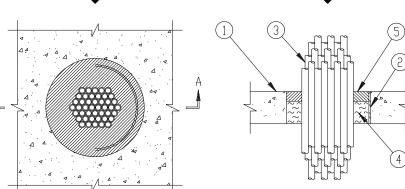


1. CONCRETE FLOOR OR WALL ASSEMBLY (3-HR FIRE-RATING): A. LIGHTWEIGHT OR NORMAL WEIGHT CONCRETE FLOOR (MIN. 2-1/2" THICK). B. LIGHTWEIGHT OR NORMAL WEIGHT CONCRETE WALL (MIN. 3" THICK). C. ANY UL/ULC CLASSIFIED CONCRETE BLOCK WALL. 2. OPTIONAL: MAXIMUM 6" NOMINAL DIAMETER STEEL PIPE SLEEVE (SCHEDULE 10 OR

5. MINIMUM 1/2" DEPTH HILTI FS-ONE INTUMESCENT FIRESTOP SEALANT.

- 3. MAXIMUM 4" DIAMETER CABLE BUNDLE TO BE A COMBINATION OF ANY OF THE FOLLOWING: A. MAXIMUM 300 PAIR NO. 24 AWG TELEPHONE CABLE WITH PVC JACKET. B. MAXIMUM 500 KCMIL POWER CABLE WITH PVC JACKET. C. MAXIMUM 7/C NO. 12 AWG POWER CABLE WITH PVC JACKET. D. MAXIMUM (24 FIBER) 1/2" DIAMETER FIBER-OPTIC CABLE. E. MAXIMUM 3/C NO. 12 AWG METAL—CLAD CABLE. 4. MINIMUM 2" THICKNESS MINERAL WOOL (MIN. 4 PCF DENSITY) TIGHTLY PACKED.
- . MAXIMUM DIAMETER OF OPENING = 6". 2. CABLES TO FILL MINIMUM 25%, TO MAXIMUM 45% OF CROSS—SECTIONAL AREA OF OPENING. 3. STEEL FLOOR UNIT/FLOOR ASSEMBLY (NOT SHOWN)—THE FLOOR ASSEMBLY MAY ALSO CONSIST OF MINIMÚM 2-1/2" CONCRETE OVER (1-1/2)" TO 3" DEEP) FLUTED METAL DECK. 4. MINIMUM 1/2" DEPTH HILTI FS-ONE INTUMESCENT FIRESTOP SEALANT IS REQUIRED ON BOTH SIDES OF A WALL.

## UL/cUL SYSTEM NO. CAJ7051

METAL DUCT (WITHOUT DAMPER) THROUGH CONCRETE FLOOR/WALL OR BLOCK WALL F RATING = 3-HR.

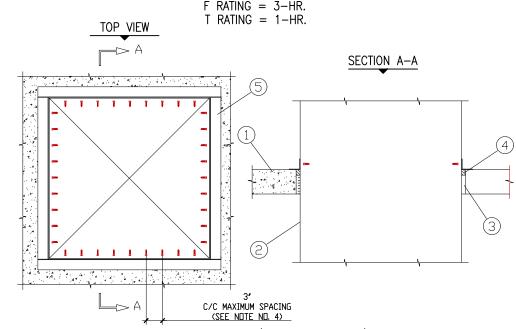

- 1. CONCRETE FLOOR OR WALL ASSEMBLY (3-HR FIRE-RATING): A. LIGHTWEIGHT OR NORMAL WEIGHT CONCRETE FLOOR (MIN. 4-1/2" THICK). B. LIGHTWEIGHT OR NORMAL WEIGHT CONCRETE WALL (MIN. 5-1/2" THICK). C. ANY UL/ULC CLASSIFIED CONCRETE BLOCK WALL. 2. MAXIMUM 30" X 30" RECTANGULAR STEEL DUCT (MINIMUM 24 GAUGE).
- (NOTE: NOT FOR USE IN DUCT SYSTEMS CONTAINING A DAMPER). 3. MINIMUM 3-1/2" THICKNESS MINERAL WOOL (MIN. 4 PCF DENSITY) TIGHTLY PACKED. 4. MINIMUM 1" DEPTH HILTI CP 606 FLEXIBLE FIRESTOP SEALANT OR HILTI FS-ONE INTUMESCENT FIRESTOP SEALANT. 5. SEE NOTE NO. 4 BELOW.
- NOTES: 1. MAXIMUM AREA OF OPENING = 1024 SQUARE INCHES WITH A MAXIMUM DIMENSION OF 32 INCHES.
  - 2. ANNULAR SPACE = MINIMUM 1/4", MAXIMUM 1-3/4". 3. MINIMUM 1" DEPTH HILTI CP 606/FS-ONE FIRESTOP SEALANT AND STEEL ANGLES ARE REQUIRED ON BOTH SIDES OF A WALL ASSEMBLY. 4. AFTER SEALING SPACE BETWEEN DUCT AND CONCRETE FLOOR/WALL ASSEMBLY WITH HILTI CP 606, FASTEN STEEL ANGLE (L2 X 2 X MIN. 16 GA.) TO DUCT

WITH NO. 8 (OR LARGER) STEEL SHEET METAL SCREWS. ANGLE DOES NOT HAVE TO BE FASTENED TO CONCRETE FLOOR/WALL ASSEMBLY. UL/cUL SYSTEM NO. CAJ1226

> F RATING = 3-HR. T RATING = 0-HR. L RATING AT AMBIENT = LESS THAN 1 CFM/SQ. FT. L RATING AT  $400^{\circ}$  F = 4 CFM/SQ. FT.

METAL PIPE THROUGH A SLEEVE IN CONCRETE FLOOR/WALL OR BLOCK WALL

SECTION A-A

1. CONCRETE FLOOR OR WALL ASSEMBLY (3-HR FIRE-RATING): A. LIGHTWEIGHT OR NORMAL WEIGHT CONCRETE FLOOR OR WALL (MIN. 4-1/2" THICK). B. ANY UL/ULC CLASSIFIED CONCRETE BLOCK WALL.

2. OPTIONAL: MAXIMUM 32" NOMINAL DIAMETER STEEL PIPE SLEEVE (SCHEDULE 40 OR HEAVIER). 3. PENETRATING ITEM TO BE ONE OF THE FOLLOWING:


A. MAXIMUM 30" NOMINAL DIAMETER STEEL PIPE (SCHEDULE 10 OR HEAVIER). B. MAXIMUM 30" NOMINAL DIAMETER CAST IRON PIPE. C. MAXIMUM 6" NOMINAL DIAMETER COPPER PIPE. D. MAXIMUM 6" NOMINAL DIAMETER STEEL CONDUIT.


E. MAXIMUM 4" NOMINAL DIAMETER EMT. 4. MINIMUM 4" THICKNESS MINERAL WOOL (MIN. 4 PCF DENSITY) TIGHTLY PACKED. 5. MINIMUM 1/4" DEPTH HILTI FS-ONE INTUMESCENT FIRESTOP SEALANT. 6. MINIMUM 1/4" CROWN HILTI FS-ONE INTUMESCENT FIRESTOP SEALANT APPLIED AT POINT OF


CONTACT.


NOTES: 1. MAXIMUM DIAMETER OF OPENING = 32". 2. ANNULAR SPACE = MINIMUM 0", MAXIMUM 1-7/8". 3. MINIMUM 1/4" DEPTH HILTI FS-ONE INTUMESCENT FIRESTOP SEALANT IS REQUIRED ON BOTH SIDES OF A WALL ASSEMBLY.


FLOOR-CEILING SYSTEMS, WOOD-FRAMED UL L 501 SYSTEM 35 to 39 STC GA FILE NO. FC 5420 GENERIC FIRE SOUND WOOD JOISTS, GYPSUM WALLBOARD One layer 5/8" type X gypsum wallboard or gypsum veneer base applied at right angles to 2 x 10 wood joists 16" o.c. with 6d coated nails, 1 7/8" long, 0.0915 shank, 1/4" heads, 6" o.c. Wood joists supporting 1" nominal wood subfloor and 1" nominal wood finish floor, or 19/32" plywood finished floor with long edges T & G and 15/32" interior plywood with exterior glue Approx. Ceiling Weight: subfloor perpendicular to joists with joints staggered. UL R3501-5, 7-15-52; Fire Test: UL R1319-2, 3, 6-5-52; UL Design L501; ULC Design M500 See FC 5410 (NGC 4024, 7-13-66) 32 (66 C & P) NGC 5032, 7-19-66

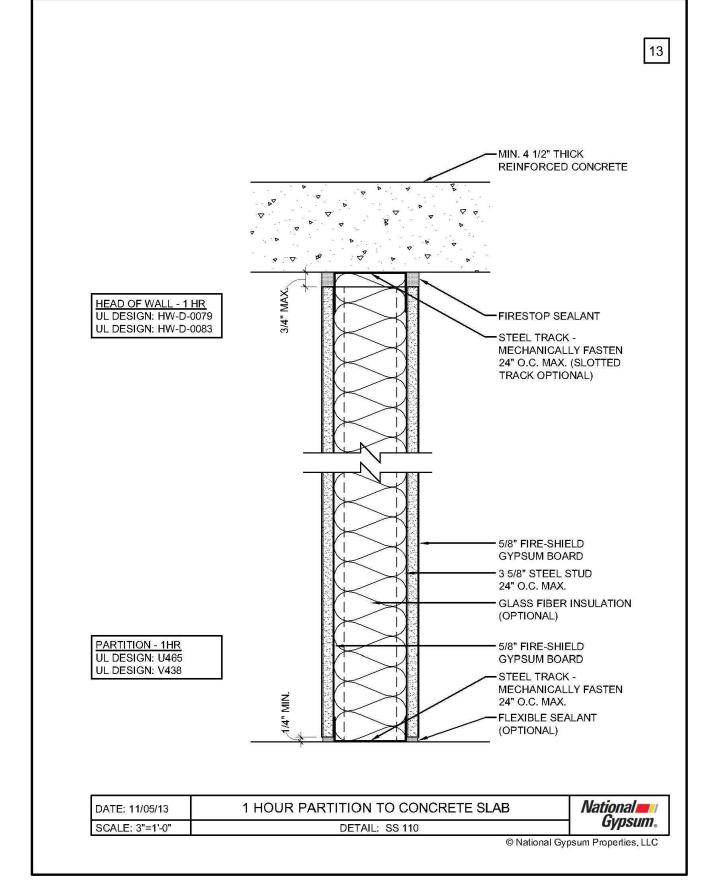


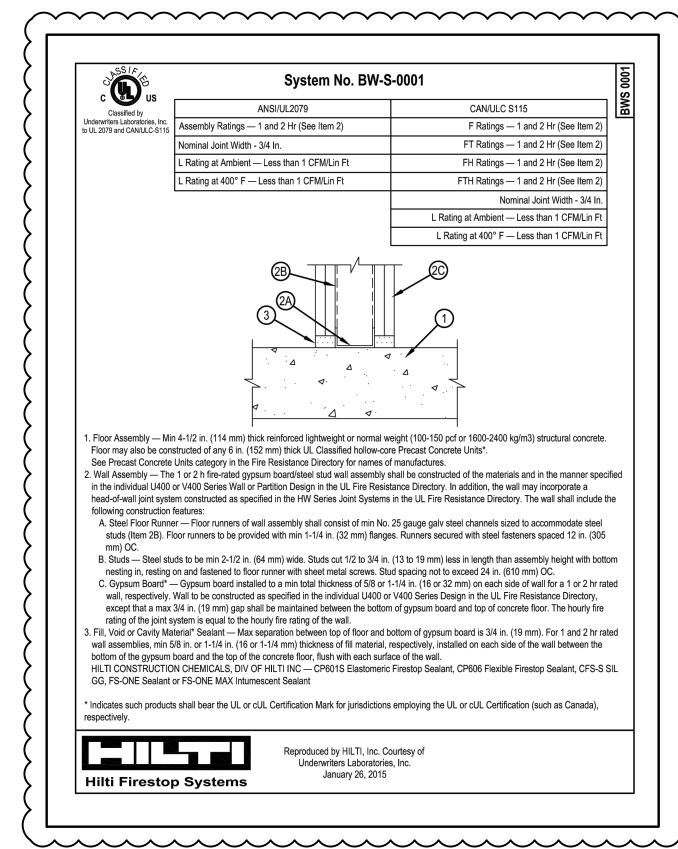

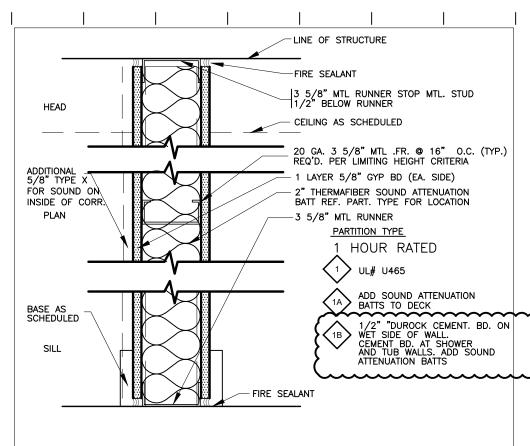

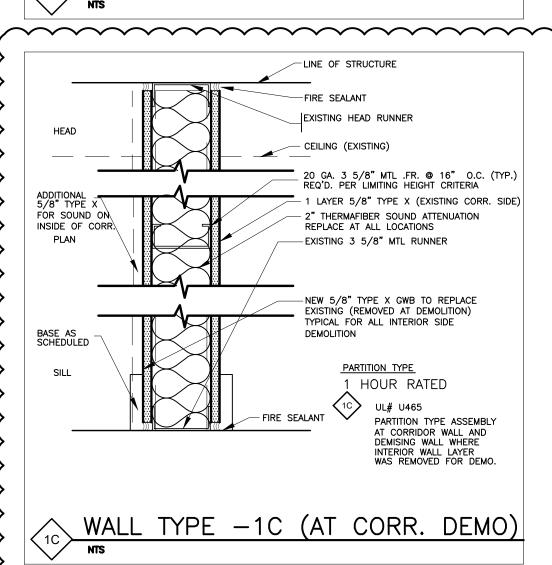

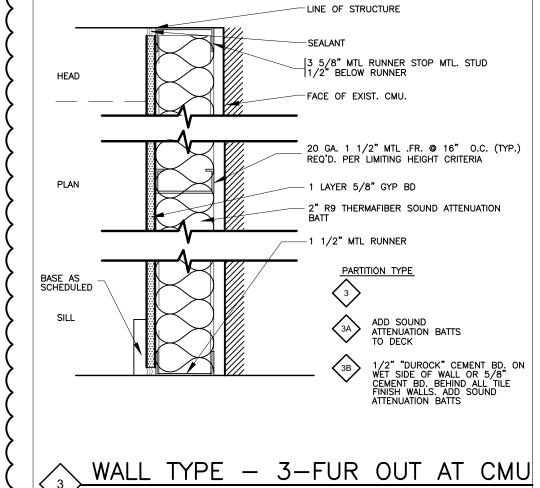

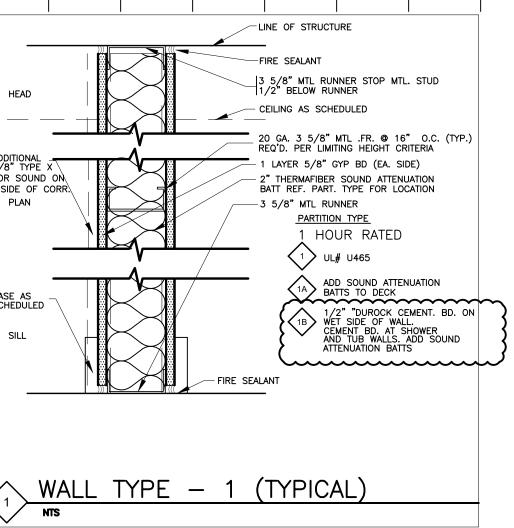

Owner: Penguin Hotel Corp 1418 Ocean Drive Miami Beach, FL 33139 Architect: Juan J. Alayo, AIA 2307 Douglas Road Suite 503 Miami, FL 33145 Tel: 305.322.1280 Florida Professional License# AR 0016549

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Notes:

BLDG. DEPT

CORRECTIONS

Date

11.15.19


02.11.20

Penguin Hotel **Ground Floor Renovation Permit Set** 1418 Ocean Drive Miami Beach, Florida



#### **UL DETAILS** PARTTION TYPES

Submission Date:	November 15, 2019	
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Drawn by:	JJA	A 102.00
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 Cooler weather will also increase set time. Protect Primers from freezing.

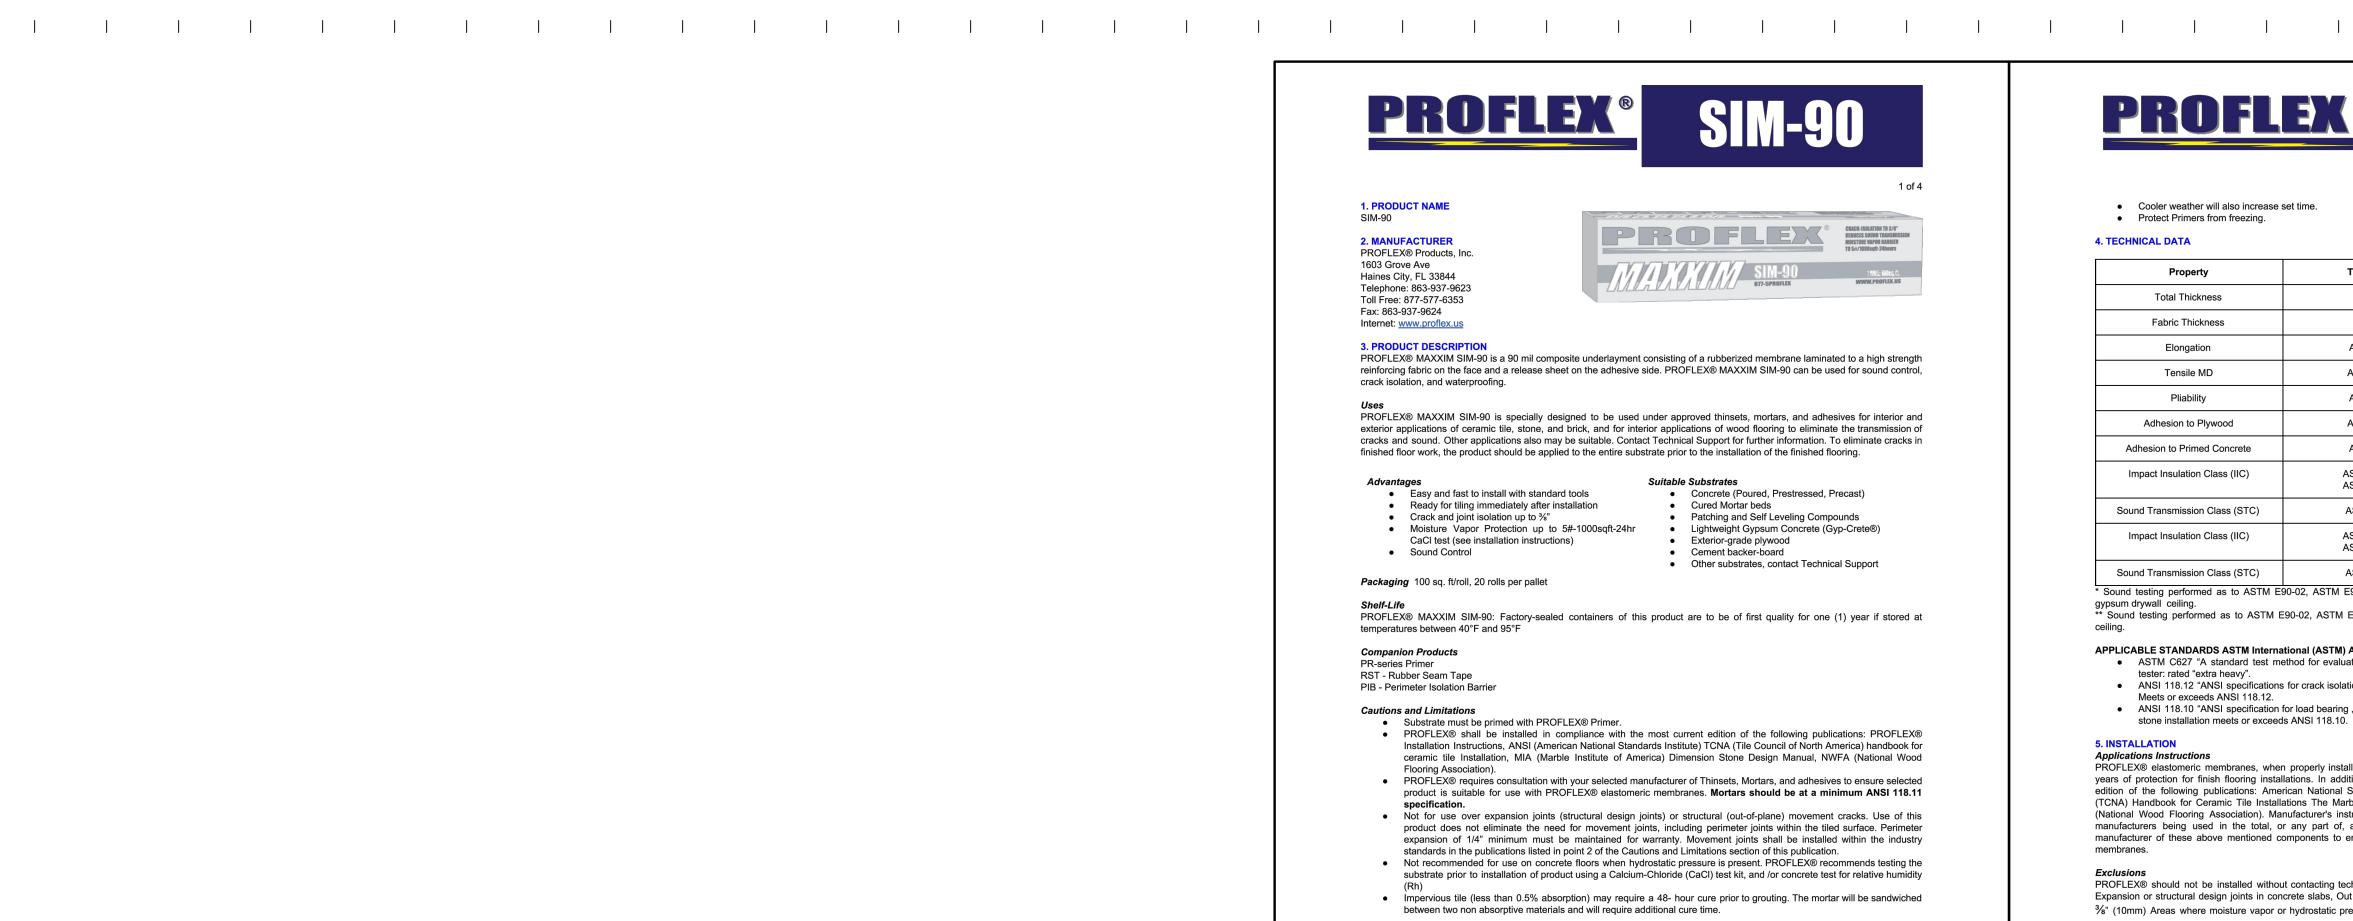4. TECHNICAL DATA

1 of 4

Suitable Substrates

Data Sheets are subject to change without notice. For latest revision, visit www.proflex.us

Cured Mortar beds

Exterior-grade plywood

Cement backer-board

Concrete (Poured, Prestressed, Precast)

Patching and Self Leveling Compounds

Lightweight Gypsum Concrete (Gyp-Crete®)

Other substrates, contact Technical Support

Property	Test Method	Result
Total Thickness		90 mil.
Fabric Thickness		30 mil.
Elongation	ASTM D882	350% min.
Tensile MD	ASTM D1682	1270 psi
Pliability	ASTM D146	Pass-25
Adhesion to Plywood	ASTM D1790	8 lb/in.
Adhesion to Primed Concrete	ASTM D903	10 lb/in.
Impact Insulation Class (IIC)	ASTM E989-89 ASTM E492-90	71*
Sound Transmission Class (STC)	ASTM E90-02	66*
Impact Insulation Class (IIC)	ASTM E989-89 ASTM E492-90	50**
Sound Transmission Class (STC)	ASTM E90-02	57**

gypsum drywall ceiling.

\*\* Sound testing performed as to ASTM E90-02, ASTM E989-89, ASTM E492-90. Test conducted on 8" concrete slab with NO APPLICABLE STANDARDS ASTM International (ASTM) ANSI American National Standard Institute

ASTM C627 "A standard test method for evaluating ceramic floor tile installation systems using the robinson-type floor

tester: rated "extra heavy". ANSI 118.12 "ANSI specifications for crack isolation membranes for thin-set ceramic tile and dimension stone installation. Meets or exceeds ANSI 118.12.

 ANSI 118.10 "ANSI specification for load bearing, bonded, waterproof membranes for thin-set ceramic tile and dimension stone installation meets or exceeds ANSI 118.10.

Applications Instructions


PROFLEX® elastomeric membranes, when properly installed in accordance with the following installation guidelines, will provide years of protection for finish flooring installations. In addition to these instructions, installers shall also refer to the most current edition of the following publications: American National Standards Institute (ANSI) publications. Tile Council of North America (TCNA) Handbook for Ceramic Tile Installations The Marble Institute of America (MIA) Dimension Stone Design Manual, NWFA (National Wood Flooring Association). Manufacturer's instructions of selected setting materials, substrates, sub-floors, or other manufacturers being used in the total, or any part of, an installed flooring system with PROFLEX® Consult your selected manufacturer of these above mentioned components to ensure selected products are compatible with PROFLEX® elastomeric membranes.

PROFLEX® should not be installed without contacting technical support for including, but not limited to, the following conditions: Expansion or structural design joints in concrete slabs, Out of plane, or structural movement cracks. Horizontal cracks that exceed 3/6" (10mm) Areas where moisture vapor or hydrostatic pressure exceeds 5#-1000sqft-24hrs, as tested using a Calcium Chloride

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FLOORING UNDERLAYMENT SPEC.

Scale: NTS

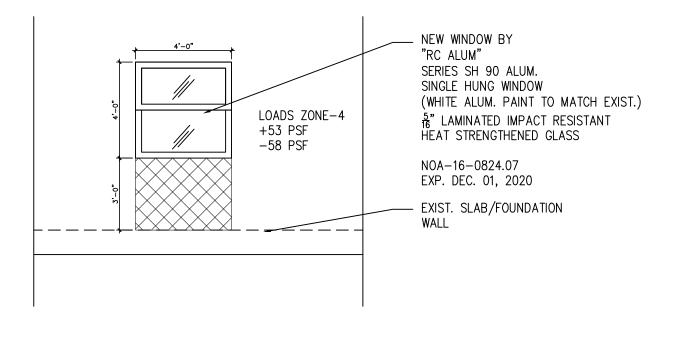

**NEW WINDOW DETAIL** Scale: 1/4" = 1'-0"

EXISTING FLOOR ASSEMBLY
UL L-501 (SEE SHEET A102) 8'-6" AFF <u>8'-0"" AF</u>F 1-5/8" MT. FRAMING --ON EXISTING WOOD JOISTS SURFACE MTD. FIXTURE — 5%" FIRECODE X GWB ── PAINTED FINISH — 1 HOUR RATED PARTITION U465 (SEE SHEET A101/A102) INTERIOR ROOM SIDE CORRIDOR SIDE

> TYP. CEILING ASSEMBLY DETAIL Scale: 1 1/2" = 1'-0"

72" HIGH CERAMIC TILE 72" HIGH CERAMIC TILE SHOWER CONTROL 2'-6" 5'-0"

> TYP BATHROOM BACK WALL ELEV. Scale: 1/2" = 1'-0"

TYP. SHOWER WALL ELEV. Scale: 1/2" = 1'-0"

+JMJ+

Owner:

Penguin Hotel Corp

Miami Beach, FL 33139

1418 Ocean Drive

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2307 Douglas Road

Tel: 305.322.1280

Florida Professional License# AR 0016549

Architect:

Suite 503 Miami, FL 33145

Date Notes: BLDG. DEPT 11.15.19 CORRECTIONS 02.11.20

Penguin Hotel Ground Floor Renovation Permit Set 1418 Ocean Drive

Miami Beach, Florida

**DETAILS** 

Submission Date: November 15, 2019 As Noted A103.00 JJA Drawn by: 261.01

02.11.20