

SUPPORTS, 4" O.C. @ ALL ENDS & EDGES, 4" O.C. @ ALL CUTS, TERMINATIONS,

TRANSITIONS & BOUNDARIES.

5FC	DLLOW ALL F	REQUIREMENTS	OF THE FLOR	IDA BUILDING	CODE, FOR A	LL WOOD FR	AMINO
IN	ICLUDING BU	T NOT LIMITED	TO CONNECTIO	NS, BRACIN	G, BRIDGING A	ND NAILING.	
65	UFFICIENT V	ENTILATION UN	DER ROOF ARE	EAS SHALL	BE PROVIDED.	(F.B.C. BUILD	ING,
9	ECTION 1203	3.2)					
HOL	D-DOWN	SPECIFICAT	ION:				
N,	/A - NO HOL	D-DOWN PROP	OSED IN THIS S	BET OF DRA	WINGS.		
=40	STENER R	REQUIREME	NTG.				

AS LENER REQUIREMEN (5)

WINDOWS, DOORS & ROOFING: PER MANUFACTURER'S RECOMMENDATIONS, TO MEET DESIGN PRESSURES LISTED HEREIN.

GARAGE DOOR JAMBS:

N/A - NO GARAGE DOOR PROPOSED IN THIS SET OF DRAWINGS.

OPENING PROTECTION NOTE:

- I.- NEW DOOR TO HAVE TEMPERED & LAMINATED IMPACT RESISTANT GLASS TO MEET LIFE SAFETY STANDARDS & IN COMPLIANCE WITH FLORIDA BUILDING CODE.
- 2.- NEW DOOR TO BE TESTED IMPACT RESISTANT PRODUCTS INSTALLED PRECISELY AS INSTRUCTED BY THE MANUFACTURER.

AREA CALCULATION (s.f.):

ANLA CALCOLA (1011 (5.T.)	•	\sim	\sim
	EXISTING(ADDITION	TOTAL)
CONDITIONED SPACE Ist LEVEL	3.851	(1.849	5.700
CONDITIONED SPACE 2nd LEVEL		(1.760	1.769
STORAGE DECK	864	(0	864)
TOTAL	4.715 (3.618	8.333
		`	

LEGAL DESCRIPTION: GARDEN CITY REVISED MAP OF S 100 FT OF BLOCK 16 TOGETHER W/N I/2 OF VACATED R/W FOR FLORIDA AVE ABUTTING ON S LESS PORTION FOR R/W FOR SR 41, AS RECORDED IN PLAT BOOK I, PAGE 117, OF THE PUBLIC RECORDS OF HILLSBOROUGH COUNTY, FLORIDA. SEE SURVEY FOR COMPLETE DESCRIPTION.


THIS PROPERTY IS LOCATED IN FLOOD ZONE: AE-10 B.F.E. SEE EXISTING STRUCTURE ELEVATION CERTIFICATE FOR COMPLEMENTARY INFORMATION.


ZONING DESIGNATION: CI - COMMERCIAL INTENSIVE

COMPONENT AND CLADDING WIND LOADS FOR A BUILDING (psf) WIND SPEED (Vult) MEAN ROOF HEIGHT: EXPOSURE: HT & EXP COEFFICIENT= DESIGN WIND SPEED (MPH) 110 (Vasd) (ft2) (PER TABLE R301.2.1.3) ZONE


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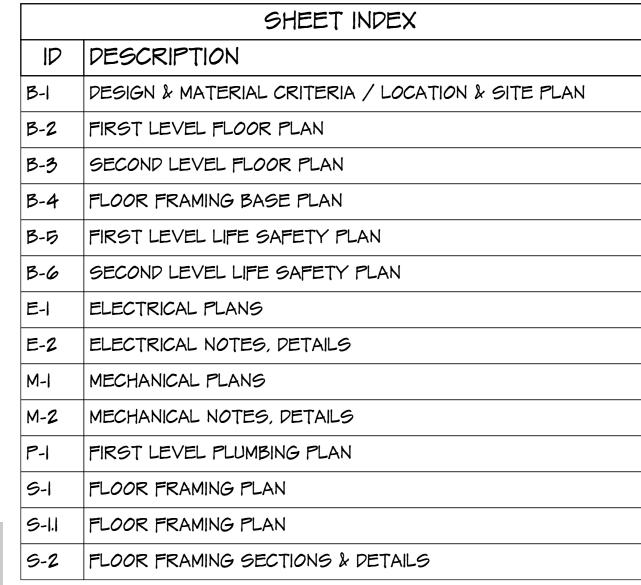



COMPONENT AND CLADDING PRESSURE

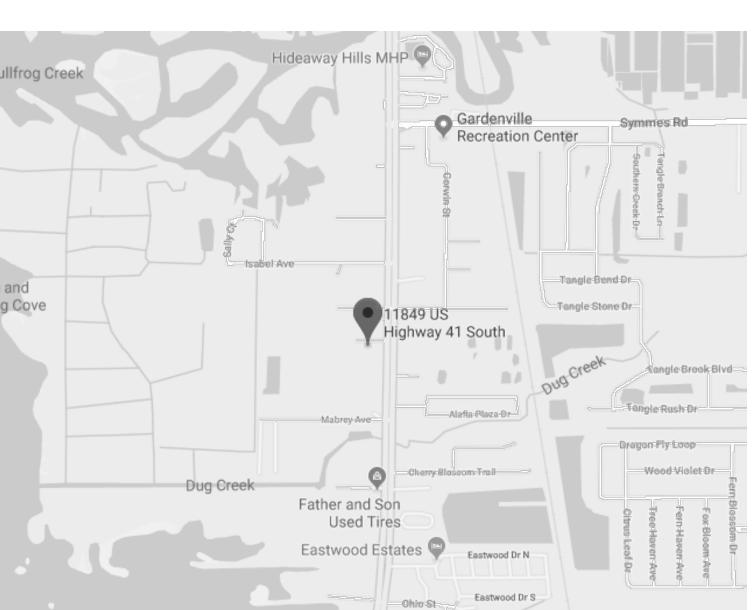


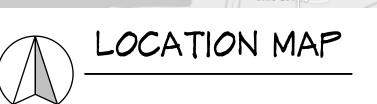GABLE ROOF (7°(⊕(=45°)

INTERIOR ZONE	END ZONE	CORNER Z
ROOF-ZONE I/WALLS-ZONE 4	ROOF-ZONE 2/WALLS-ZONE 5	ROOF-ZONE 3

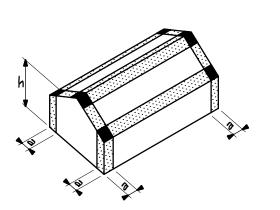


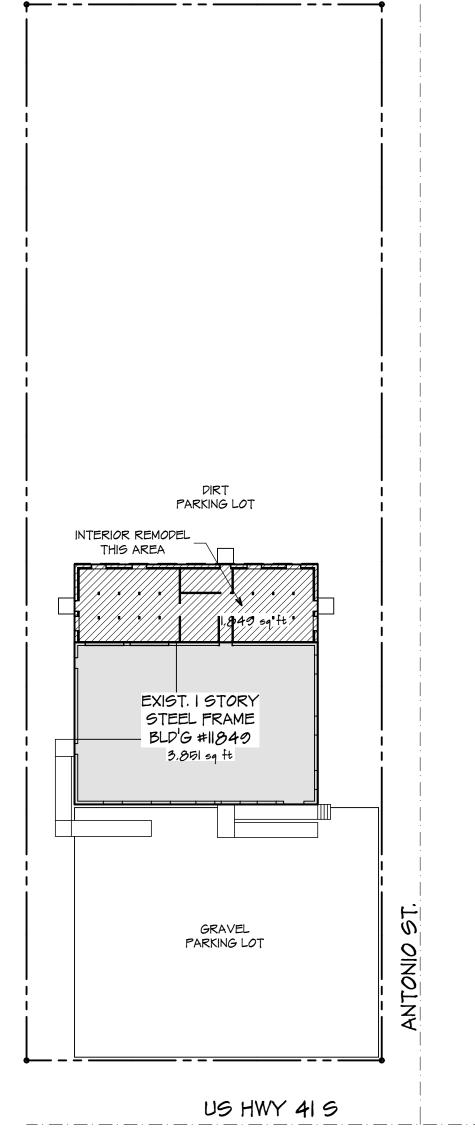


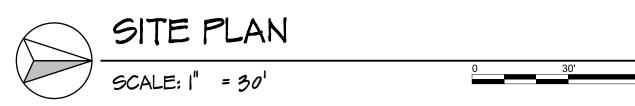


FLORIDA PRODUCT APPROVAL TABLE									
CATEGORY	SUBCATEGORY	DESCRIPTION	MANUFACTURER	APP. / SEQ.					
EXTERIOR DOORS	SWINGING	MTL. OPAQUE	THERMATRU	FL 23507.10					
PANEL WALLS	SIDING	MTL. PBR PANEL	MBCI	FL 11917.5					
WINDOWS	SINGLE HUNG	IMPACT	PGT INDUSTRIES	FL 1435.5					


GENERAL CONTRACTOR TO PROVIDE COPIES OF TEST REPORTS AND INSTALLATION INSTRUCTIONS AT INSPECTIONS.

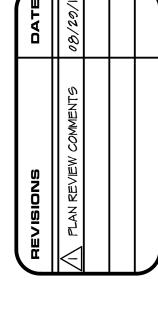

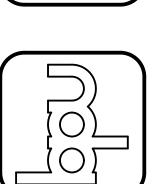

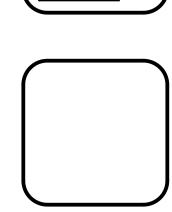

10-033 DRAWN BY: R.Z. CHECKED BY: T.J.Z. DATE OF ISSUE 08/07/2019 SHEET No.

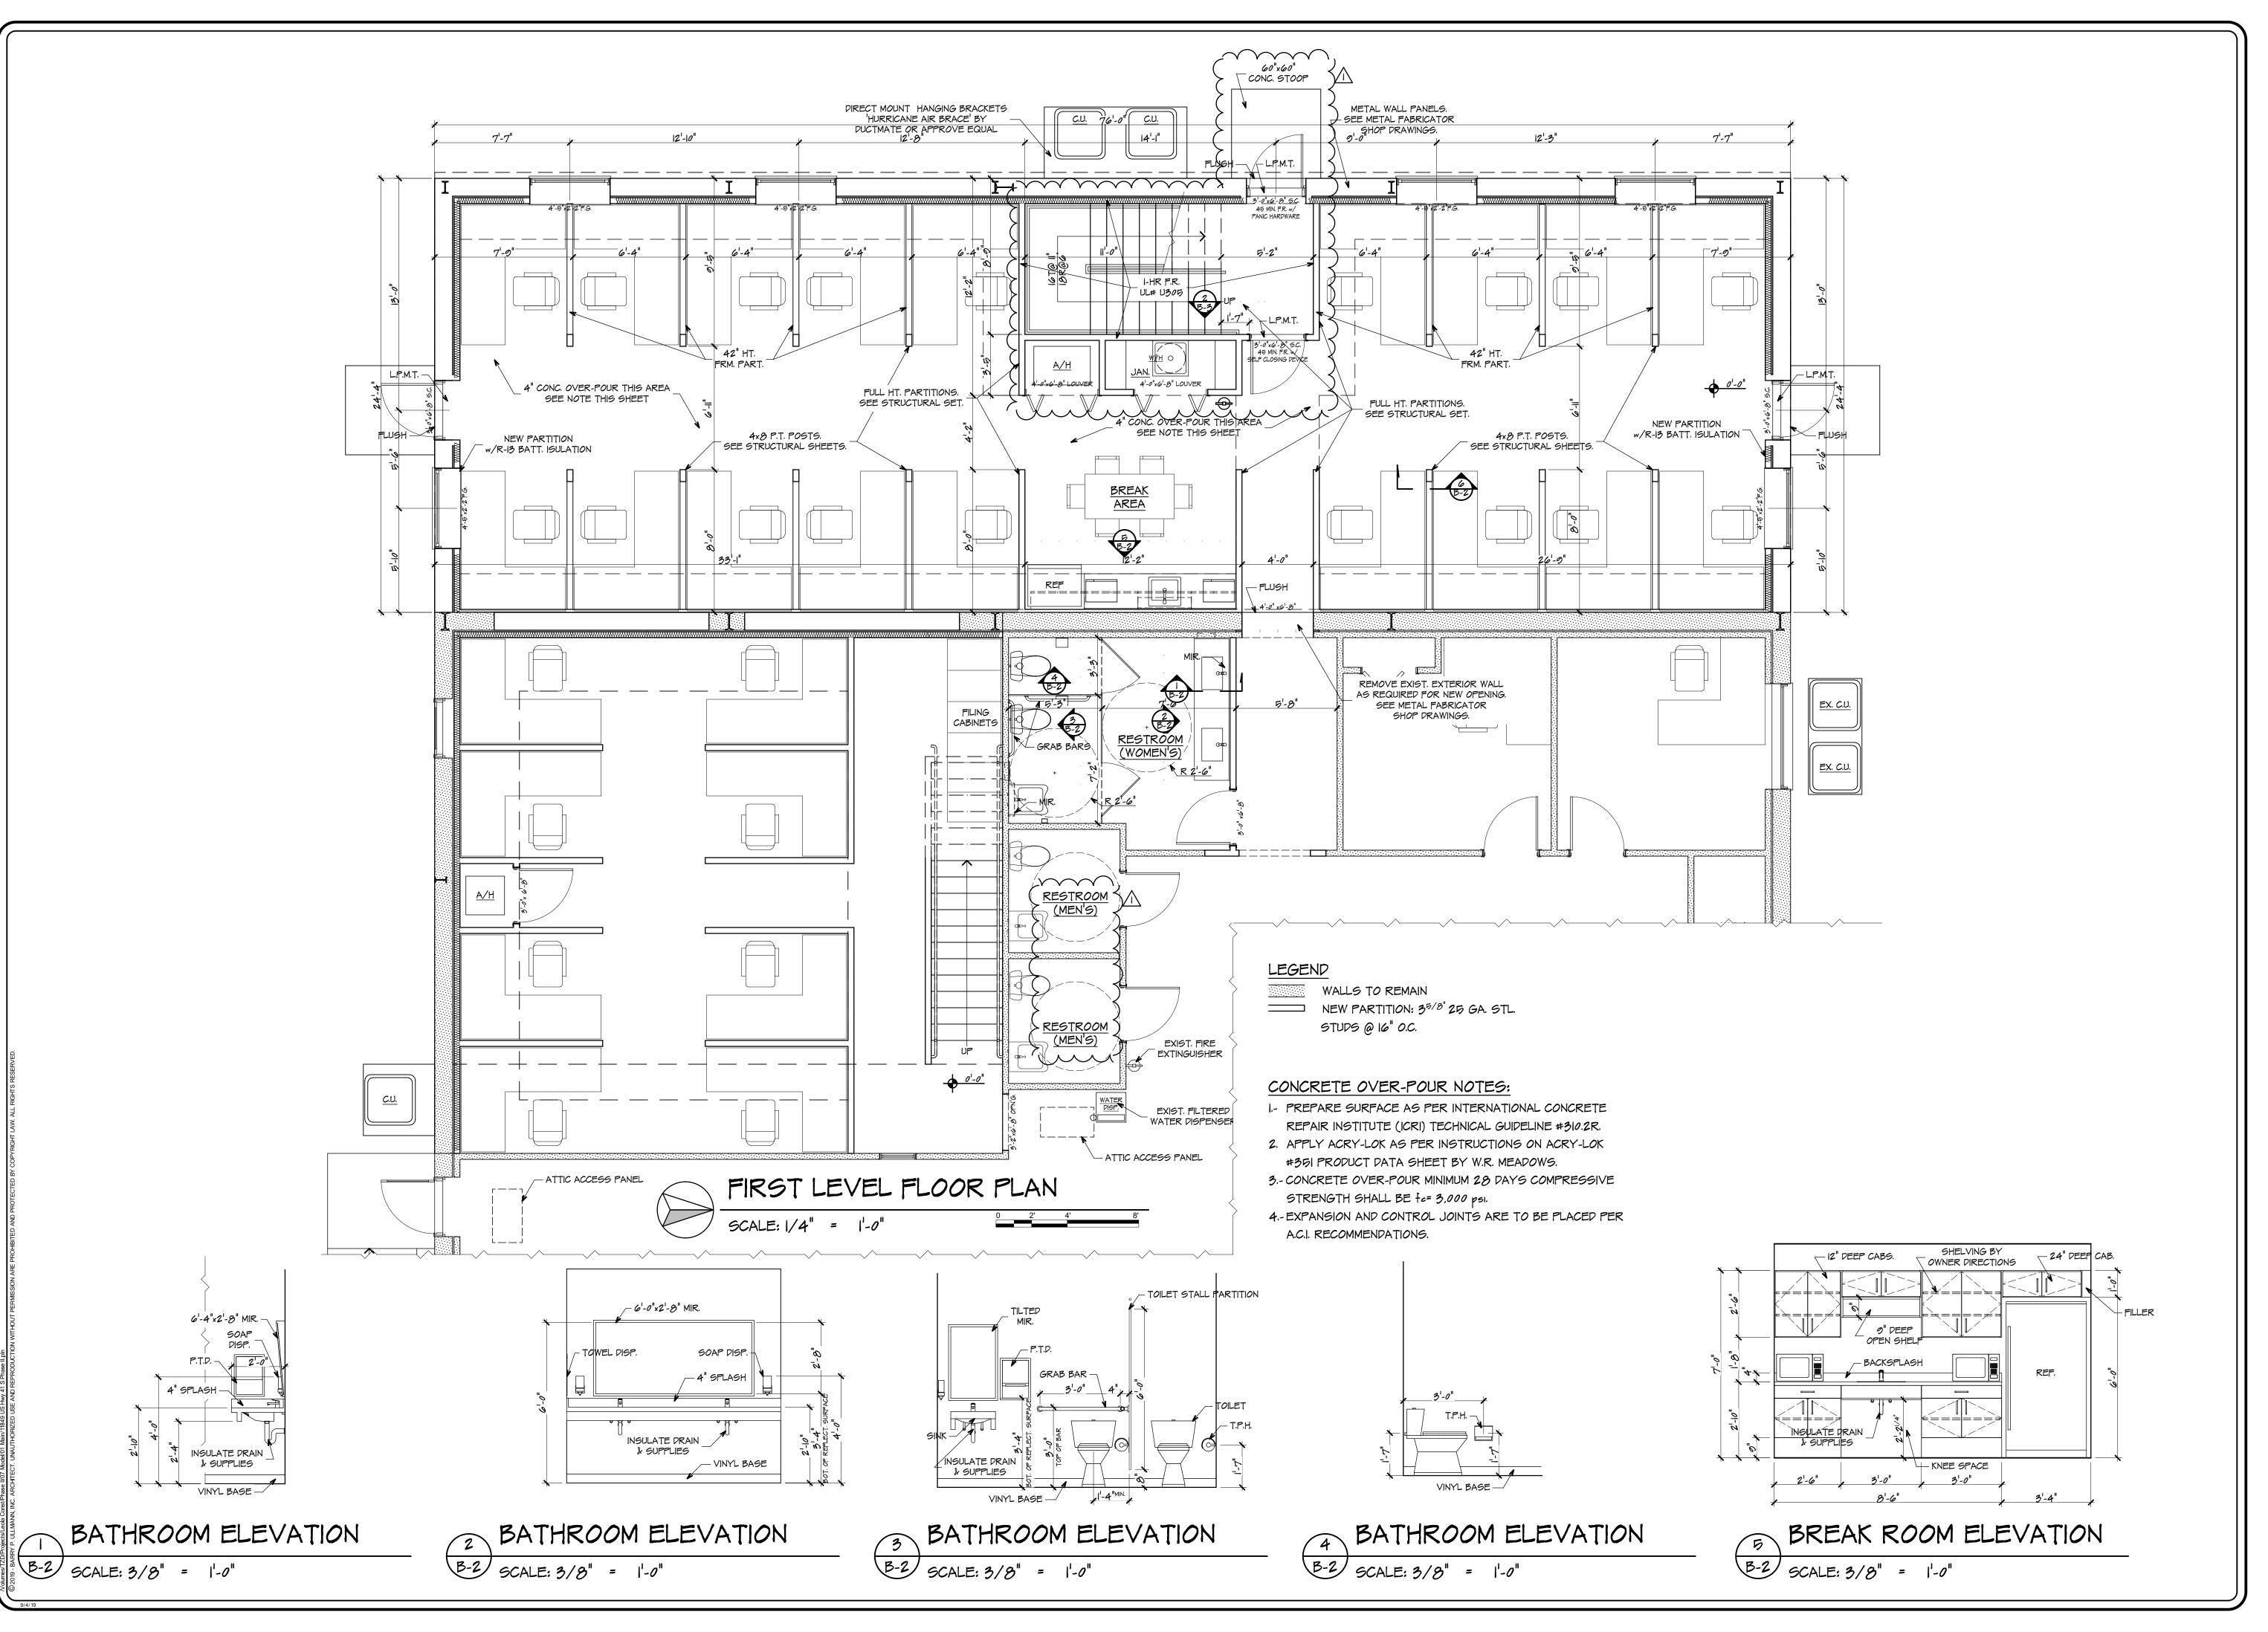

REVISIONS

DATE


| PLAN REVIEW COMMENTS 08/29/19


Jo. 7514

RY P. ULLMAN ARCHITECT

93534 GLEARW

NU KUC IONS PLORIDA

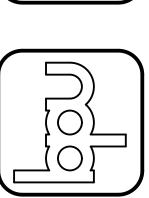

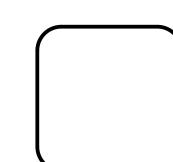


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REVISIONS

| PLAN REVIEW COMMENTS | 08/29/19

No. 7514 PH:727-441-4405


AY P. ULLMAN ARCHITECT A REGISTRATION No. 751

93534 615 S. MISS

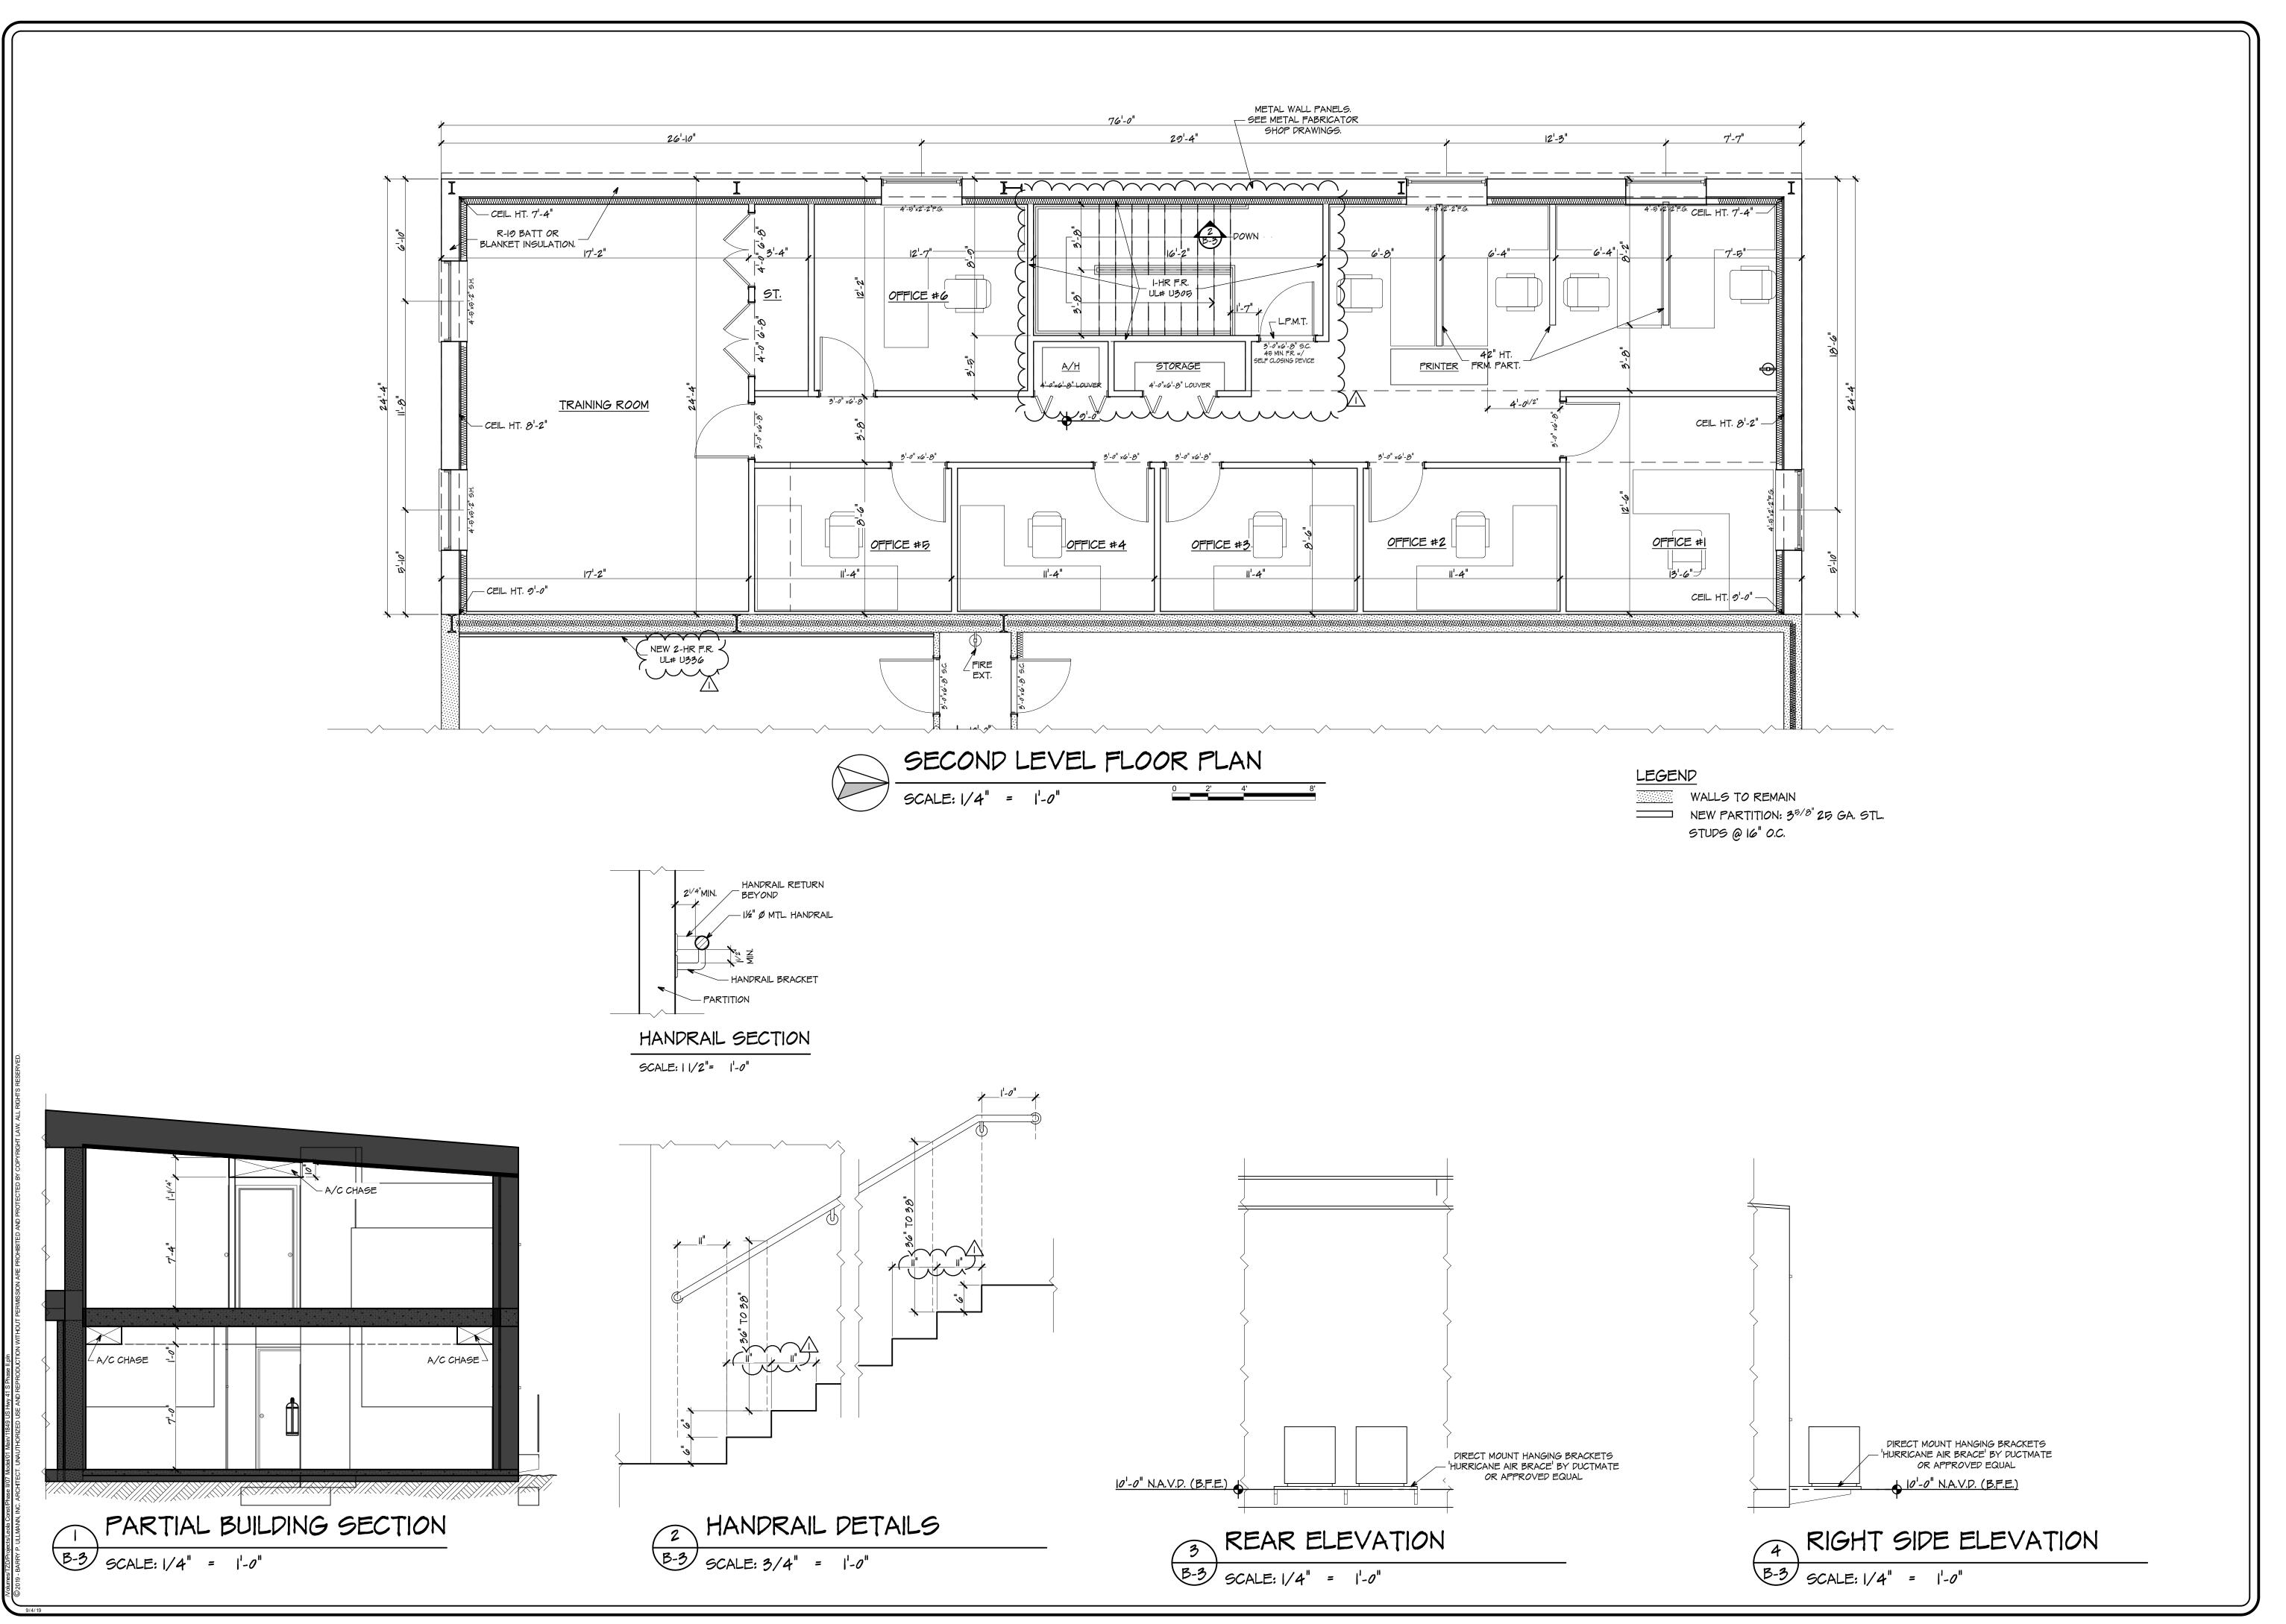RUCTIONS FLORIDA 3352

77074 70NV 1.0349 US HWY 41 8 BSONTON



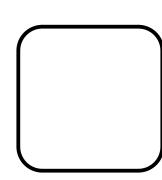


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08/07/2000

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| PLAN REVIEW COMMENTS | 08/

-LMANN =CT 10N No. 7514 PH:727-441-440


ARCHITECT
LORIDA REGISTRATION No.
SSOURI AVE, SUITE B. PHE


RIPA 33534

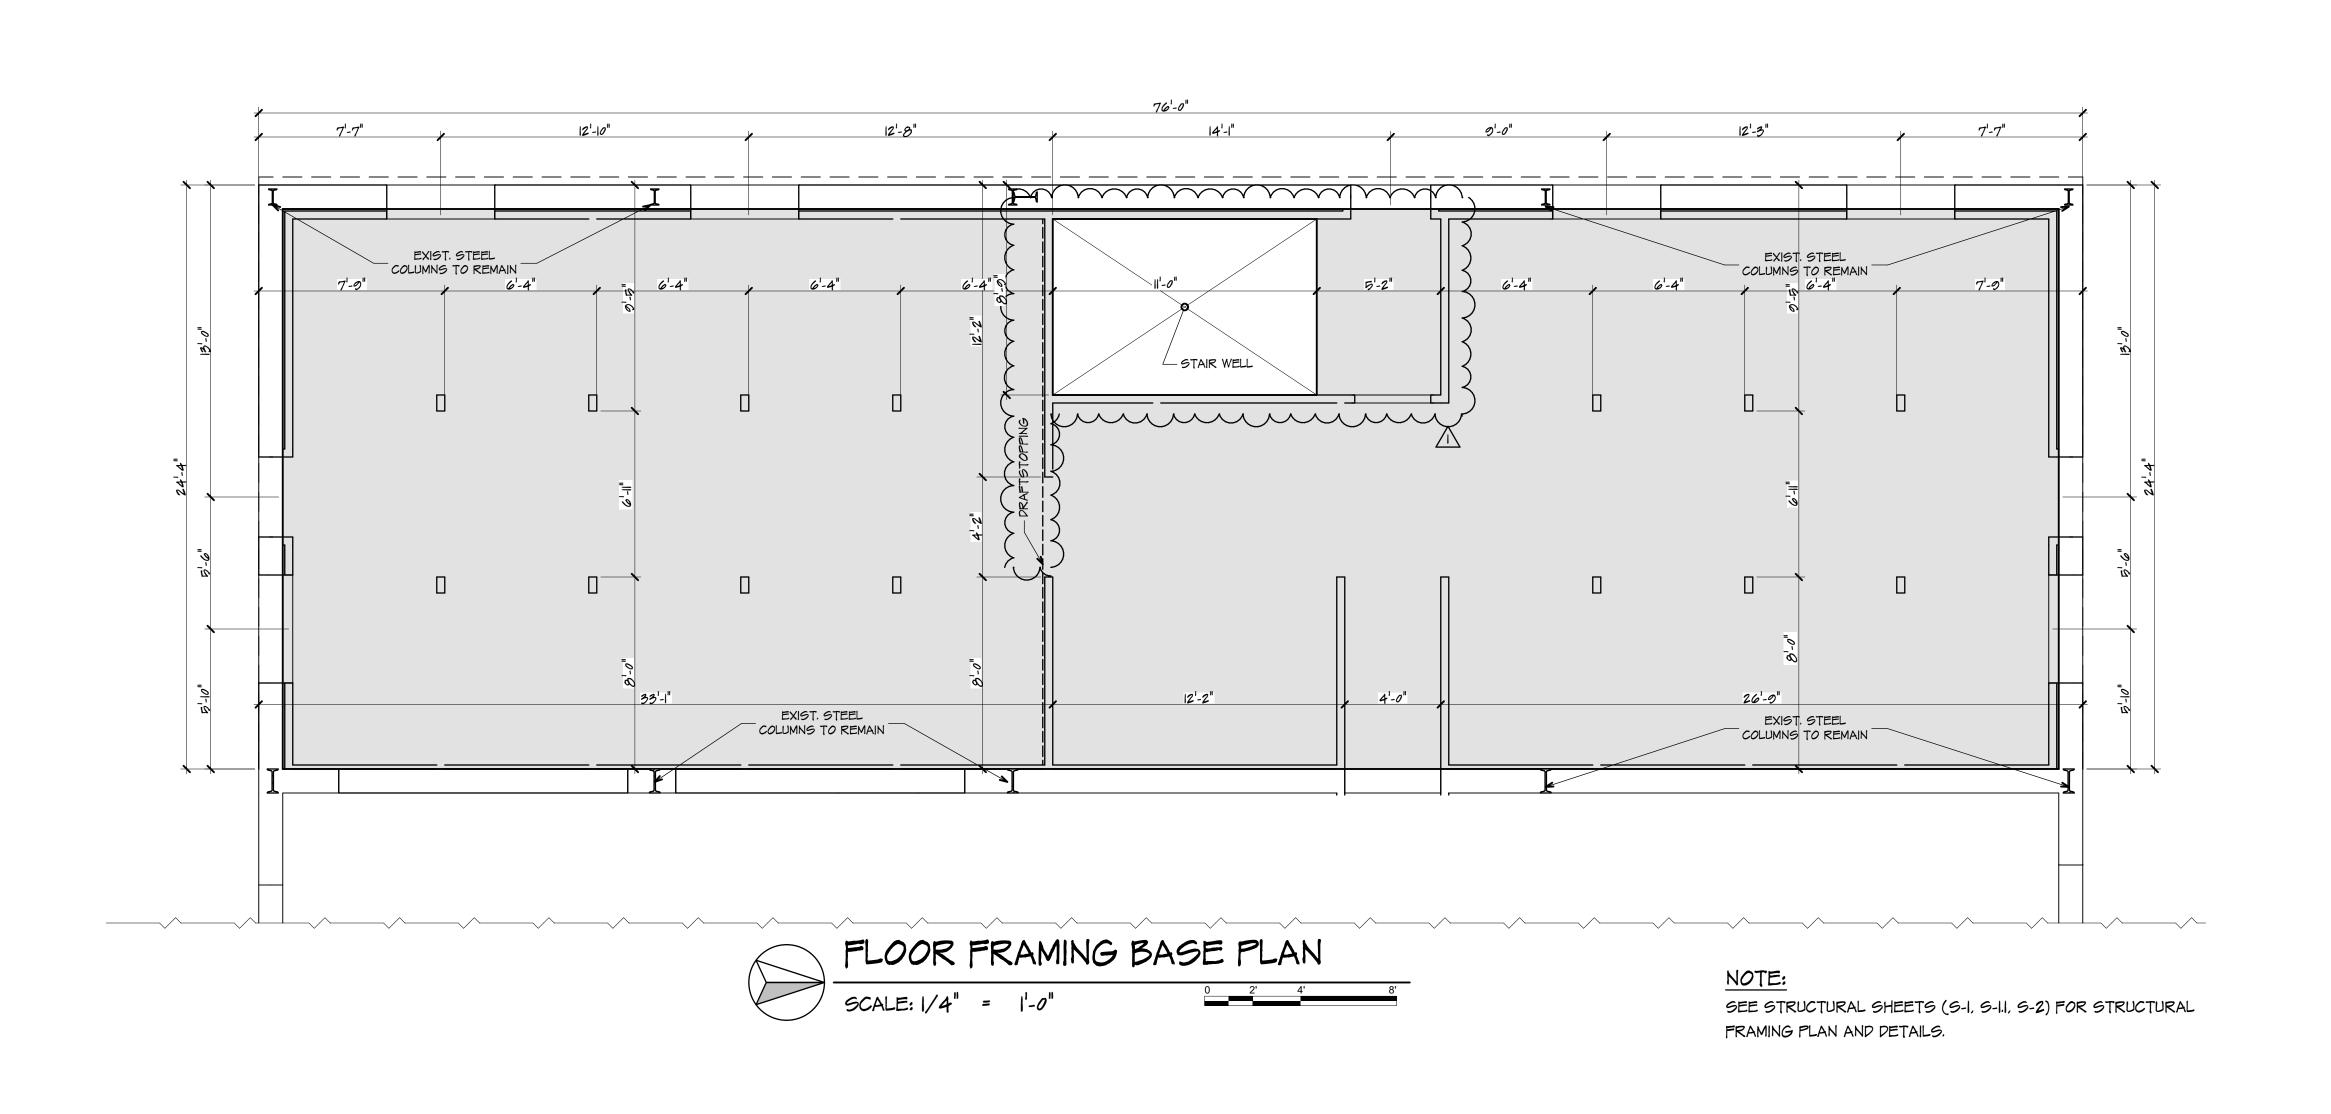SLING & BUILD-OUT
NOTRUCTION

LEOLA CON 1849 US HWY 41 S SIRSONTON



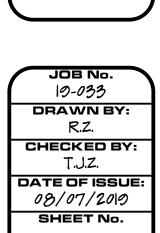

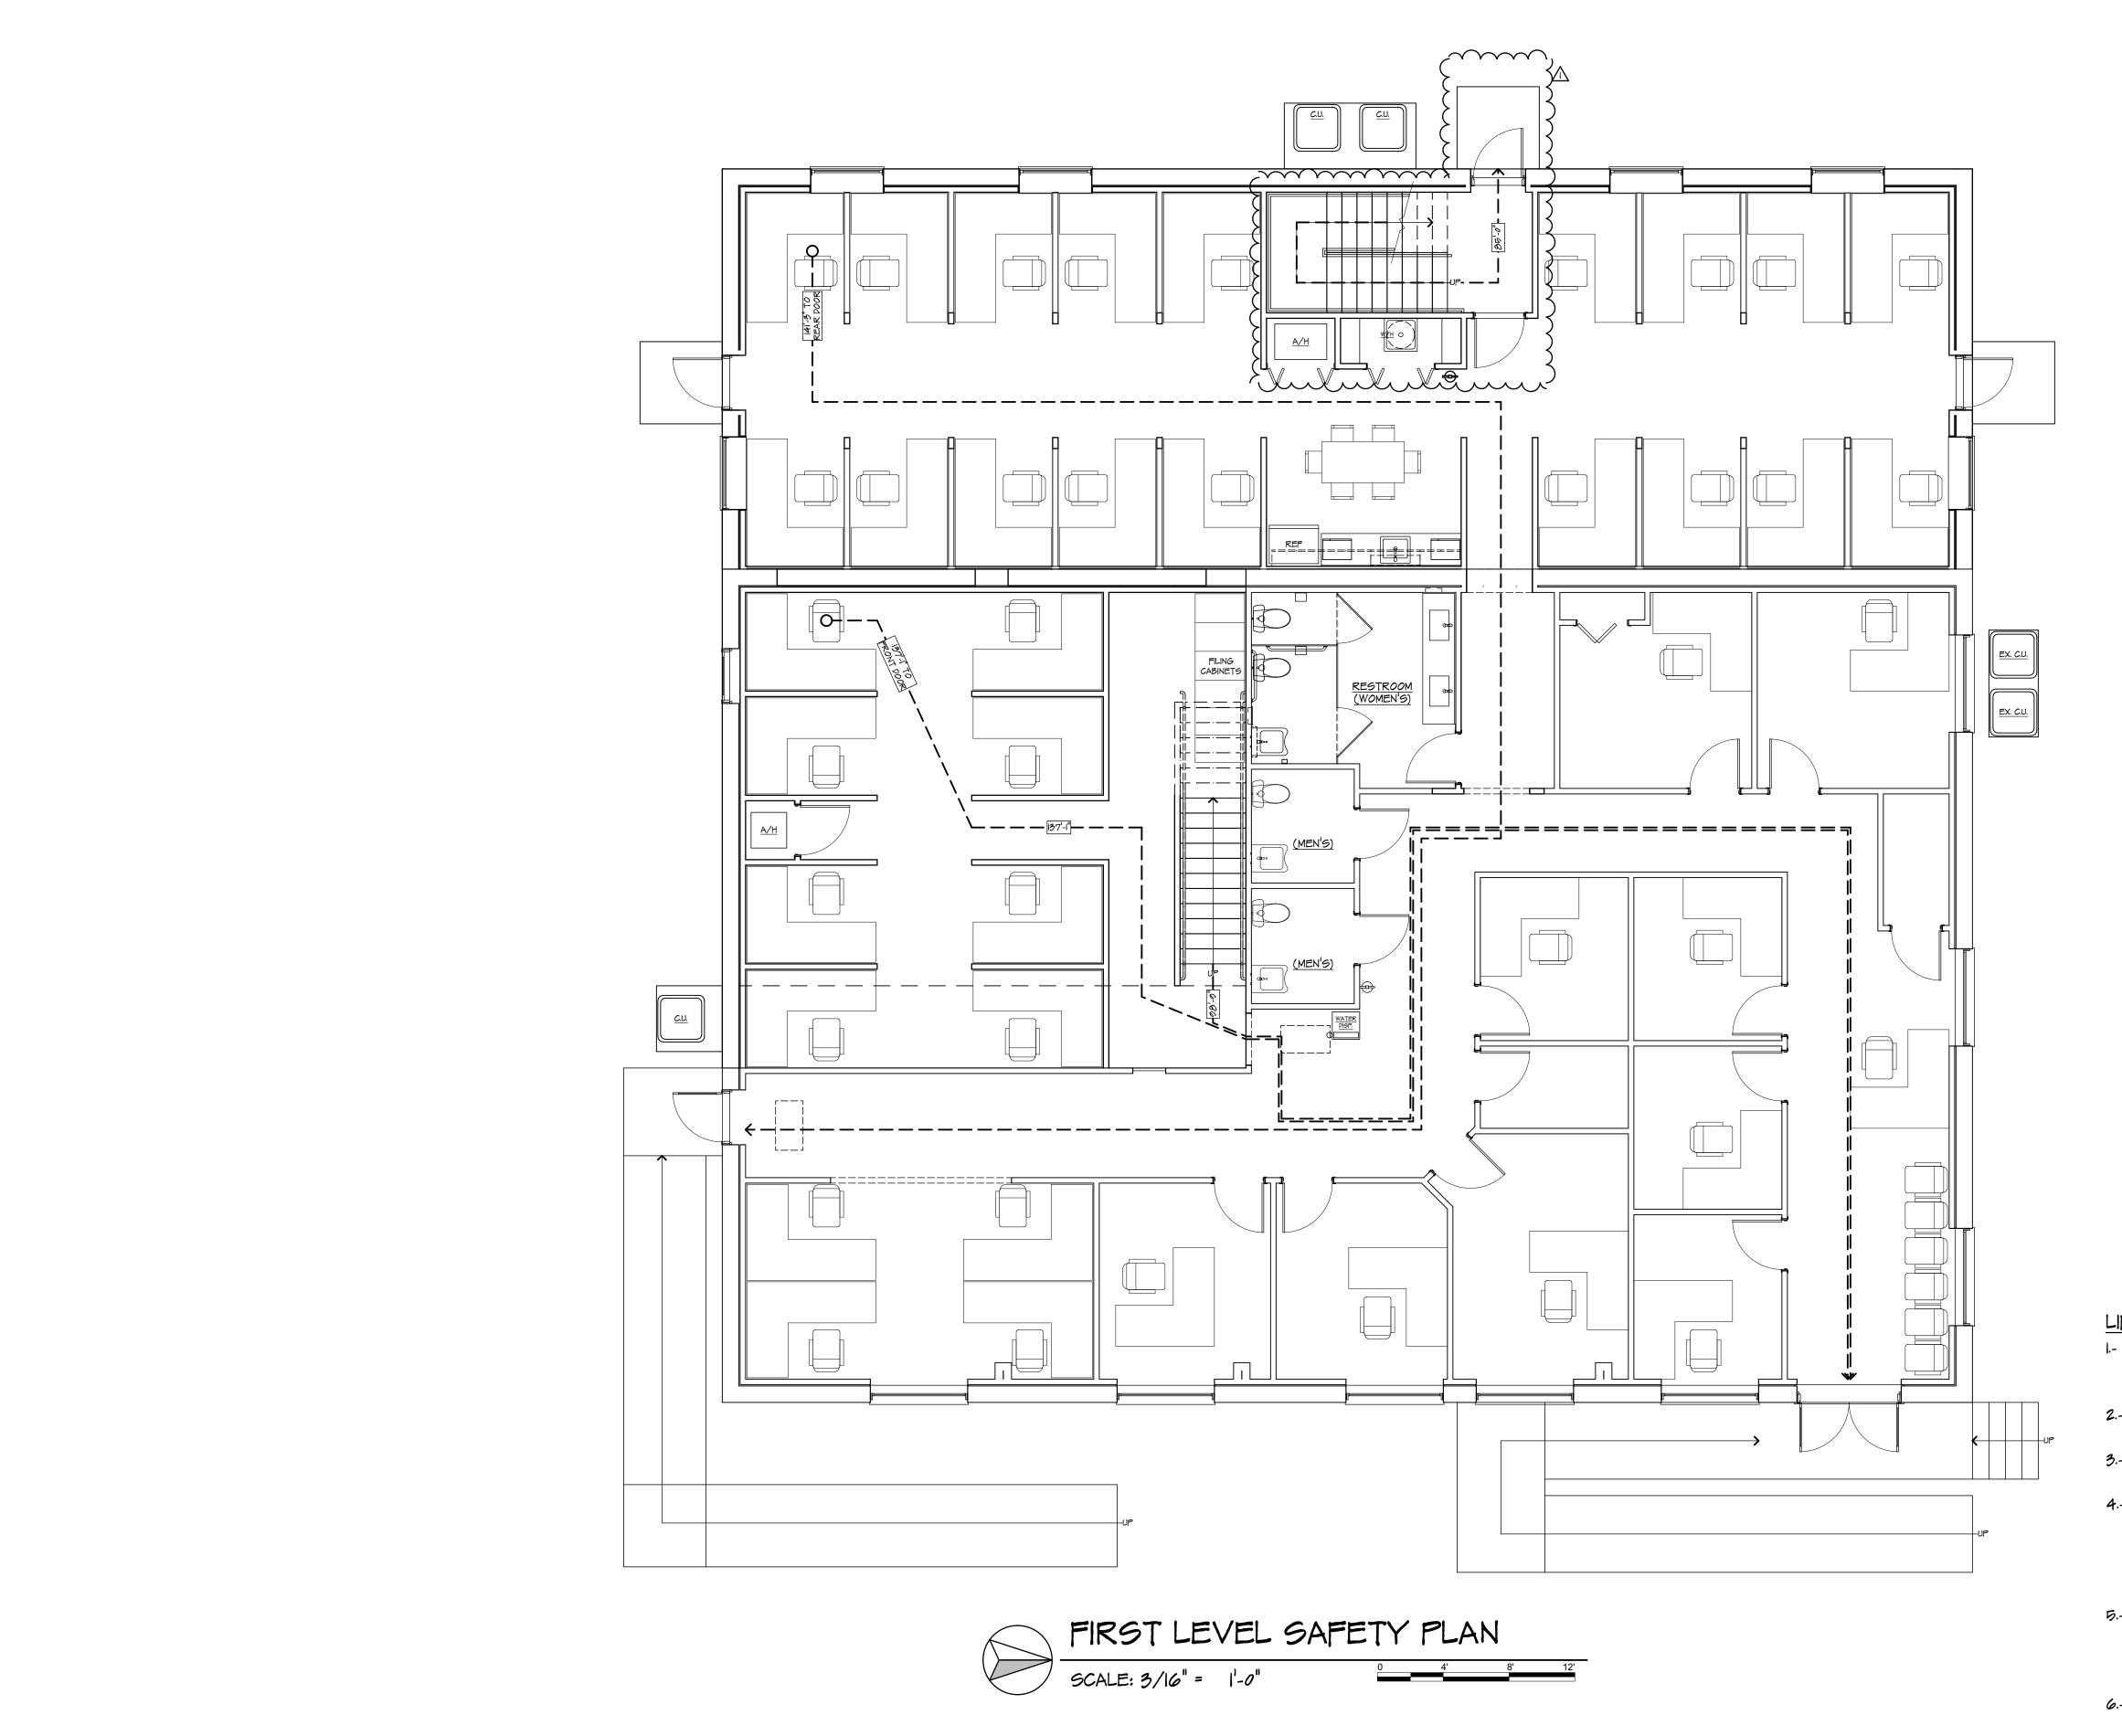


19-033 DRAWN BY: R.Z. CHECKED BY: T.J.Z. DATE OF ISSUE: 08/07/2019

B-5

SHEET No.

LIFE SAFETY NOTES:

- I.- ALL INTERIOR WALLS (EXISTING & NEW) ARE OR WILL BE GYPSUM BOARD, CLASS A MATERIALS, FINISHES BY OWNER SELECTION.
- 2.- EXISTING CEILINGS TO REMAIN ARE GYPSUM BOARD, CLASS A MATERIALS.
- 3.- NEW CEILINGS PROPOSED WILL BE GYPSUM BOARD, CLASS A MATERIALS.
- 4.- PROVIDE TACTILE SIGNAGE PER LSCIOI CH. 7.10.1.32 & CH. 36.2.10, LOCATED AT EXIT DOOR. TACTILE SIGNAGE SHALL READ AS FOLLOWS: 'EXIT'. TACTILE SIGNAGE SHALL COMPLY W/ ICC/ANSI AII7.I AMERICAN NATIONAL STANDARD FOR ACCESSIBLE & USABLE BUILDINGS AND FACILITIES.
- 5.- A MINIMUM OF 6" IN HEIGHT NUMERICAL IDENTIFICATION SHALL BE PROVIDED ON BUILDING IN A VISIBLE LOCATION FROM THE STREET OR ROAD FRONTING THE PROPERTY, IN COMPLIANCE w/ NFPA-I CH. 10.12.1.1. VERIFY & PROVIDE IF NONE EXISTS.
- 6.- DRAPERIES, CURTAINS & OTHER SIMILAR LOOSELY HANGING FURNISHING AND DECORATIONS SHALL MEET THE FLAME PROPAGATION PERFORMANCE CRITERIA CONTAINED IN NFPA 701, 'STANDARD METHODS OF FIRE TESTS FOR FLAME PROPAGATION OF TEXTILES AND FILMS!.
- 7.- ALL DOOR HARDWARE TO BE A.D.A. APPROVED, LEVER STYLE, U.N.O..

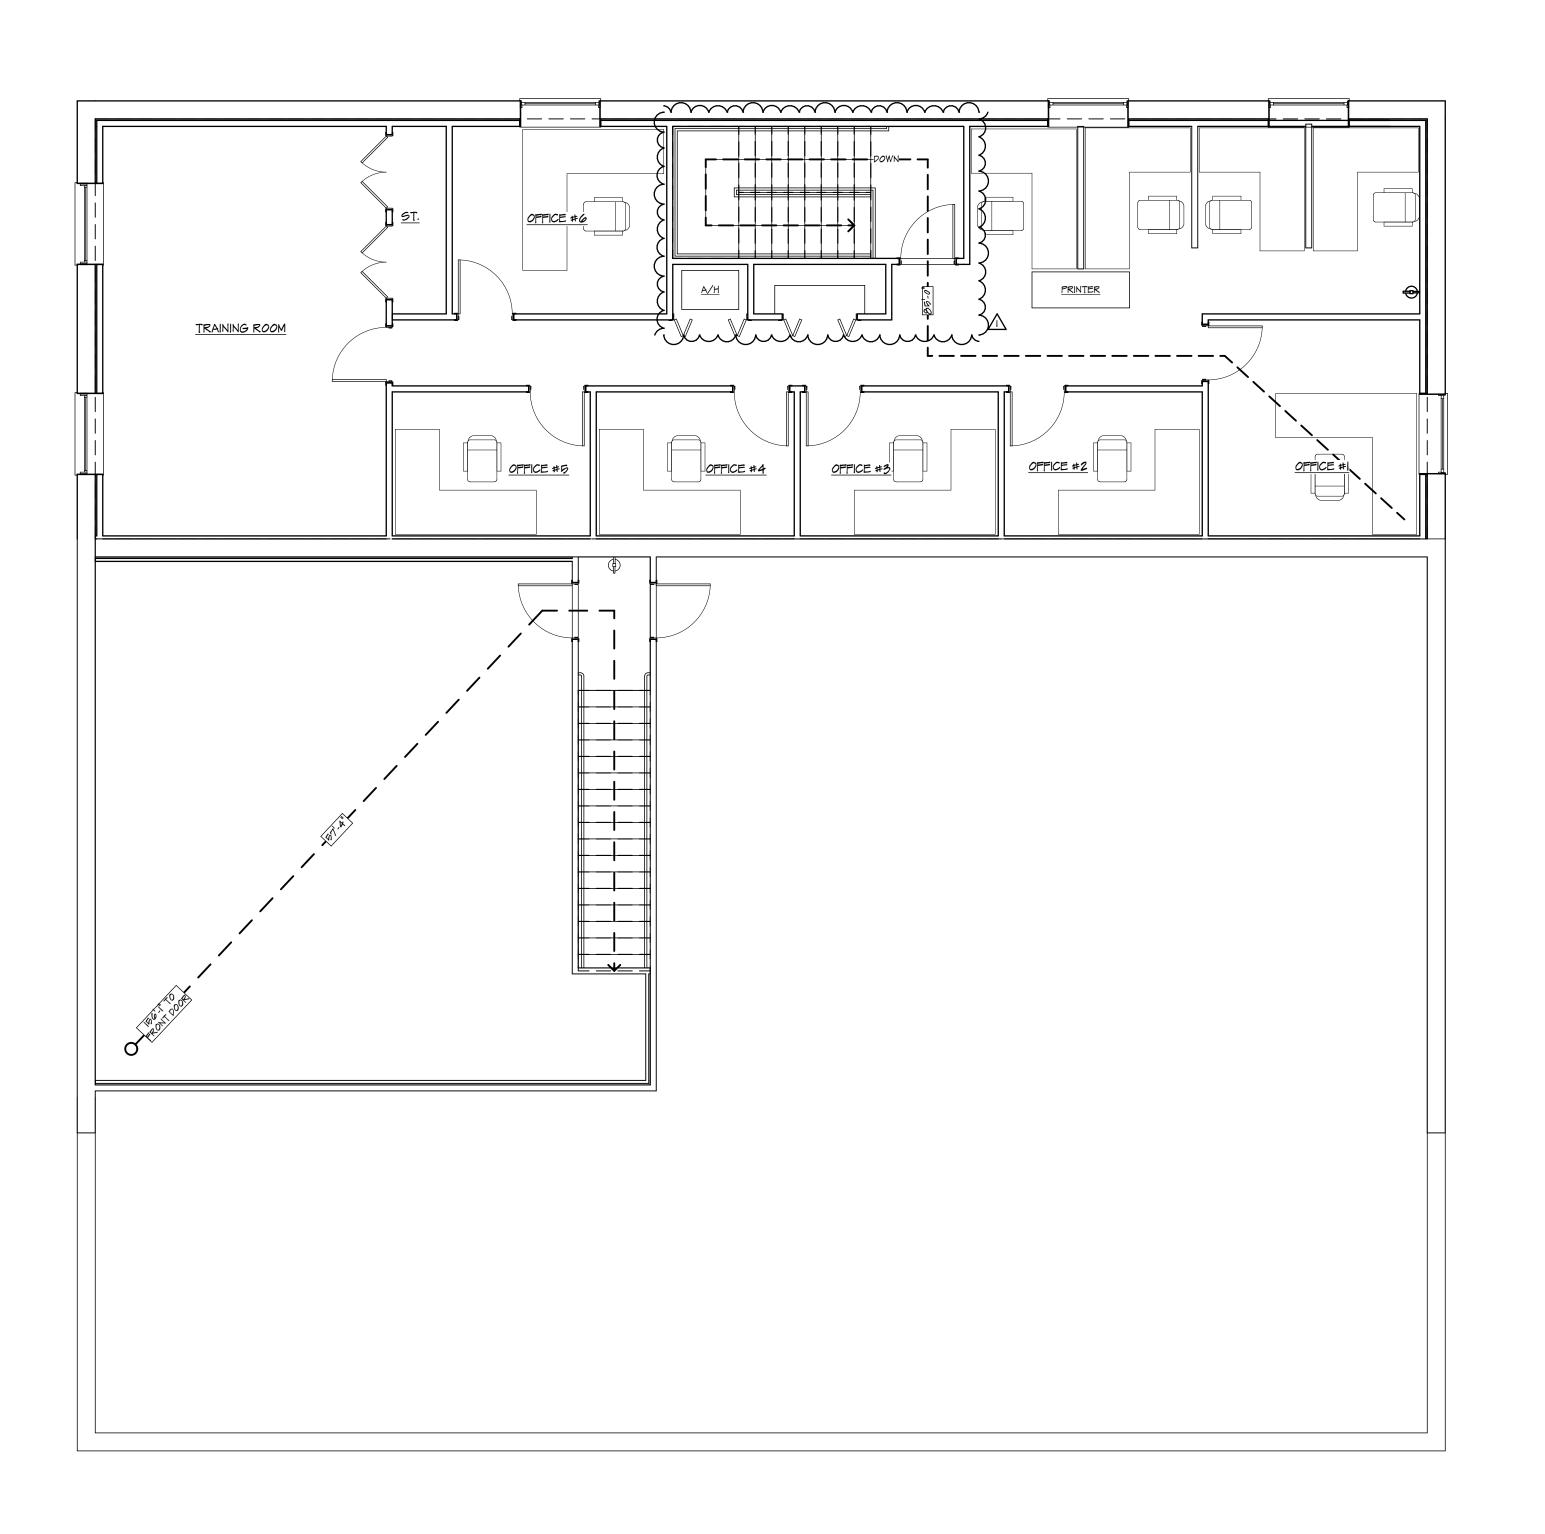



INTERIOR REMOPELING & BUILD-OUT FOR


LEOLA CONSTRUCTIONS

11849 US HWY 41 S

GIBSONTON

FLORIDA 3353



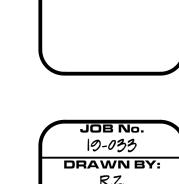

R.Z.

CHECKED BY:

T.J.Z.

DATE OF ISSUE:


08/07/2010

SHEET No.



1ST FLOOR ELECTRICAL PLAN

SCALE 1/4" = 1'-0"

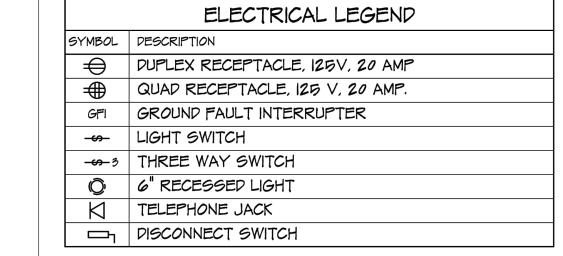

LIGHTING LEGEND

1'X4' WRAPAROUND LED FIXTURE

⇒ ELECT. DEVICES TO REMAIN.⇒ NEW ELECTRICAL DEVICES.

6" RECESSED DOWNLIGHT IØW LED


EMERGENCY LIGHT WITH BATTERY BACK UP

EMERGENCY/EXIT LIGHT WITH BATTERY BACK UP


EXIT LIGHT WITH BATTERY BACK UP

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1849 US HWY 41 S GIBSONTON


08/29 PLAN REVIEW COMMENTS

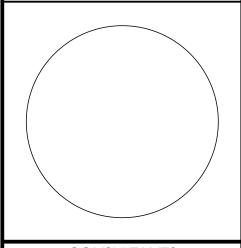MARK DATE REVISION


DATE OF ISSUE: 08/07/2010
PROJECT No.: 10-033
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SHEET TITLE
ELECTRICAL
PLANS

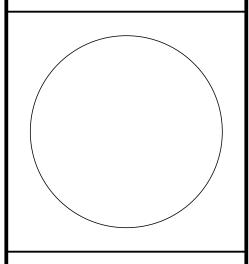
E-1

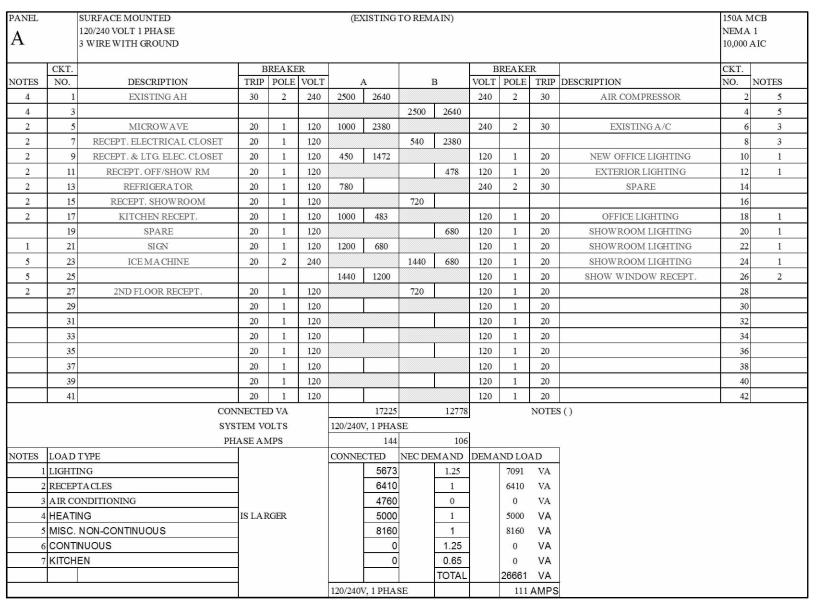


						120/240	V, 1 PHA	SE			111	AMPS				┙
C C		SURFACE MOUNTED 120/240 VOLT 1 PHASE 3 WIRE WITH GROUND												200A NEMA 10,000	. 1	
	CKT.		71110	REA KI						/	REAKE	*********		CKT.		1
NOTES	NO.	DESCRIPTION	TRIP		VOLT	_	A	1	В	VOLT	POLE	TRIP	DESCRIPTION	NO.	NOTES	_
4	1	AH-1	50	2	240	4422	1088			120	1	20	1ST FLOOR LIGHTING	2	1	_
4	3						<u> </u>	4422	960	120	1	20	1ST FLOOR LIGHTING	4	1	_
4	5	AH-2	50	2	240	4422	900			120	1	20	1ST FLOOR RECEPT.	6	2	
4	7							4422	900	120	1	20	IST FLOOR RECEPT.	8	2	
3	9	CU-1	40	2	240	3360	900			120	1	20	1ST FLOOR RECEPT.	10	2	
3	11							3360	900	120	1	20	1ST FLOOR RECEPT.	12	2	
3	13	CU-2	40	2	240	3360	720			120	1	20	1ST FLOOR RECEPT.	14	2	
3	15							3360	720	120	1	20	1ST FLOOR RECEPT.	16	2	
2	17	2ND FLOOR RECEPT.	20	1	120	720				120	1	20	2ND FLOOR LIGHTING	18	1	1
2	19	2ND FLOOR RECEPT.	20	1	120			540		120	1	20	2ND FLOOR LIGHTING	20	1	1
2	21	2ND FLOOR RECEPT.	20	1	120	900	360			120	1	20	2ND FLOOR RECEPT.	22	2	
2	23	2ND FLOOR RECEPT.	20	1	120			1080	360	120	1	20	2ND FLOOR RECEPT.	24	2	1
2	25	2ND FLOOR RECEPT.	20	1	120	720	1000			120	1	20	BREAK ROOM RECEPT.	26	2	1
2	27	BREAK ROOM MICROWAVE	20	1	120			1100	780	120	1	20	BREAK ROOM REFRIGERATOR	28	2	
	29						2250			240	2	30	WATER HEATER	30	\leftarrow	
	31								2250	-				32		1 ₹
	33															ł
	35													36		-
	37													38	<u> </u>	-
	39													40		-
	41													42		1
	-11	CON	NECTE	DVΔ			25122		25154			NOTES	S()	12		-
			STEM VO			120/240	V, 1 PHA		2010	J		TIOTES				
			IASE AN			120/240	209		210	1						
NOTES	LOAD		ASLAN	11 15		CONNE			MAND	DEMA	MDIO	A D				
1	LIGHT	1.5.1				CONNE	2048		1.25	DEMA	2560	VA				
2	200	TACLES					12600	-	1.23		11300					
		ONDITIONING	_				13440	4	0	_	0	VA				
	HEATI		IC I A D	CED				-								
			IS LAR	COEK			17688	+	1		17688					
		NON-CONTINUOUS					4500	+	1		4500	VA				
6		NUOUS	-				0	+	1.25	-	0	VA				
7	KITCH	EN					0	4	0.65	-	0	VA				
									TOTAL		36048					
						120/240	V, 1 PHA	SE			150	AMPS				

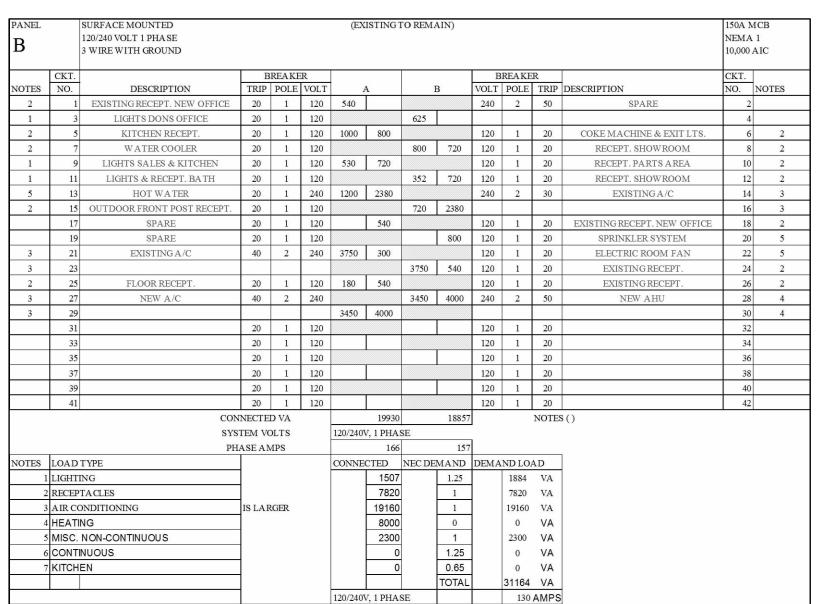


LOAD CALCULATION

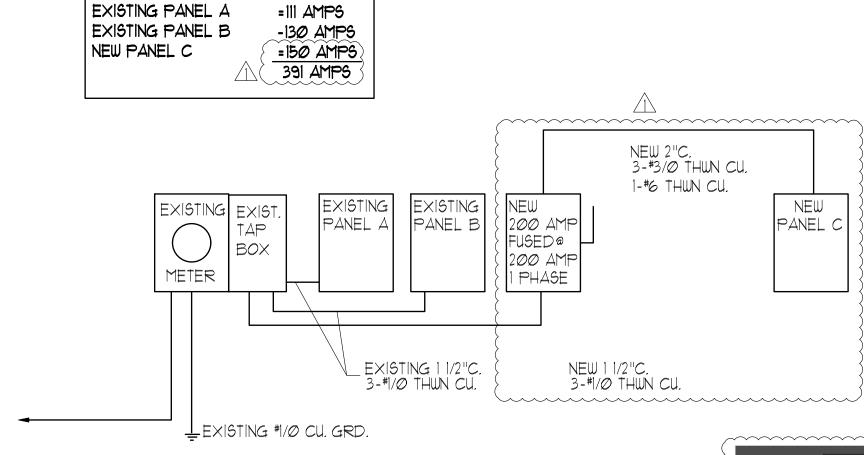

EXISTING SERVICE RISER DIAGRAM 120/240V 1 PHASE

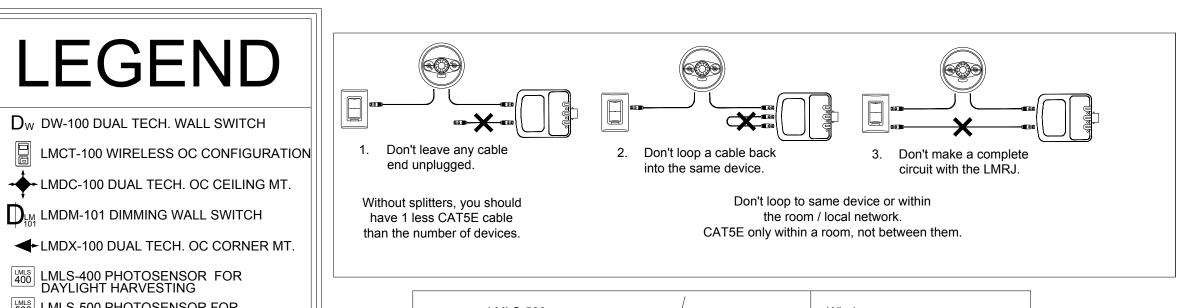

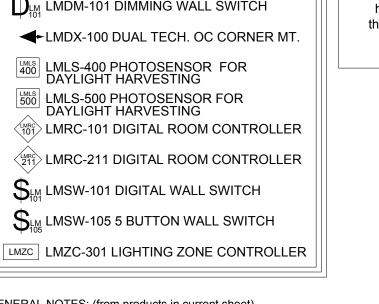


GENERAL NOTES: (from products in current sheet) a.)Device placement must be field verified for compliance with all product guidelines located in the installation instructions b.)Review data sheets and installation instructions for product specifics and limitations. c.)See contract documents for engineer's notes to ensure d.)Sensors shall be mounted no closer than 6' to an air supply or

e.)CAT5E cables must be either factory terminated or fully tested

as well as field verified prior to startup.

LMLS-400 PHOTOSENSOR FOR DAYLIGHT HARVESTING

LMLS-500 PHOTOSENSOR FOR DAYLIGHT HARVESTING

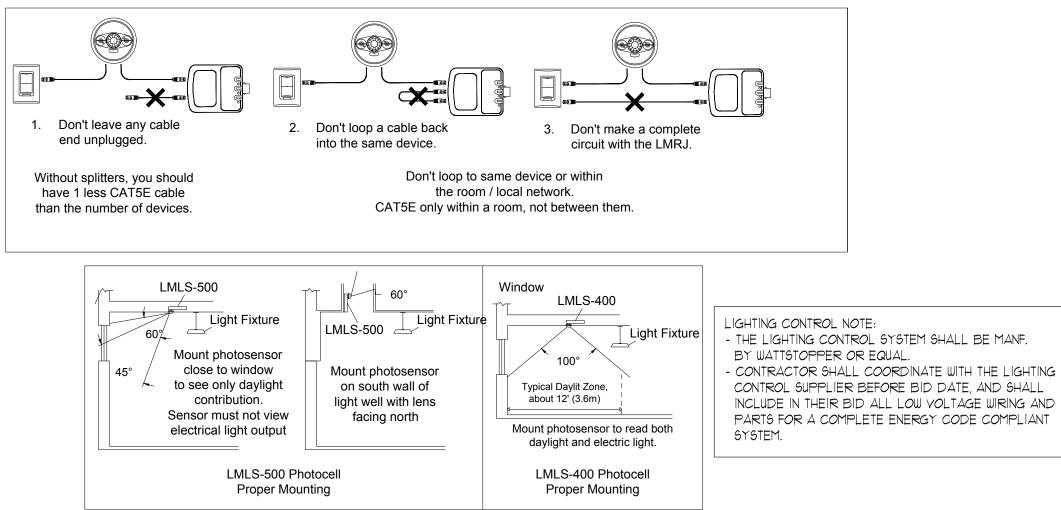

GENERAL NOTES

- CONTRACTOR SHALL VISIT THE SITE AND FAMILIARIZE HIMSELF WITH EXISTING CONDITIONS PRIOR TO SUBMITTING A PROPOSAL.
- ALL WORK SHALL BE IN ACCORDANCE WITH THE 2014 EDITION OF THE NATIONAL ELECTRICAL CODE.
- ALL CONDUCTORS SHALL BE COPPER, #12 MINIMUM.
- ALL CONDUITS SHALL HAVE A PROPERLY SIZED EQUIPMENT GROUNDING CONDUCTOR.
- PROVIDE ALL NECESSARY PULL/JUNCTION BOXES, SUPPORTS AND MISC. ITEMS FOR A COMPLETE
- ullet THE USE OF TYPE 'NM-B' CABLE MAY BE USED, IF ${\scriptscriptstyle (}$ IT MEETS THE REQUIREMENTS OF THE N.E.C.

OF SUSPENDED CEILINGS.

OTHER TRADES.


- PROVIDE TYPE WRITTEN PANEL DIRECTORIES.
- · ALL WIRING SHALL BE IN A CONTINUOUS CONDUIT SYSTEM. • ALL LIGHT FIXTURES SHALL BE SUPPORTED INDEPENDENTLY
- ELECTRICAL WORK SHALL BE COORDINATED WITH ALL
- SWITCHES AND RECEPTACLES SHALL BE 20 AMP COMMERCIAL
- GRADE AND IVORY IN COLOR. PROVIDE MATCHING COVER CONCEAL ALL CONDUITS AND BOXES UNLESS OTHERWISE
- COORDINATE ALL POWER REQUIREMENTS WITH LOCAL POWER
- COMPANY ENGINEER. PROVIDE AND MAINTAIN TEMPORARY POWER AND LIGHTING
- SYSTEM FOR DURATION OF THE PROJECT.
- EMT FITTINGS SHALL BE DIE CAST SET SCREW.
- MAKE FINAL CONNECTIONS TO EQUIPMENT WITH FLEXIBLE METAL CONDUIT. LIQUID TIGHT WHERE EXPOSED TO WEATHER.
- ALL LIGHTING CONTROLS TO MEET THE FBC ENERGY CODE 6TH EDITION 2017.

F.B.C. ENERGY CODE 6TH EDITION 2017

• ALL LIGHTING CONTROLS TO MEET THE FBC ENERGY CODE 6TH EDITION 2017. VOLTAGE DROP CONSIDERATIONS FOR CUSTOMER OWNED SERVICE ENTRANCE AND BRANCH CIRCUIT CONDUCTORS


HAVE BEEN INCLUDED IN THE DESIGN OF THE ELECTRICAL SYSTEM AS REQUIRED BY THE 6TH EDITION (2017) FLORIDA ENERGY CONSERVATION CODE REFERENCE (C405.7.3.1 AND (C4Ø5.7.3.2)

F.B.C. ENERGY CODE VOLTAGE DROP NOTE FOR BRANCH CIRCUIT CONDUCTORS EVERY 15' IN LENGTH, THE WIRE SIZE SHALL BE INCREASED ONE WIRE SIZE TO MEET THE PROVISIONS OF NO MORE THAN 3% VOLTAGE DROP ON ANY BRANCH CIRCUIT

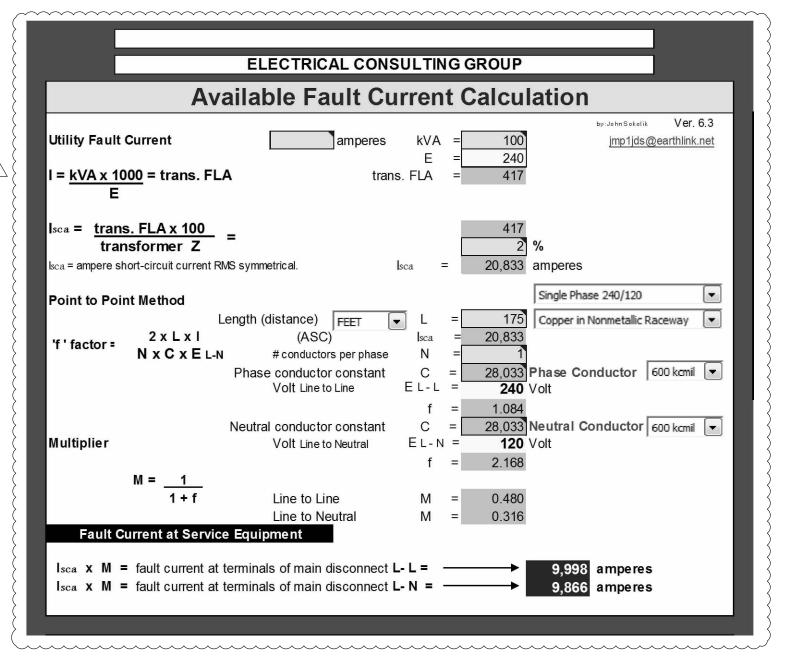




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4

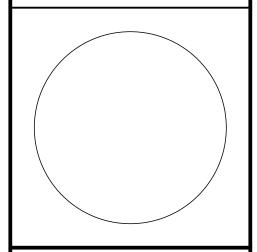
108/20 PLAN REVIEW COMMENTS MARK DATE REVISION

DATE OF ISSUE: *08/07/2019* PROJECT No. 10-033 R.Z. DRAWN BY: BH./C.L CHECKED BY:

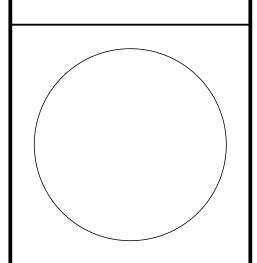
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SHEET TITLE ELECTRICAL NOTES, DETAILS


E-2



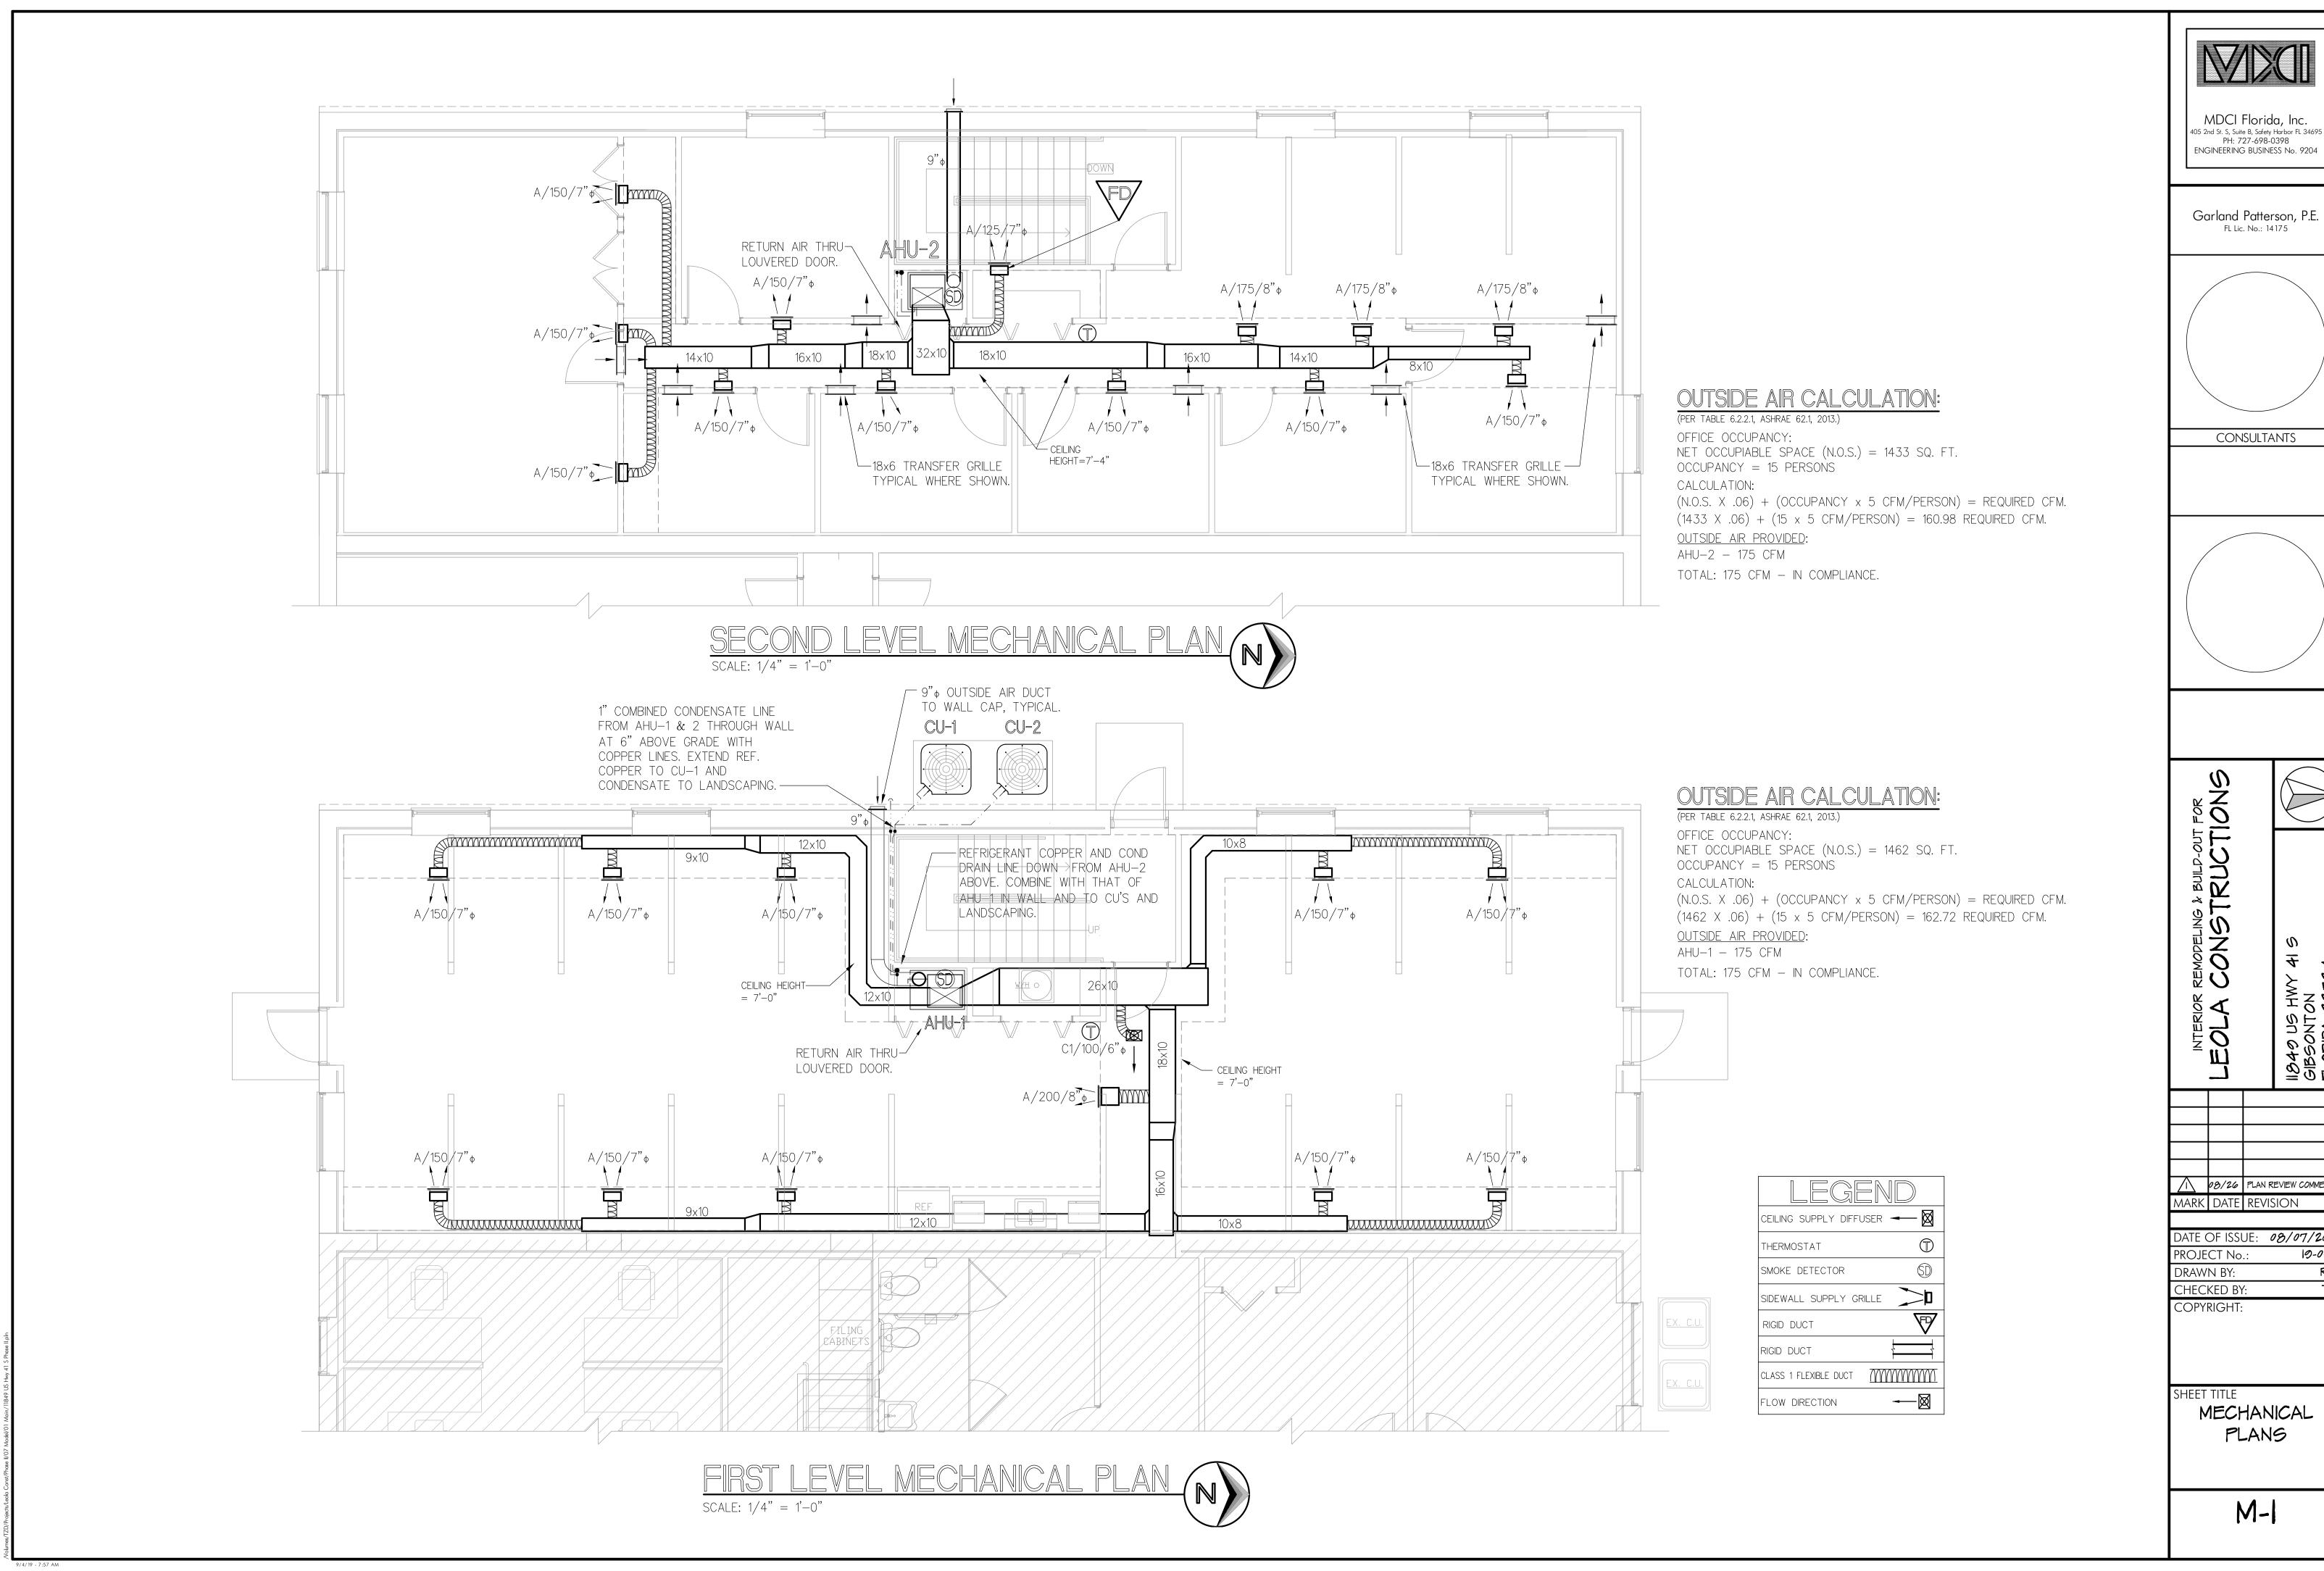

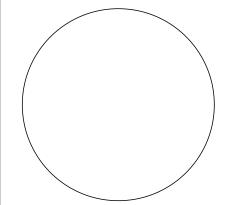

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1 08/26 PLAN REVIEW COMMENTS Mark | Date | Revision

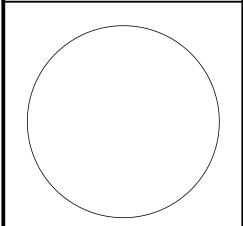DATE OF ISSUE: 08/07/2019 10-033 R.Z.

MECHANICAL PLANS

M-1

MECHANICAL GENERAL NOTES:


- 1. DUCT SIZES ARE CLEAR, INSIDE DIMENSIONS. VERIFY ALL DIMENSIONS AND LOCATIONS PRIOR TO FABRICATION OR INSTALLATION.
 ALL DUCTWORK SHALL BE TYPE 475 FIBERGLASS EQUAL TO JOHNS—MANVILLE. DUCT
- SHALL BE 1" THICK WITH AN "R" VALUE OF 4.2.

 ALL DUCT SHALL BE CONSTRUCTED AND INSTALLED PER SMACNA REQUIREMENTS.
- 2. ALL GRILLES SHALL HAVE AN OPPOSED BLADE DAMPER FOR BALANCING PURPOSES.
 3. ALL SYSTEMS 2000 CFM AND OVER SHALL HAVE A SMOKE DETECTOR INSTALLED IN THE SUPPLY DUCTWORK. DETECTOR SHALL BE 24 VOLT POWERED FROM THE UNIT'S LOW VOLTAGE PANEL UNLESS THERE IS A FIRE ALARM SYSTEM. THEN THE DETECTOR SHALL BE 120 VOLTS, SUPPLIED BY THE FIRE ALARM CONTRACTOR, INSTALLED BY THE HVAC CONTRACTOR AND WIRED BY FIRE ALARM. PROVIDE L.E.D. AND HORN ALARM STATIONS IN AREA MONITORED DURING BUSINESS HOURS, PER CODE.
- 4. ALL ROOF AND WALL PENETRATIONS SHALL BE MADE AND SEALED BY THE GENERAL CONTRACTOR.
 5. EXTEND SCHEDULE 40 PVC CONDENSATE DRAIN LINES FROM AIR HANDLER(S) TO EXTERIOR
 AND GRASS/LANDSCAPE AREA. PROVIDE 24"x24"x24" DEEP DRYWELL WITH RIVER GRAVEL IF
 NO APPROVED SURFACES EXIST ON WHICH TO DRAIN. INSULATE ENTIRE LENGTH WITH 3/16"
 WALL ARMAFLEX OR OTHER TYPE INSULATION. PROVIDE SAFE—T SWITCH AT AHU AND
 FLOAT SWITCH AT SECONDARY PAN.
- 6. DEVIATION FROM MATERIALS, METHODS, OR PROCEDURES SET FORTH HERIN MUST BE APPROVED, IN WRITING, BY ENGINEER PRIOR TO SUBMISSION OF BID, ORDER, FABRICATION OR INSTALLATION.
- 7. ANY AND ALL QUESTIONS AS TO THE INTENT OF, OR PROCEDURES SET FORTH IN THESE DRAWINGS MUST BE BROUGHT TO THE ATTENTION OF THE ENGINEER PRIOR TO SUBMISSION OF A BID. LACK OF KNOWLEDGE OR UNDERSTANDING OF PLANS SHALL NOT JUSTIFY ANY CLAIMS OR EXTRA COMPENSATION.
- 8. INSTALLATION SHALL COMPLY WITH ALL APPLICABLE LAWS, CODES, AND ORDINANCES.
 9. THE HVAC CONTRACTOR SHALL COORDINATE ALL EQUIPMENT, DUCT, & DIFFUSER LOCATIONS AND CLEARANCES WITH ALL OTHER TRADES ON PROJECT, IN PRECONSTRUCTION MEETING, PRIOR TO ANY ORDER, FABRICATION, OR INSTALLATION.
- 10. THERMOSTATS SHALL BE MANUFACTURER 7—DAY PROGRAMMABLE MODEL WITH SUB—BASE.

 MOUNT THERMOSTATS AT 48" ABOVE FINISHED FLOOR, TYPICAL.
- 11. SUPPLY DUCTWORK SHALL BE CONSTRUCTED, FABRICATED, AND INSTALLED IN ACCORDANCE WITH SMACNA REQUIREMENTS FOR A 1" POSITIVE STATIC PRESSURE CLASSIFICATION.
- 12. RETURN AND EXHAUST DUCTWORK SHALL BE CONSTRUCTED, FABRICATED, AND INSTALLED
- IN ACCORDANCE WITH SMACNA REQUIREMENTS FOR A 1" NEGATIVE STATIC PRESSURE.

 13. ALL EXHAUST FAN DISCHARGES AND PLUMBING VENTS SHALL BE A MINIMUM OF 10'—0" FROM
- FRESH-AIR INTAKES. COORDINATE WITH PLUMBING PLANS PRIOR TO INSTALLATION.


 14 THE MECHANICAL CONTRACTOR SHALL BALANCE ALL HVAC SYSTEMS ON THIS PROJECT TO
- 14. THE MECHANICAL CONTRACTOR SHALL BALANCE ALL HVAC SYSTEMS ON THIS PROJECT TO WITHIN 10% OF THE AIRFLOW QUANTITIES INDICATED ON THE MECHANICAL DRAWINGS.
- 15. REFRIGERANT COPPER LIQUID AND SUCTION LINES SHALL BE TYPE 'L' SOFT DRAWN AND SIZED PER MANUFACTURER'S RECOMMENDATIONS. INSULATE SUCTION LINE WITH 3/4" THICK "ARMAFLEX" INSULATION. TAPE ALL JOINTS TIGHT TOGETHER. REFRIGERANT PIPING CONFIGURATION SHALL ASSURE THAT THE REFRIGERANT OIL SATISFACTORILY RETURNS TO THE COMPRESSOR. PAINT ALL EXPOSED INSULATION WITH UV RESISTANT WHITE PAINT.

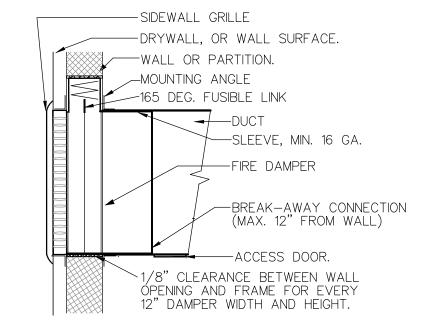

SIDEWALL GRILLE FIRE DAMPER DETAIL

NOTES:


- INSTALL DAMPER ACCORDING TO MANUFACTURER'S INSTRUCTIONS.
 RETAINING ANGLE SCREW SPACING SHALL NOT EXCEED 4" BETWEEN SCREWS.
- 3. CONNECT SLEEVE TO DUCT ON BOTH SIDES WITH STANDARD SLIP JOINT CONNECTORS.
- 4. SLEEVE SHALL NOT EXTEND MORE THAN 6" PAST WALL UNLESS A NO. 10 GAUGE METAL IS USED.
- 5. HVAC CONTRACTOR SHALL HAVE ON SITE A COPY OF THE MANUFACTURER'S INSTALLATION INSTRUCTIONS FOR USE BY THE MECHANICAL INSPECTOR TO VERIFY INSTALLATION.

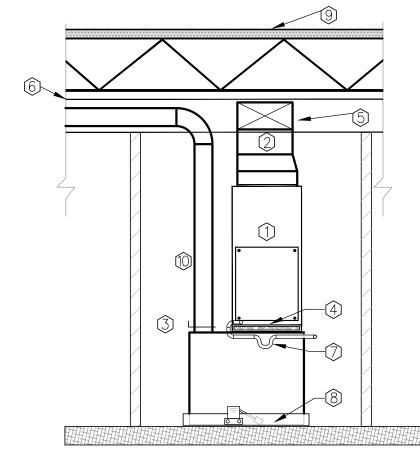

AIR HANDLER CLOSET DETAIL

- 1. AIR HANDLER SET ON MIN. 20 GAUGE STEEL BOX STAND WITH 1" INTERNAL INSULATION. FLANGE OPENINGS FOR AHU AND RETURN DUCT.
- 2. SUPPLY DUCT WITH 3-PIECE ELBOW,
 TRANSITION FROM UNIT DISCHARGE
 OPENING AFTER START-COLLAR TO PLAN
- DUCT SIZE AND CONTINUE.

 3. RETURN FLEX FROM SIDE OF BOX STAND.
 EXTEND TO FIELD FABRICATED GRILLE BOX
 AT SIDEWALL RETURN GRILLE.
- 4. FILTER RACK WITH 1" MERV 8 FILTER.
- 5. DUCT TRANSITION. USE 3-PIECE ELBOW FOR TURN TO HORIZONTAL, TYPICAL.
- 6. CEILING SYSTEM.
- 7. SCHEDULE 40 PVC DRAIN LINE TO EXTERIOR OR HUB DRAIN. INSULATE ENTIRE LENGTH WITH MIN 3/16" WALL ARMAFLEX INSULATION. PROVIDE SAFE—T SWITCH ON DRAIN LINE.
- 8. 2" SECONDARY DRAIN PAN WITH FLOAT SWITCH.
 9. DECK ABOVE OR ROOF SYSTEM WITH INSULATION.
- 10. OUTSIDE AIR DUCT FROM TOP OF BOX STAND WITH MANUAL VOLUME DAMPER TO WALL CAP.

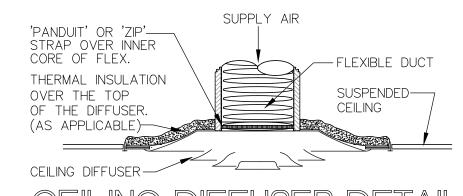


CEILING DIFFUSER DETAIL NO SCALE. FOR DIAGRAMATIC PURPOSES ONLY.

- NOTES:
- TAPE INNER COIL OF FLEX TO THE DIFFUSER
 COLLAR. TAPE COMPLETELY AROUND TO ASSURE
 AN AIR TIGHT SEAL OR USE 'ZIP' STRAP
 AROUND INNER CORE OF FLEX. USE METAL BAND
- CLAMP WHERE REQUIRED BY LOCAL AUTHORITY.

 PULL FLEX INSULATION AND OUTER COVER DOWN OVER GRILLE COLLAR AND SECURE TO GRILLE WITH TAPE ONLY. DO NOT USE STRAP OR
- OTHER METHOD WHICH WILL COMPRESS INSULATION.

 STRETCH FLEX TIGHT BETWEEN DUCT AND DIFFUSER
 TO AVOID KINKS. SUPPORT EVERY FOUR FEET
 WITH 2" STEEL STRAP OR OTHER APPROVED HANGER.

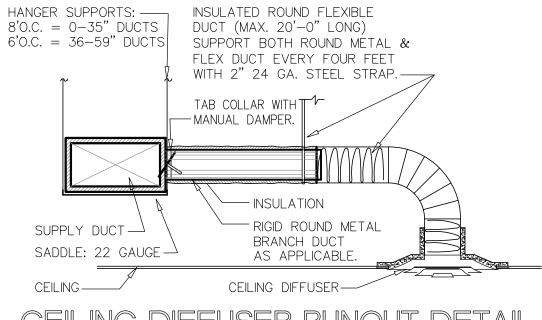

CEILING DIFFUSER RUNOUT DETAIL

NOT TO SCALE

— HANGER SUPPORTS SHALL BE AS NOTED ABOVE FOR DUCT WIDTHS UP
TO 24" AND WITH TRAPEZE HANGERS FOR DUCTS 25" AND ABOVE.

AIR HANDLE	ER SCHE	
MARK	AHU-1	AHU-2
MANUFACTURER	CARRIER	CARRIER
MODEL NUMBER	FB4CPNC060	FB4CPNC060
TOTAL COOLING	60,000	60,000
SENSIBLE COOLING	39,125	39,125
SUPPLY CFM	2000	2000
OUTSIDE AIR CFM	175	175
EXTERNAL S.P. (IN W.G.)	.6"	.6"
FAN R.P.M.	1725	1725
MOTOR HORSEPOWER	3/4	3/4
FAN MOTOR F.L.A.	5.6	5.6
ENTERING AIR TEMPERATURE	78/67	78/67
LEAVING AIR TEMPERATURE	55.6/54.8	55.6/54.8
ELECTRIC HEAT KW / STEPS	7.5 - 1 - 208V. 1P.	. 7.5 - 1 - 208V. 1P.
FILTER TYPE	MERV 8	MERV 8
FILTER THICKNESS	1"	1"
ELECTRICAL VOLTS / PHASE	208/230 V., 1 PH	208/230 V., 1 PH.
WEIGHT	207	207
LOCATION	MECH. CLOSET	MECH. CLOSET
NOTES	1,2,3,5,6	1,2,3,5,6

CONDENSING	UNIT SCH	EDULE
MARK	CU-1	CU-2
MANUFACTURER	CARRIER	CARRIER
MODEL NUMBER	24ACC460A0030	24ACC460A0030
CAPACITY IN TONS	5.0	5.0
E.E.R. / S.E.E.R.	14.0	14.0
COMPRESSOR(S) / R.L.A.	1 - 20.8	1 - 20.8
CONDENSER FAN - NO. / H.P. / F.L.A.	1 - 1/4 - 1.52	1 - 1/4 - 1.52
ELECRICAL VOLTS / PHASE	208/230V. 1 PH.	208/230V. 1 PH.
MIN. CIRCUIT AMPS.	27.5	27.5
MAX FUSE / M.O.C.P.	40	40
WEIGHT	239	239
LOCATION	WEST EQUIP. PAD	WEST EQUIP. PAD
NOTES	1,2,4	1,2,4

- NOTES: 1. HVAC CONTRACTOR COORDINATE ELECTRICAL DATA WITH ELECTRICAL CONTRACTOR PRIOR TO ORDER OF EQUIPMENT.
 - 2. UNIT SHALL HAVE A SINGLE POINT ELECTRICAL CONNECTION.

 3. PROVIDE TXV'S AND LOW AND HIGH PRESSURE SWITCHES
 - 3. PROVIDE TXV'S AND LOW AND HIGH PRESSURE SWITCHES.
 4. PROVIDE LIQUID LINE FILTER—DRYERS.
 - 5. PROVIDE FACTORY 7-DAY PROGRAMMABLE THERMOSTAT.
 - 6. INSTALL FILTERS IN AIR HANDLER PRIOR TO START UP AND PROVIDE NEW SET OF FILTERS AT COMPLETION OF CONSTRUCTION.


4	AIR DISTRIBUTION SCHEDULE											
N	MARK	MANUFACTURER	MODEL NUMBER	SIZE	CFM	NECK	LOCATION	MATERIAL	NOTES:			
	Α	PRICE	ACVD	12 X 12	SEE PLAN	12 X 12	CEILING	ALUMINUM	1,2,4,5			
	В	PRICE	630	24 X 24	SEE PLAN	24 X 24	SEE PLAN	ALUMINUM	1,2,3			
	С	PRICE	620	12 X 8	SEE PLAN	12 X 8	SIDEWALL	ALUMINUM	1,2,4,6			

SIZE THROW CFM NECK/FLEX CONNECTION SIZE

2. DIFFUSER FINISH SHALL BE OFF-WHITE.
3. PATTERN SHALL BE 45 DEGREE FIXED BLADE, 3/4" SPACING.
4. PROVIDE PRE-FAB R-6 INSULATED GRILLE BOX WITH TAB COLLAR.
5. GRILLE FACE SHALL BE ADJUSTABLE CURVED BLADE. NO STAMPED GRILLES ACCEPTED.
6. GRILLE FACE SHALL BE DOUBLE DEFLECTION TYPE. NO STAMPED GRILLES ACCEPTED.

7. PROVIDE SURFACE MOUNT FRAME FOR INSTALLATION IN GYP CEILING OR SOFFIT.

I. PROVIDE MANUAL VOLUME DAMPER AT MAIN TRUNK FOR BALANCING.

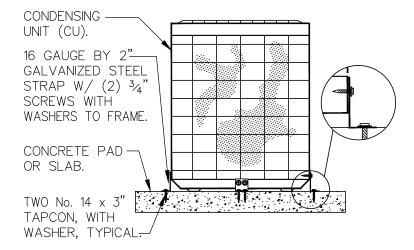

CONDENSER TIE-DOWN DETAIL


NOT TO SCALE

- DETAIL IS PROVIDED FOR FLORIDA 146 MPH WIND


TIE-DOWN COMPLIANCE.

MDCI Florida, Inc.
405 2nd St. S, Suite B, Safety Harbor FL 34695
PH: 727-698-0398
ENGINEERING BUSINESS No. 9204

Garland Patterson, P.E.

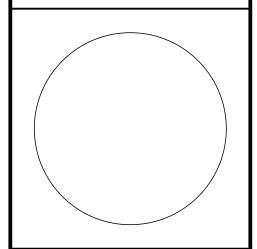

CONSULTANTS

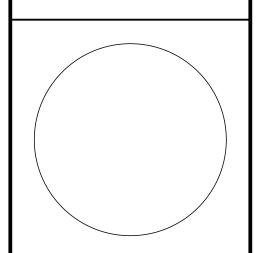

NSTRUCTIONS

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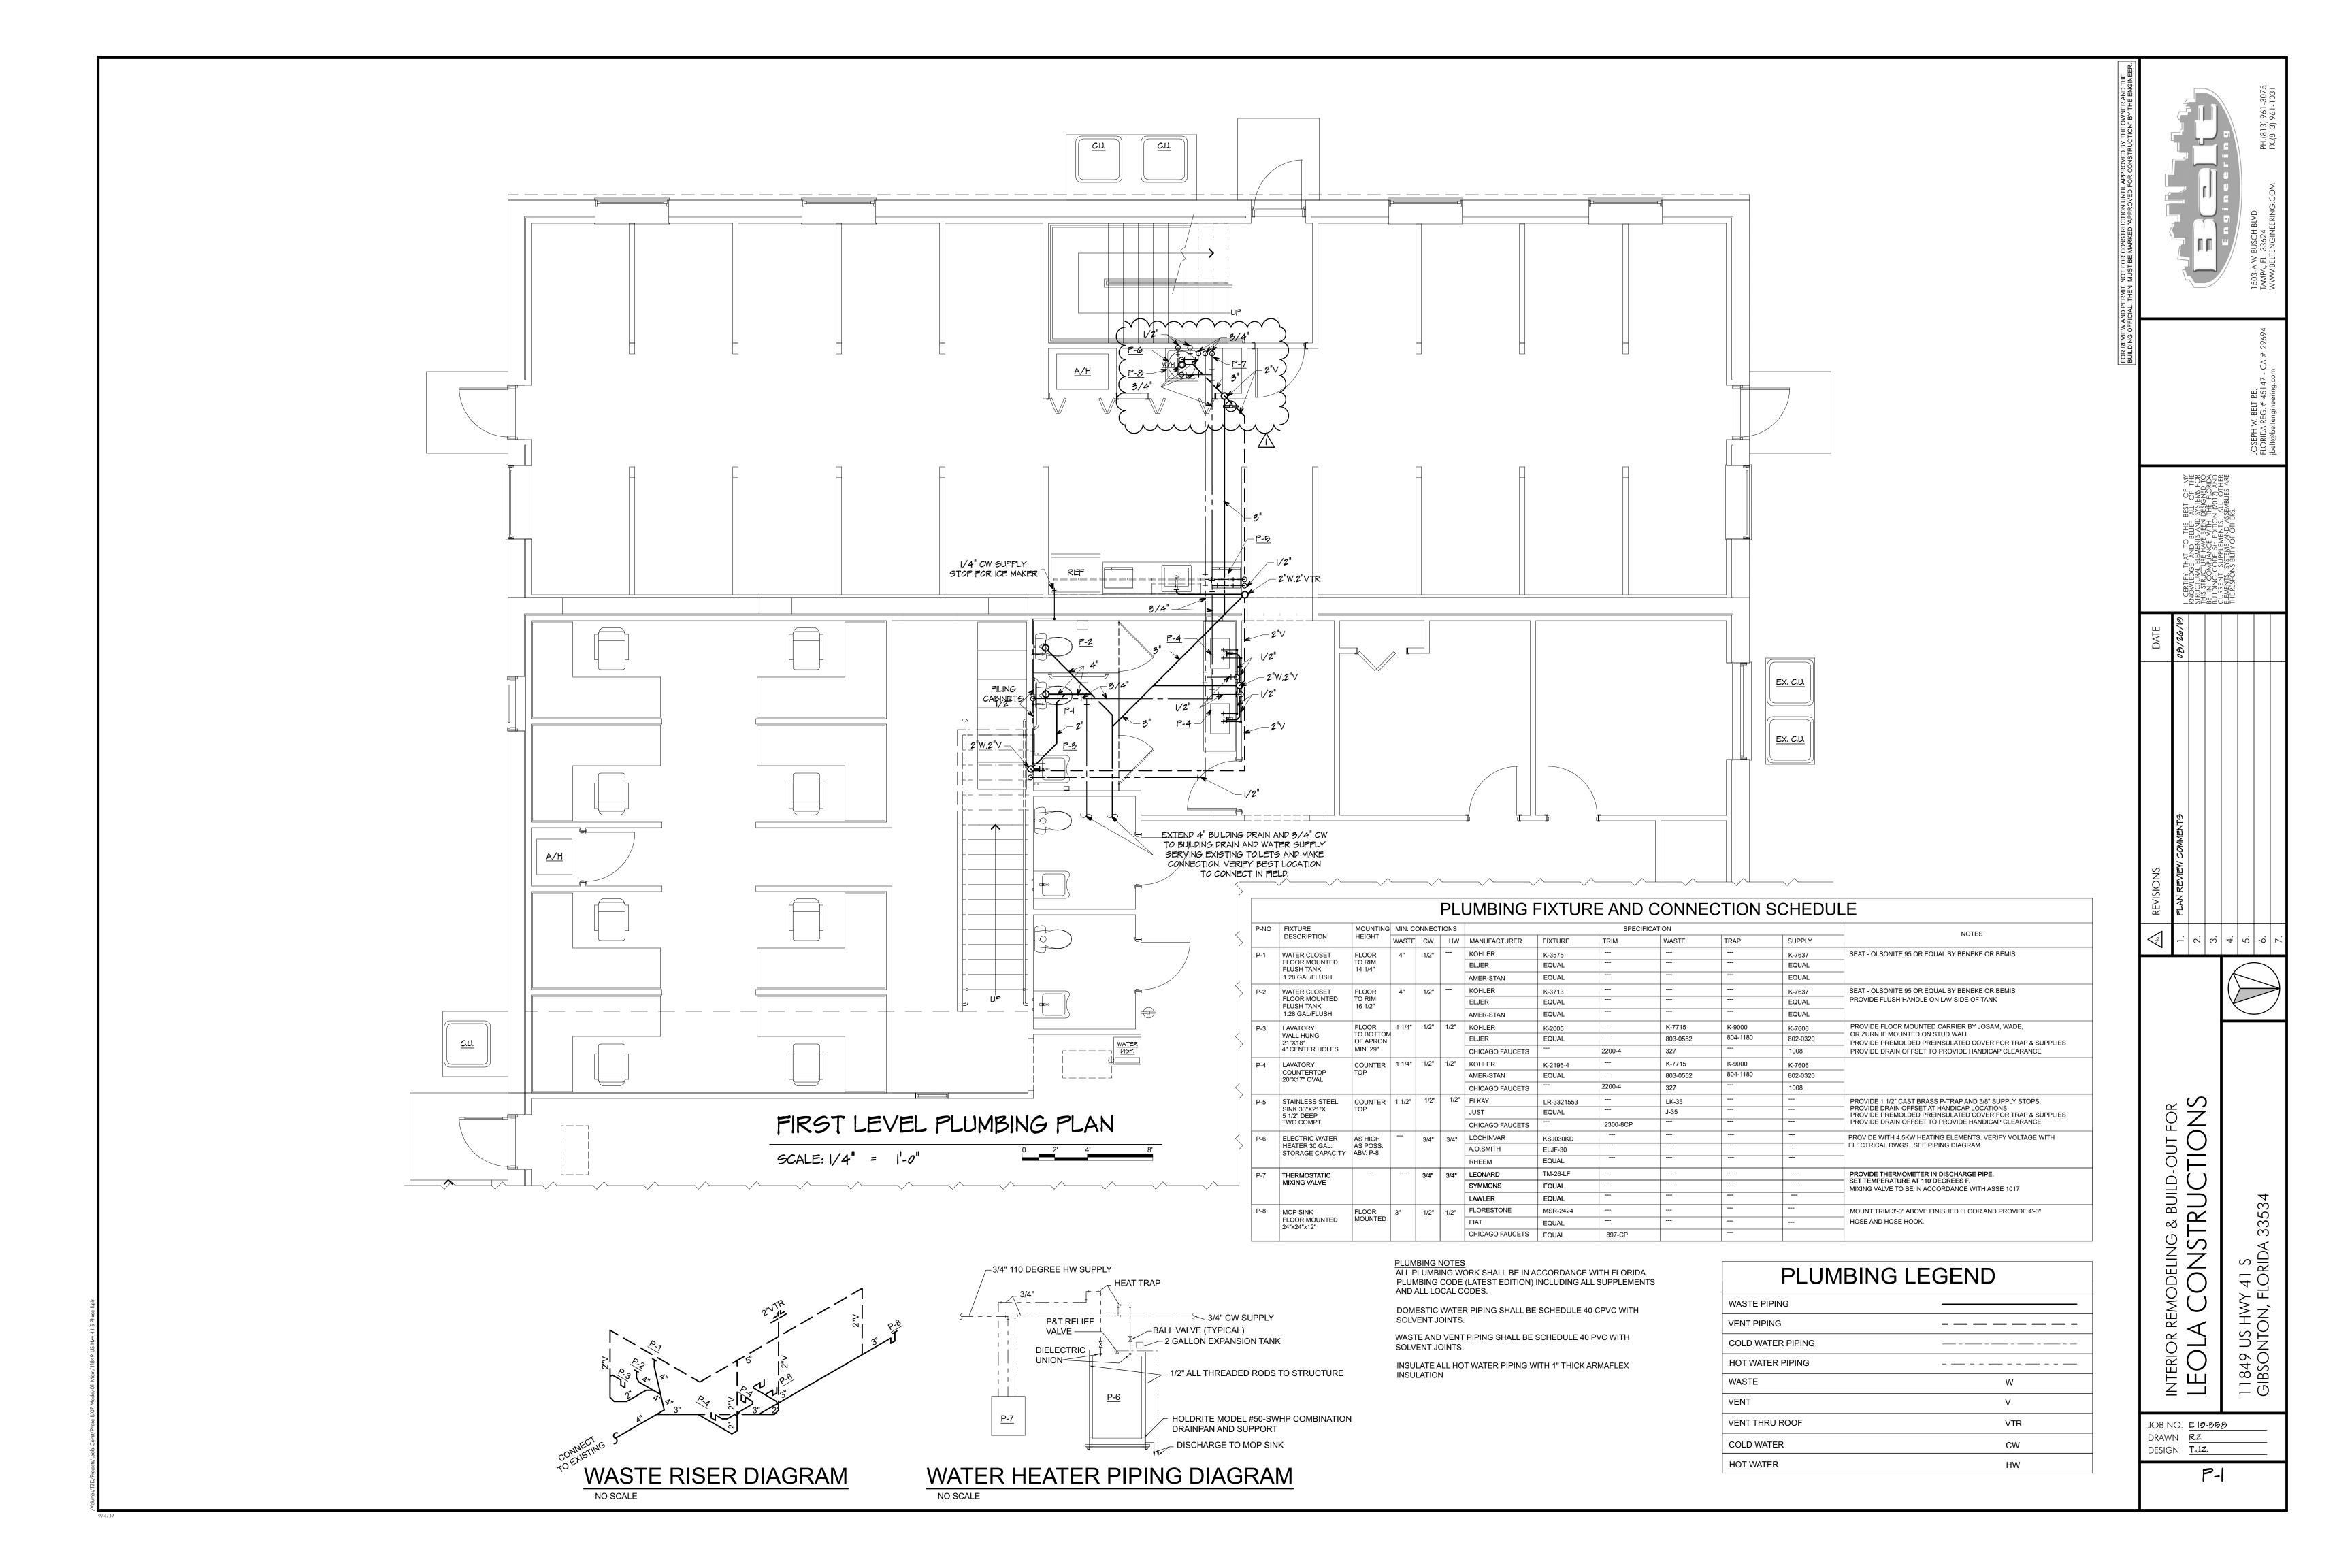
08/26 PLAN REVIEW COMMENTS

MARK DATE REVISION

DATE OF ISSUE: 08/07/2019
PROJECT No.: 10-033
DRAWN BY: R.Z
CHECKED BY: T.F
COPYRIGHT:

MECHANICAL
NOTES, DETAILS

M-2




DESIGN CRITERIA:

BASIS OF DESIGN


ALL CONSTRUCTION IS DESIGNED AS FOLLOWS
SIXTH EDITION 2017 FLORIDA BUILDING CODE
FLOOR DEAD LOAD - 15 PSF
FLOOR LIVE LOAD = 50 PSF

STRENGTH OF MATERIALS

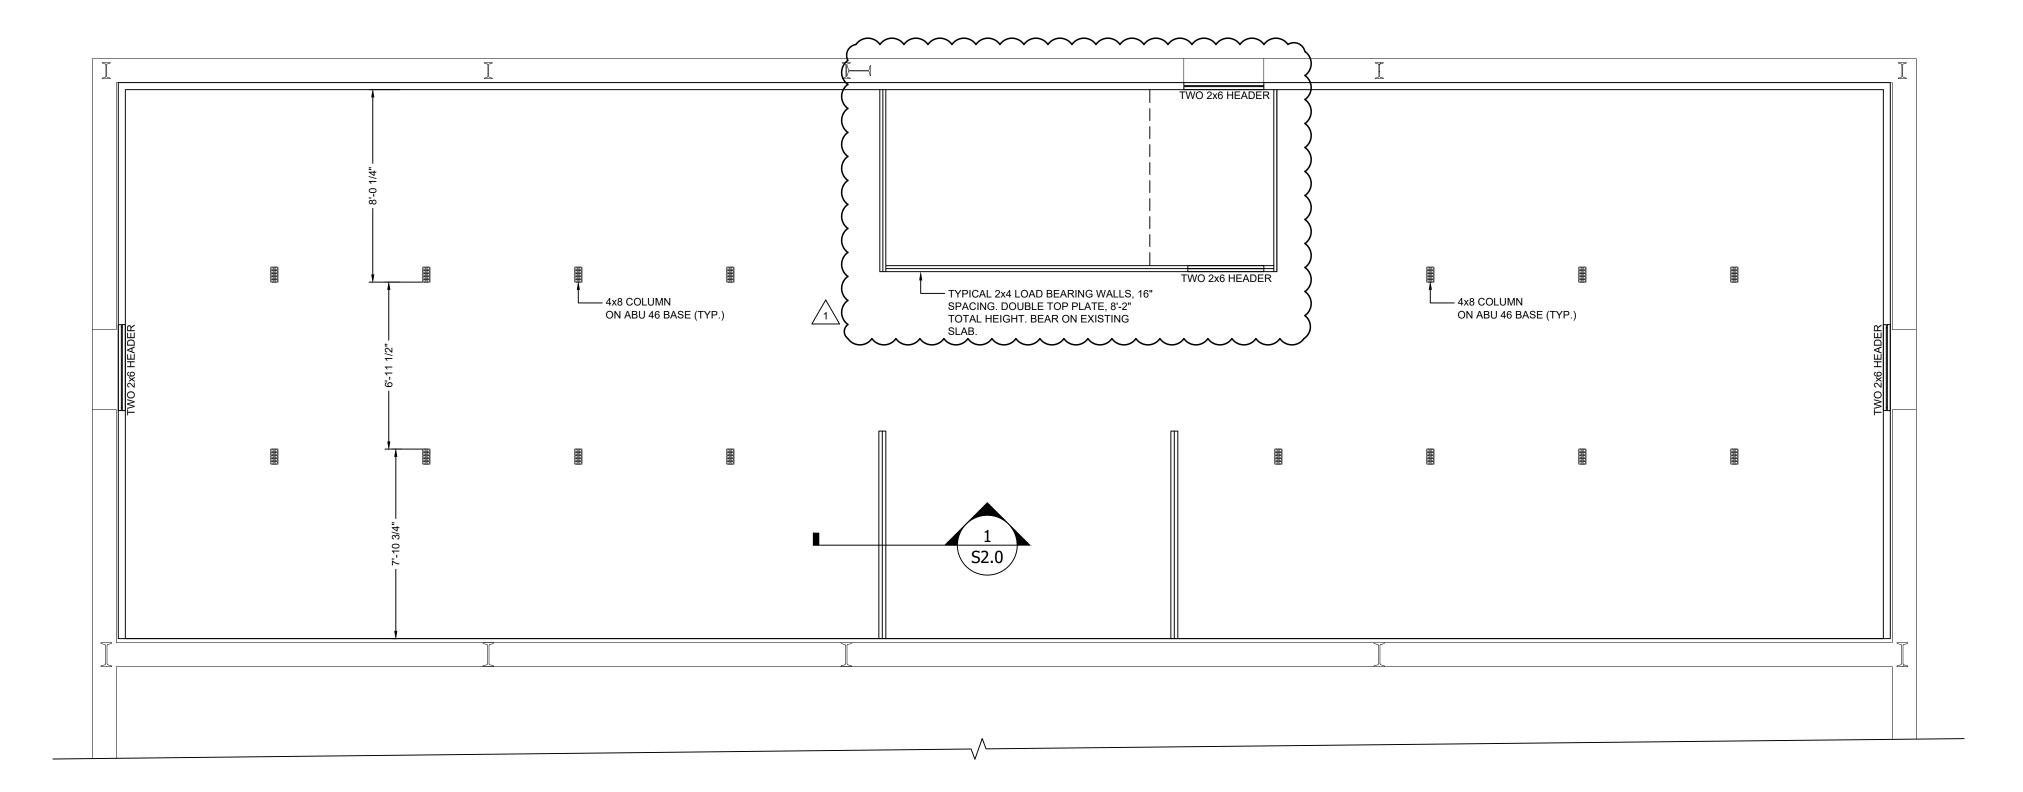

FIRST LEVEL BEARING WALL PLAN

SCALE: 1/4" = 1'-0"

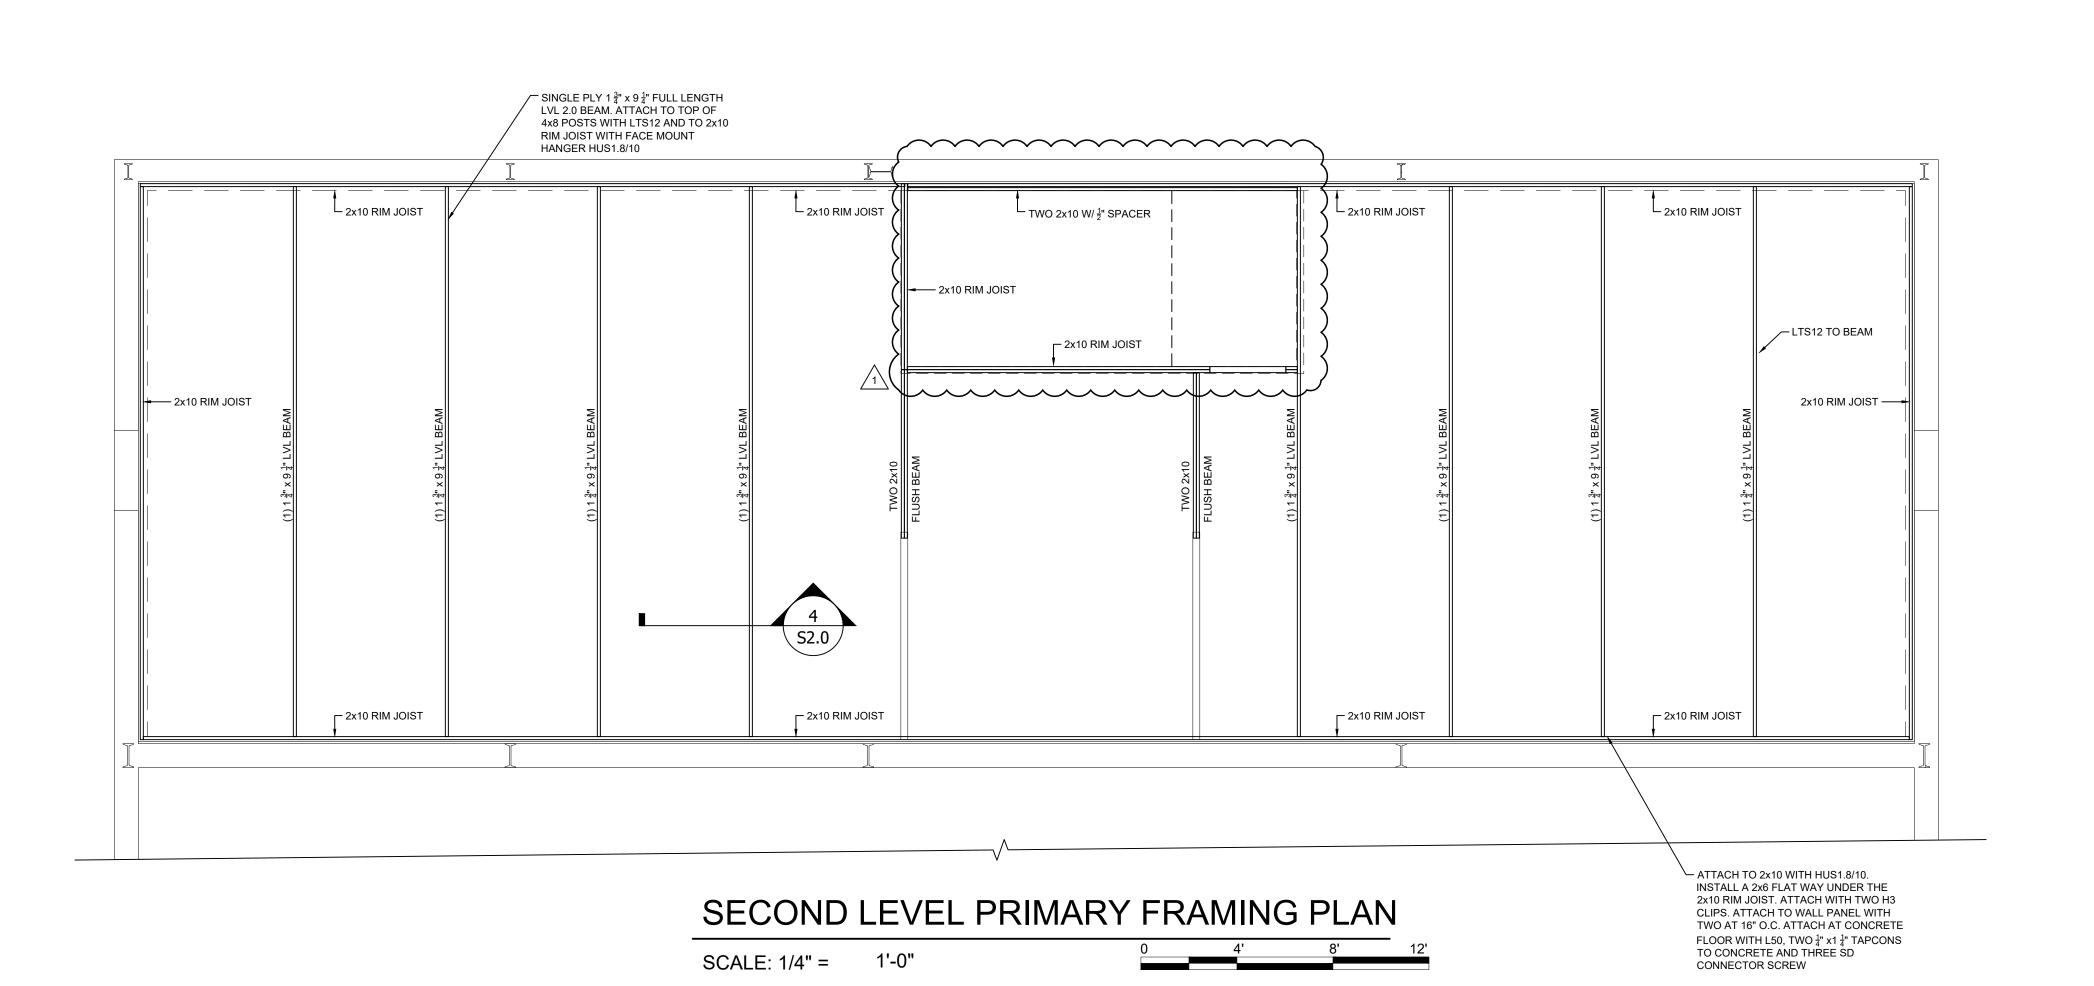

1503-A WEST BUSCH BLVD.

PH.(813) 961-3075

TAMAD. El. 23643

FX.(813) 961-3075

MMPLIANCE OUT. ALL STEMS AND THE E BUILDER. JOSEPH W. BELT P.E. #45147 jbelt@beltengineering.com

MY KNOWLEDGE AND BELIEF ALOF THE STRUCTURAL ELEMENT AND SYSTEMS FOR THIS STRUCTURE HAVE BEEN DESIGNED TO BE IN COMPLIANC WITH THE FLORIDA BUILDING CODE 6TH EDITION 2017. ALL OTHER ELEMENTS, SYSTEMS AT ASSEMBLIES ARE THE RESPONSIBILITY OF THE BUILDE

REVIEW COMMENTS 08.29

DECK FRAMING FOR LEOLA CONSTRUCTIONS 11849 US HWY 418 GIBSONTON, FLORIDA 33534

JOB NO. <u>E19-358</u>
DATE <u>07/02/2019</u>
DRAWN <u>JWB</u>


DRAWN JWB
DESIGN JWB

BASIS OF DESIGN

& PLAN VIEWS

S1.0

FOR REVIEW AND PERMIT. NOT FOR CONSTRUCTION UNTIL APPROVED BY THE OWNER AND THE BUILDING OFFICIAL. THEN MUST BE MARKED "APPROVED FOR CONSTRUCTION" BY THE ENGINEER.

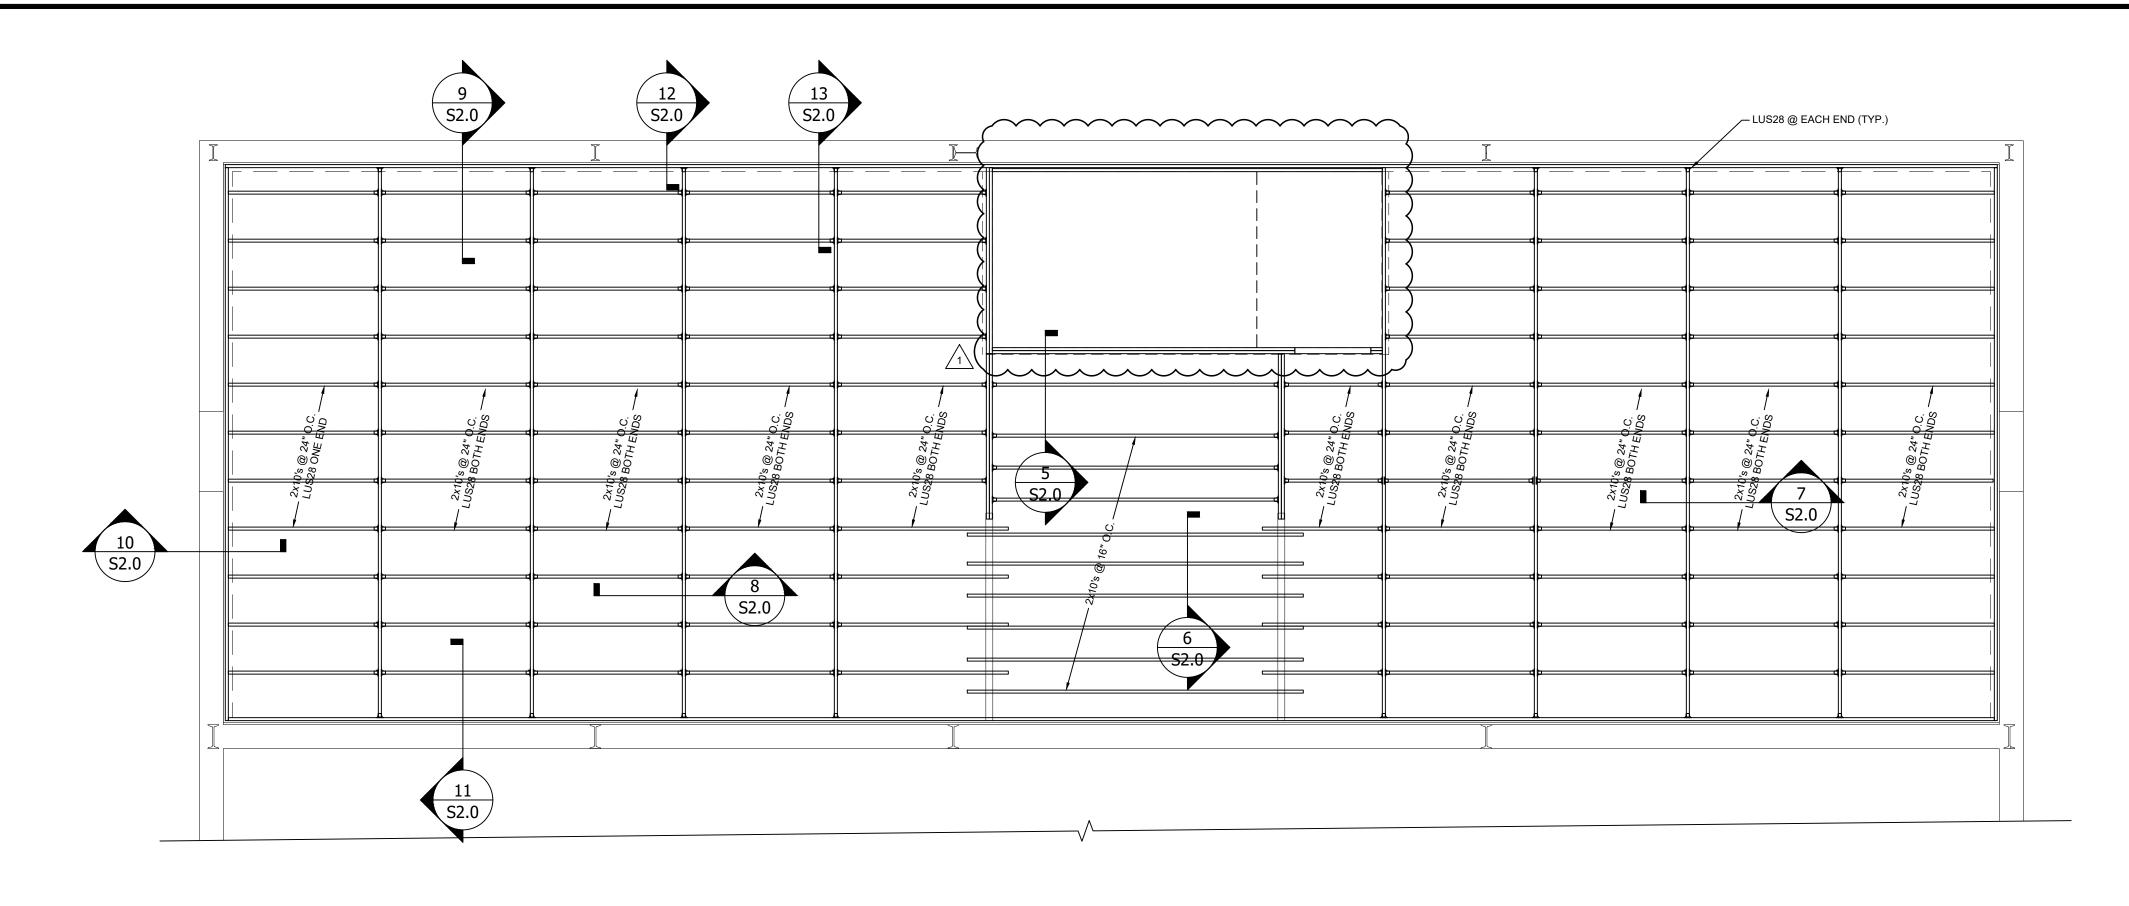

SECOND LEVEL SECONDARY FRAMING PLAN

SCALE: 1/4" = 1'-0"

FOR A WEST BLISCH BLVD.

PH.(813) 961-3075

JOSEPH W. BELT P.E. #45147 jbelt@beltengineering.com

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PLAN REVIEW COMMENTS


K FRAMING FOR A CONSTRUCTIONS SHWY 418

JOB NO. <u>E19-358</u>
DATE <u>07/02/2019</u>
DRAWN <u>JWB</u>
DESIGN <u>JWB</u>

PLAN VIEWS

S1.1

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FRAMING CONSTRU(VY 418 , FLORIDA 33534 JOB NO. <u>E19-358</u> DATE <u>07/02/2019</u> DRAWN JWB DESIGN <u>JWB</u>
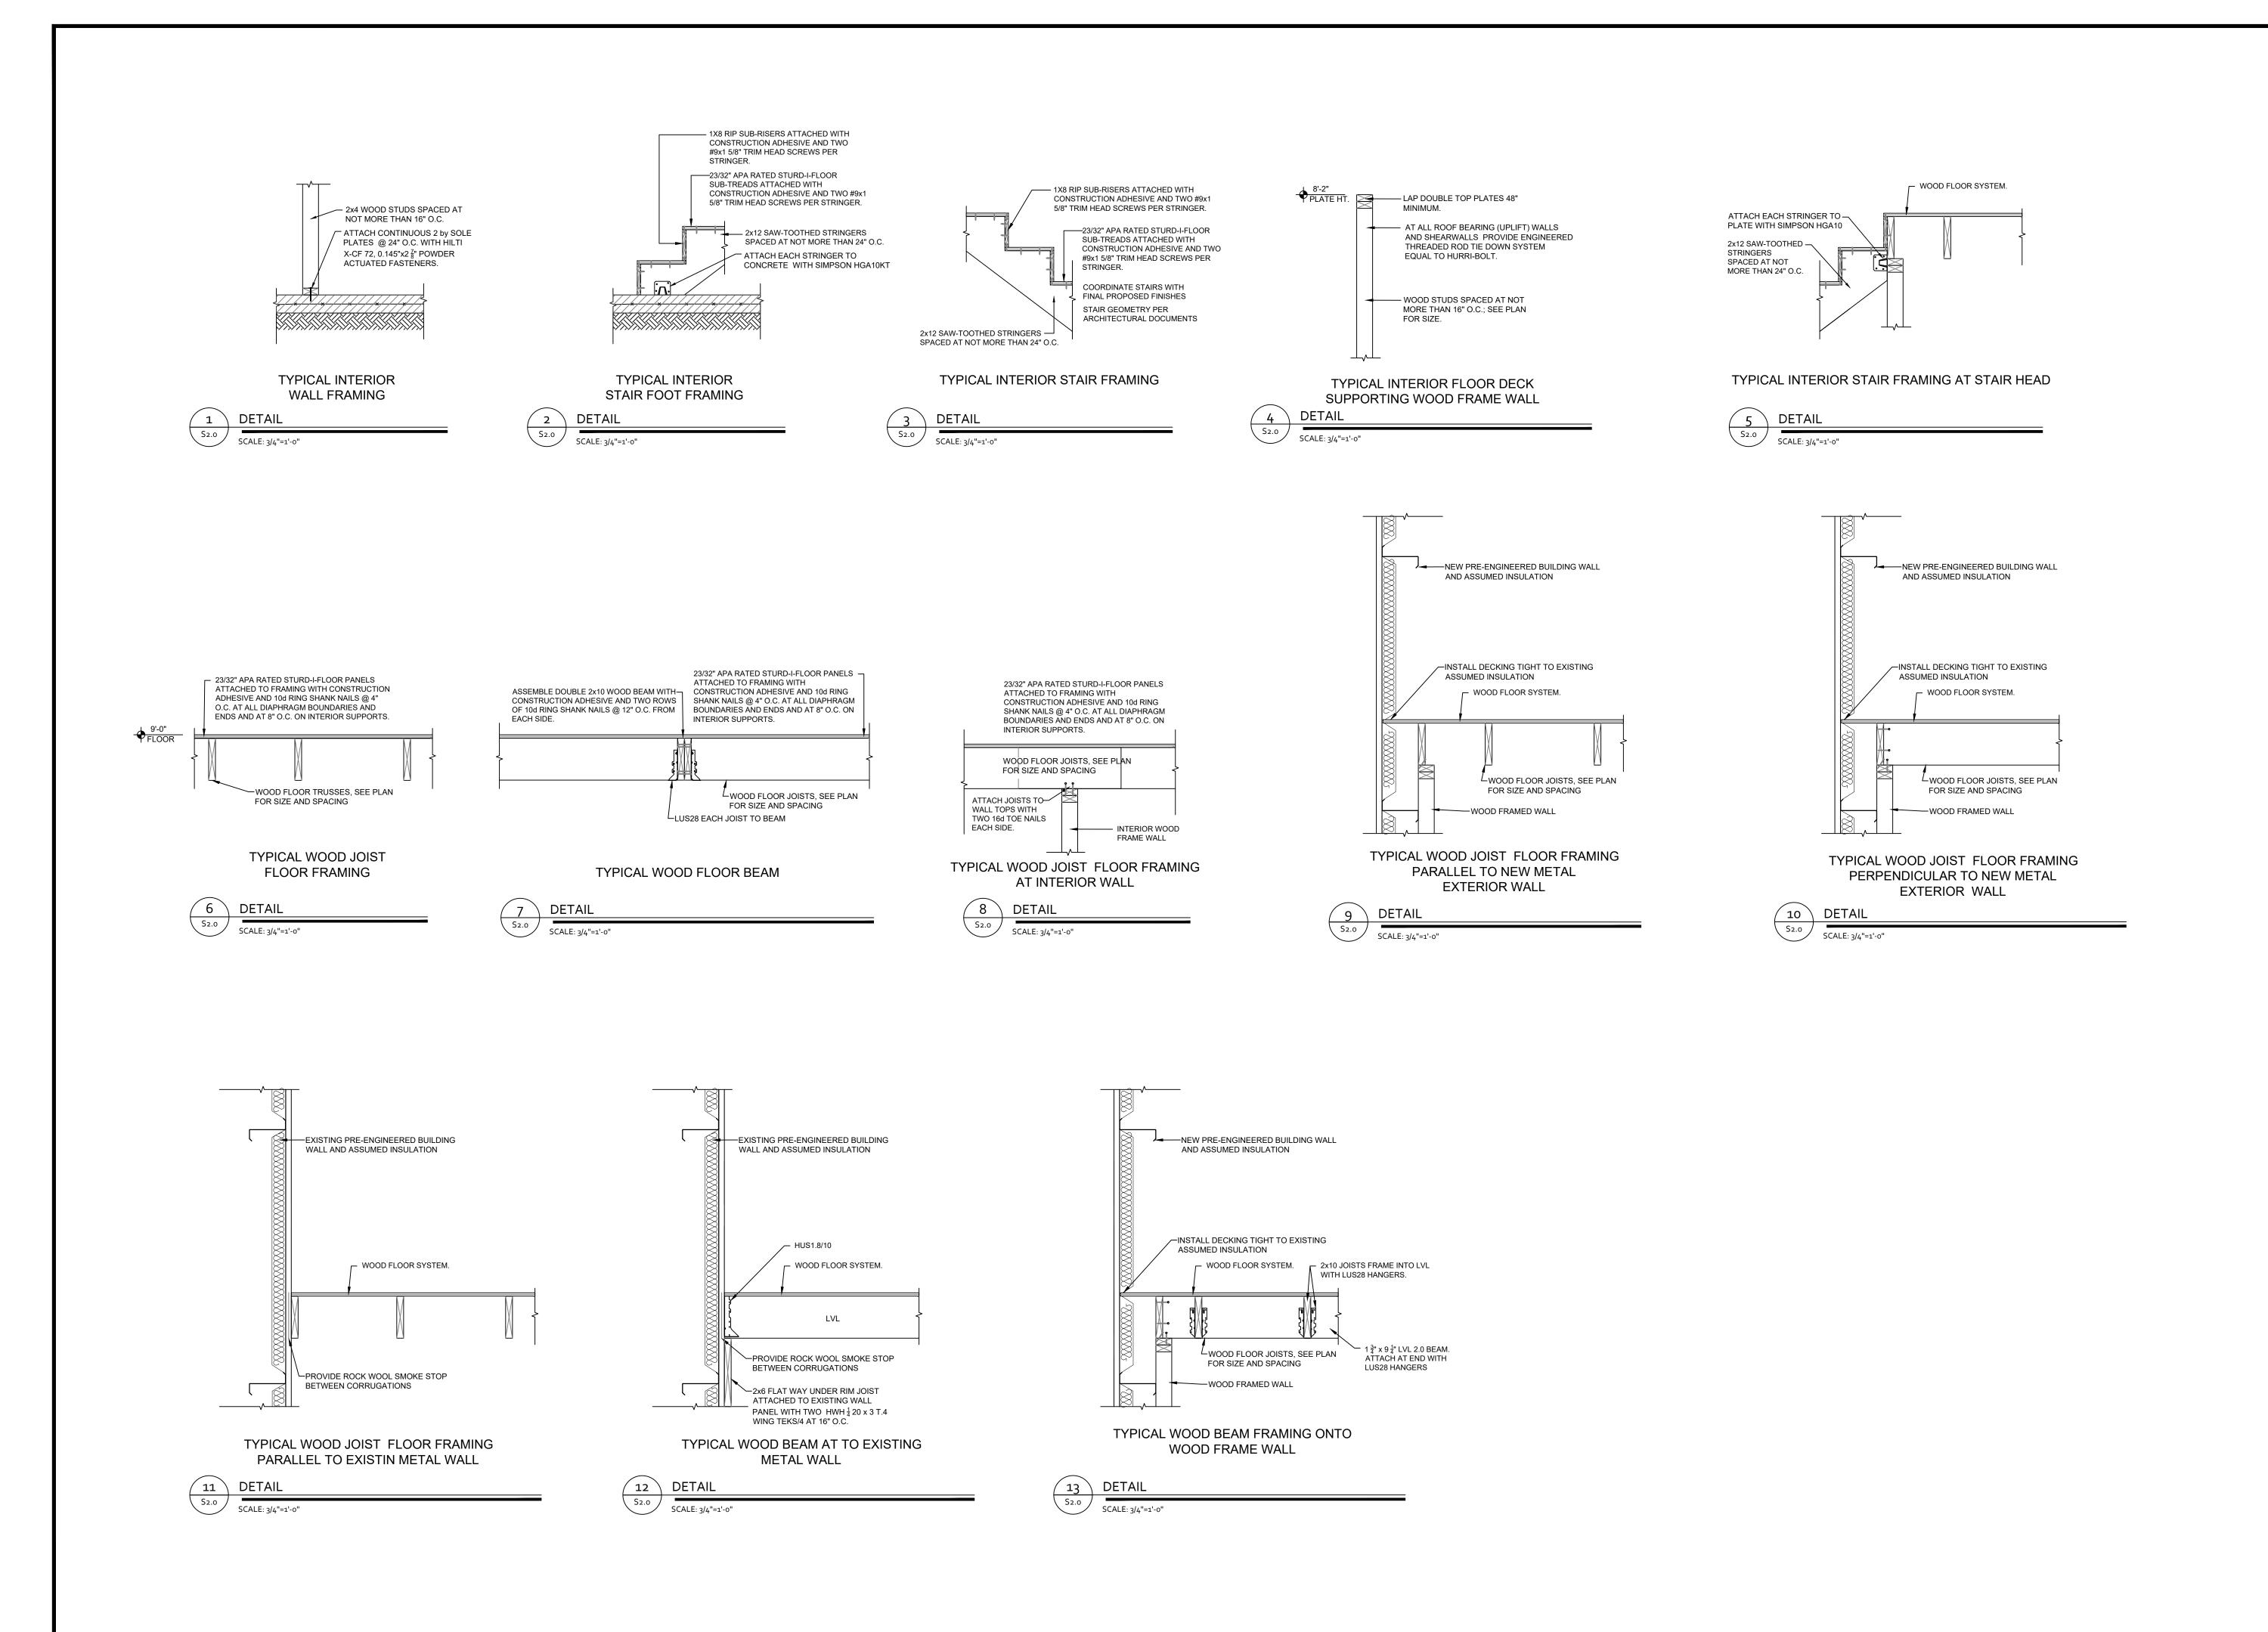
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S2.0

SECTIONS & DETAILS